PROJECT:

# JLTC- BUILDING #2

UTAH NATIONAL GUARD, JOINT LANGUAGE TRAINING CENTER

CAMP WILLIAMS, UTAH

## CONSTRUCTION DOCUMENTS - APRIL 21, 2005

DFCM PROJECT NO. 05006480



State of Utah-Department of Administrative Services

## DIVISION OF FACILITIES CONSTRUCTION AND MANAGEMENT

4110 State Office Building/Salt Lake City, Utah 84114/538-3018

### APPROVALS:

PRIME AGENCY	DAT
DFCM	DAT

## PROJECT TEAM

ARCHITECT

## JSA ARCHITECTS, LLC

3115 LION LANE SUITE 300 SALT LAKE CITY, UTAH 84121 (801) 278-8151 FAX (801) 278-8661 CONTACT: CHRISTOPHER JENSEN, AIA

STRUCTURAL ENGINEEER

## **DEMITA ENGINEERING**

1474 E. EDGECLIFF DR. SANDY, UTAH 84092 PHONE: (801) 571-6332 FAX: (801) 571-6339 CONTACT: TONY DEMITA P.E.

ELECTRICAL ENGINEER

### ECE CONSULTING ENGINEERS

939 SO, WEST TEMPLE SALT LAKE CITY, UTAH 84101 PHONE: (801) 521-8007 FAX: (801) 521-8057 CONTACT: DARRIN SANDERS P.E.

MECHANICAL ENGINEER

## PVE INC.

90 SO, 400 WE, SUITE 340 SALT LAKE CITY, UTAH 84101 PHONE: (801) 359-3158 FAX: (801) 521-4114 CONTACT: ALAN SPENDLOVE P.E.

## PROJECT INFORMATION

GOVERNING CODE: 2003 INTERNATIONAL BUILDING CODE (I.B.C.) OCCUPANCY GROUP: B BUILDING TYPE: VB

OVER ALL SQUARE FOOTAGE: 1,600 SQ. FT. SEISMIC ZONE: SEE SHEET 5-001 SEE G-002 FOR ADDITIONAL INFORMATION

CIVIL ENGINEER

TWIN PEAKS

1880 NO. 800 EA.

LEHİ, UTAH 84043


PHONE: (801) 450-3511

CONTACT: SCOTT CARLSEN P.E.

APPROVALS:

PRIME AGENCY	DATE
DFCM	DATE

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VICINITY MAP

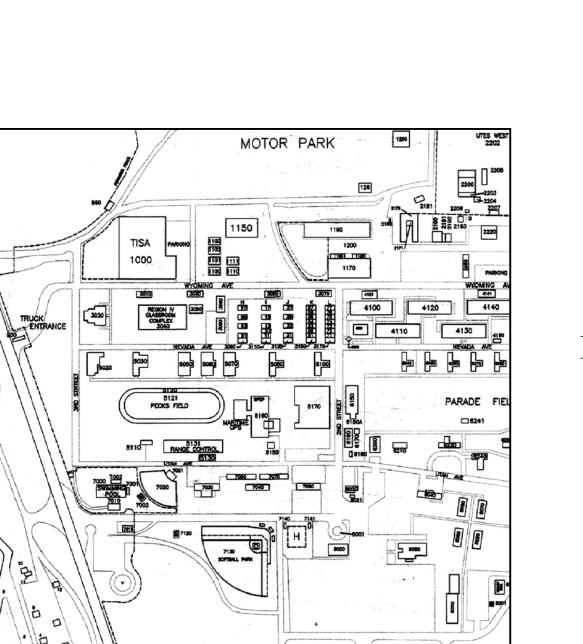G001

- NEW JLTC BUILDING \*2 LOCATION

3115 e. lion lane suite 300 salt lake city utah 84121 801. 278. 8151 fax 801. 278. 8661

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CONSULTANTS:

**BUILDING NAME:** 

## **UTAH NATIONAL GUARD**

PROJECT TITLE:

BUILDING #2

## CAMP WILLIAMS DRAPER, UT

MAKK	DATE	DESCRIPTION
	5/17/05	ADDENDA #1
2	5/19/05	ADDENDA #2
3	6/3/05	ADDENDA #3

ISSUE TYPE: STATE REVIEW SE

ISSUE DATE: APRIL 21, 2005

DFCM PROJECT NO: 05006480 CAD PROJECT NO: 0516 CAD DWG FILE: DRAWN BY: MLJ CHK'D BY: CJ

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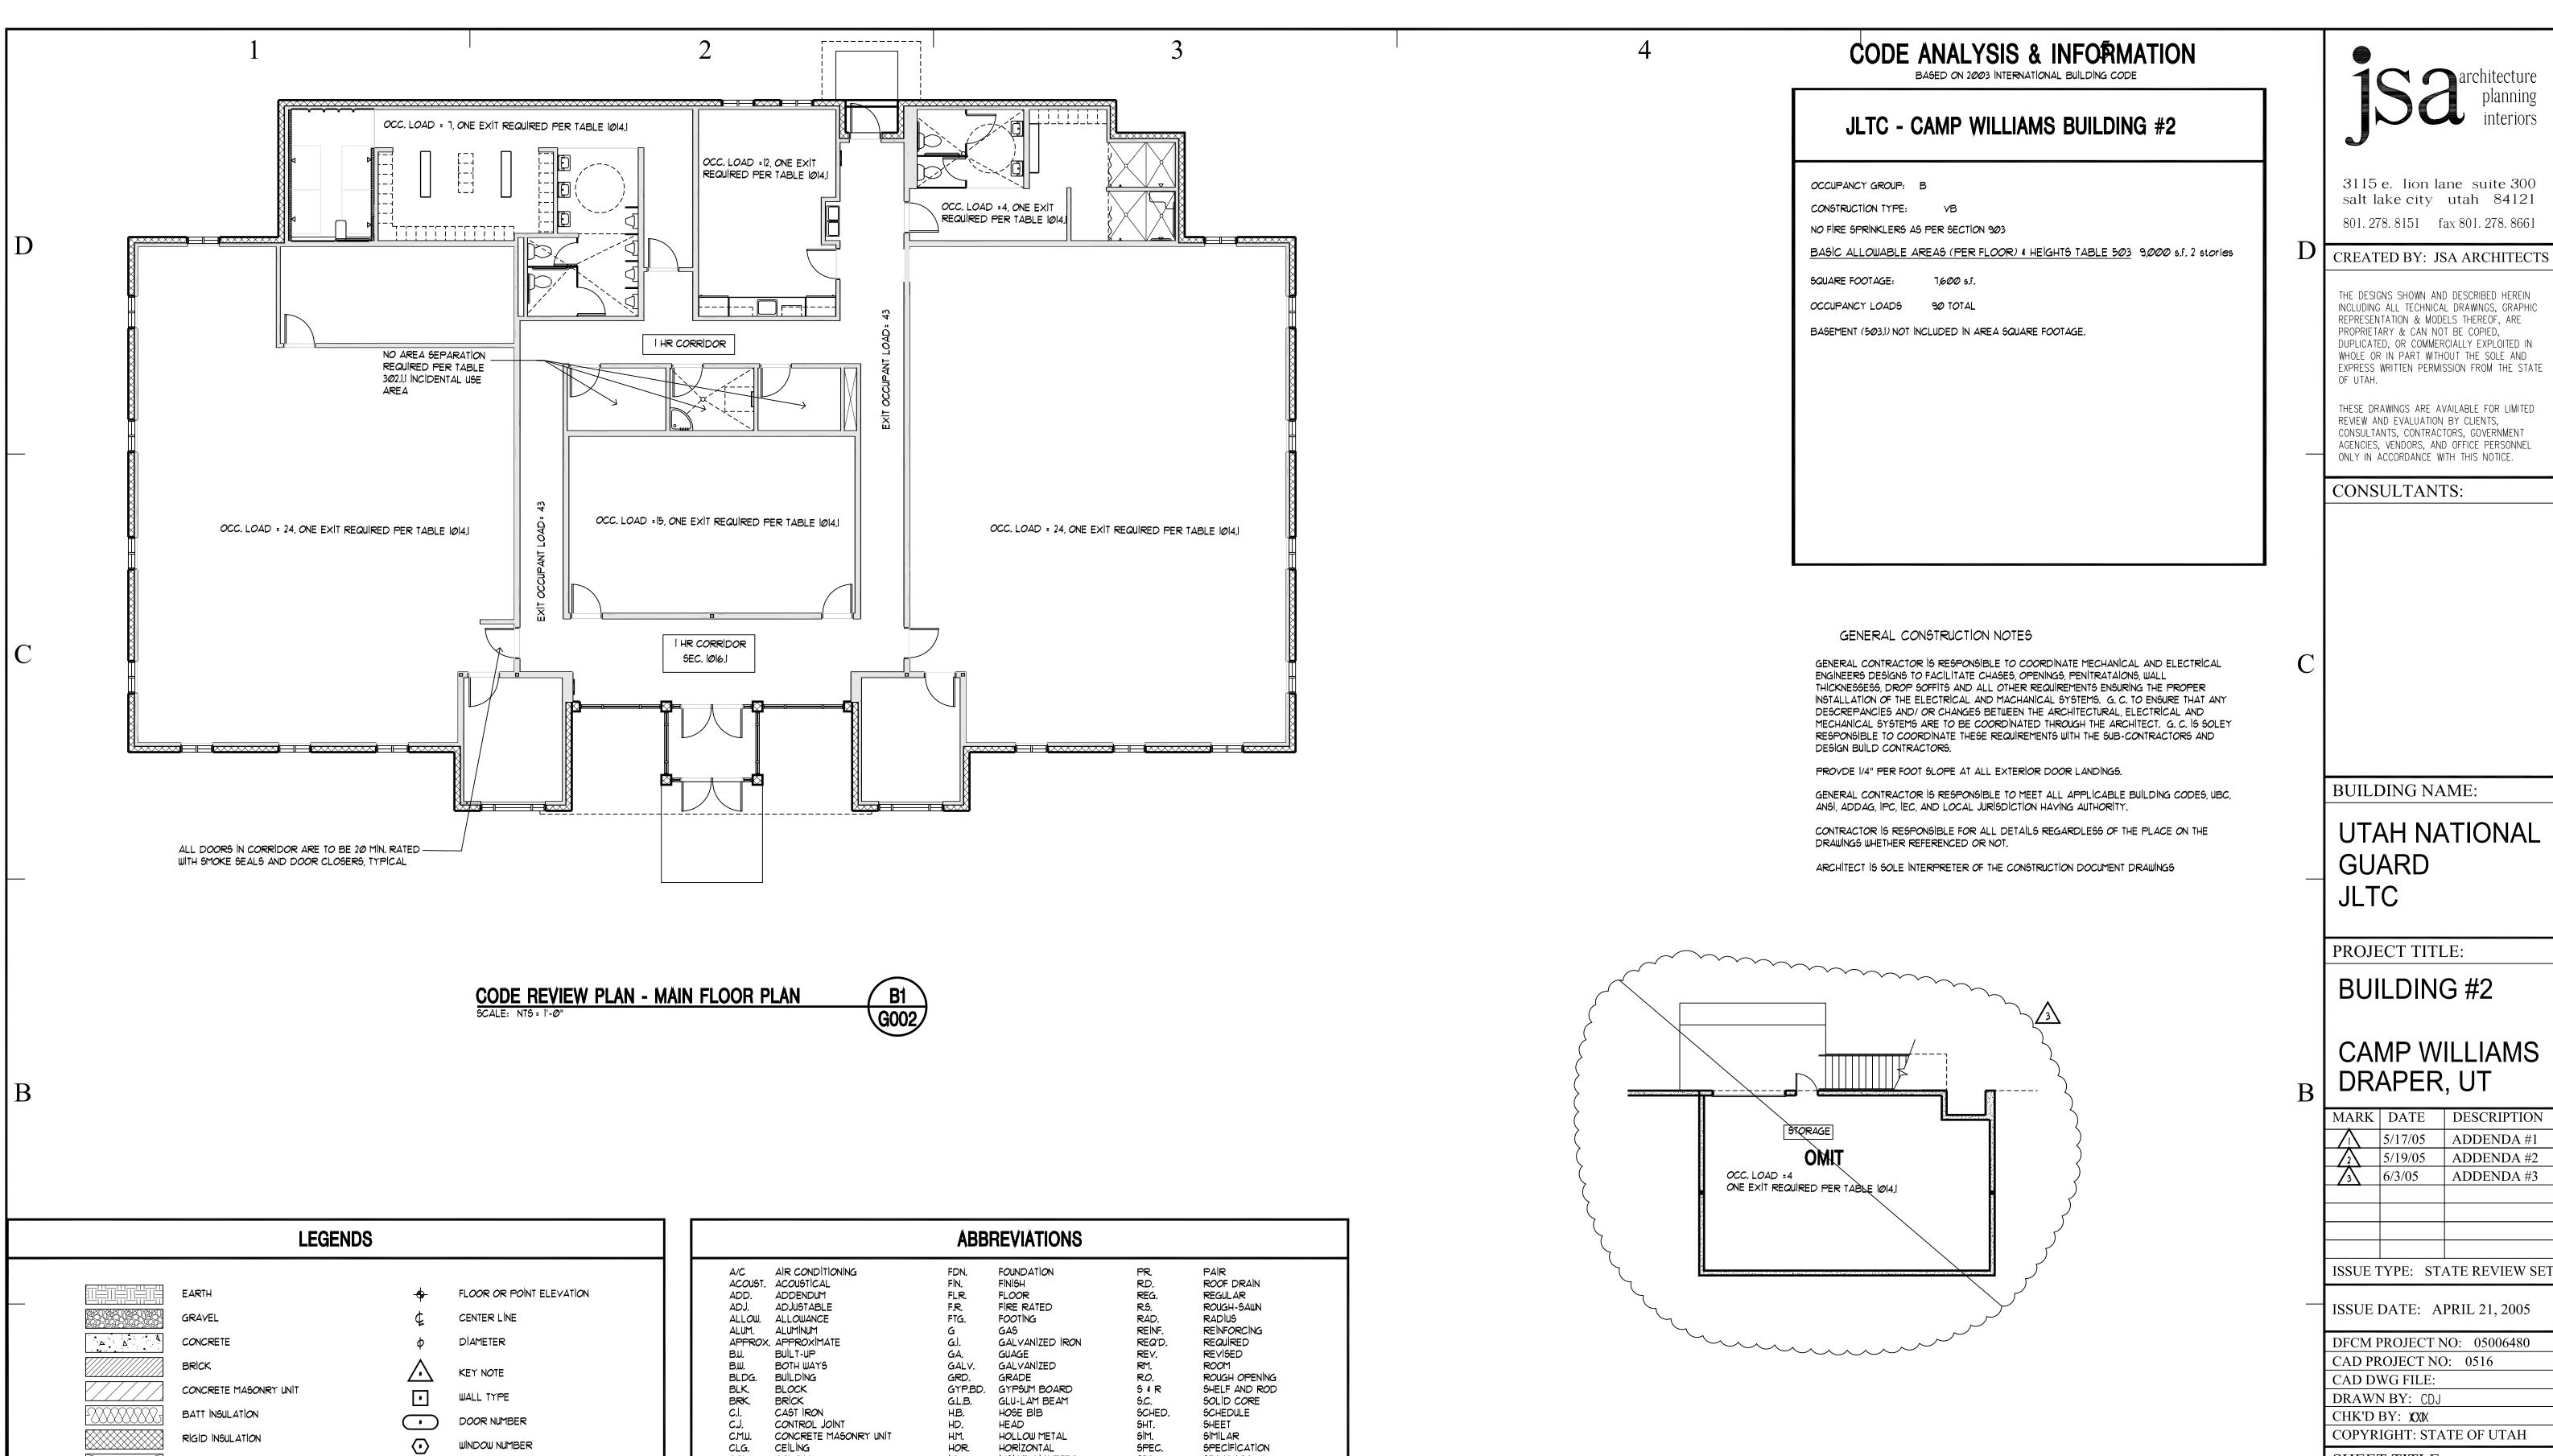
SHEET TITLE

COVER SHEET

SHEET NUMBER

SHEET **001** OF 055





ROUGH WOOD FRAMING FİXTURE TAG FÌNÌSH WOOD PLYW00D SAND, MORTAR, GYPSUM BOARD BUILDING OR WALL ELEVATION WOOD BLOCKING WALL SECTION ALUMINUM (LARGE SCALE) STEEL (LARGE SCALE) BUILDING SECTION STEEL (SMALL SCALE) BITUMINOUS PAVING INTERIOR ELEVATION

A/C AIR CONDITIONING	FON		22	DAID
A/C AIR CONDITIONING ACOUST, ACOUSTICAL	FDN. FIN.	FOUNDATION FINISH	PR. RD.	PAIR ROOF DRAIN
ADD, ADDENDUM	FLR.	FLOOR	REG.	REGULAR
ADJ. ADJUSTABLE	F.R.	FIRE RATED	R.S.	ROUGH-SAWN
ALLOW, ALLOWANCE	FTG,	FOOTING	RAD.	RADIUS
ALUM, ALUMINUM	G	GAS	REINF,	REINFORCING
APPROX, APPROXIMATE	ج راء	GALVANÌZED IRON	REQ'D,	REQUIRED
BUL BUILT-UP	GA.	GUAGE	REV.	REVISED
BW. BOTH WAYS	GALV.	GALVANÌZED	RM.	ROOM
BLDG, BUILDING	GRD.	GRADE	RO.	ROUGH OPENING
BLK, BLOCK	GYP.BD.	GYPSUM BOARD	5 4 R	SHELF AND ROD
BRK. BRICK	GLB.	GLU-LAM BEAM	5.C.	SOLID CORE
C.I. CAST IRON	H.B.	HOSE BIB	SCHED.	SCHEDULE
C.J. CONTROL JOINT	HD,	HEAD	SHT,	SHEET
CMU, CONCRETE MASONRY UNIT	нМ.	HOLLOW METAL	SIM,	SIMILAR
CLG. CEILING	HOR.	HORIZONTAL	SPEC.	SPECIFICATION
COL, COLUMN	1.D.	INSIDE DIAMETER	STD.	STANDARD
COMP. COMPACTED/COMPOSITE	INT.	INTERIOR	STL.	STEEL
CONC. CONCRETE	IRRIG.	IRRIGATION	STG,	STORAGE
CONST. CONSTRUCTION	INSUL,	INSULATION	STRUCT,	STRUCTURAL
CONTR. CONTRACTOR	JB.	JAMB	517G,	SYSTEM
CONT. CONTINUOUS	JNT.	JOINT	T 4 B	TOP AND BOTTOM
DF, DRINKING FOUNTAIN	M.R.	MOISTURE RESISTANT	T 4 G	TONGUE AND GROOVE
DÍA, DIAMETER	MANF'R	MANUFACTURER	T.O.	TOP OF
DIM, DIMENSION	MAX,	MAXIMUM	T.O.F.	TOP OF FOOTING
DN. DOWN	MECH,	MECHANICAL	T.O.W.	TOP OF WALL
DUG. DRAWING	MÍN,	MINIMUM	TYP,	TYPICAL
DTL. DETAIL	(N)	NEW	T.S.	STEEL TUBE COLUMN
EA, EACH	N.I.C.	NOT IN CONTRACT	UN.O.	UNLESS NOTED OTHERWISE
EF, EXHAUST FAN	N.T.S.	NOT TO SCALE	VERT.	VERTICAL
E.J. EXPANSION JOINT	O.C.	ON CENTER	W.	WATER
ELEC, ELECTRIC/ELECTRICAL	0.D.	OUTSIDE DIAMETER	WD.	WOOD
ELEV. ELEVATION	OF.D.	OVERFLOW DRAIN	W/	WITH
EQ. EQUAL	OPN'G	OPENING .	WP.	WATERPROOF
(E) EXISTING	PLYWD,	PLYWOOD	W.R.	WATER RESISTANT
EXT, EXTERIOR	PNT,	PAINT	WWF.	WELDED WIRE FABRIC
F.D. FLOOR DRAIN	PNTD,	PAINTED	wwm.	WELDED WIRE MESH

CODE REVIEW PLAN - BASEMENT FLOOR PLAN

SCALE: NTS = 1'-0"

B2

3115 e. lion lane suite 300 salt lake city utah 84121 801. 278. 8151 fax 801. 278. 8661

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# **UTAH NATIONAL**

BUILDING #2

## CAMP WILLIAMS

MARK	DATE	DESCRIPTION
$\triangle$	5/17/05	ADDENDA #1
2	5/19/05	ADDENDA #2
3	6/3/05	ADDENDA #3

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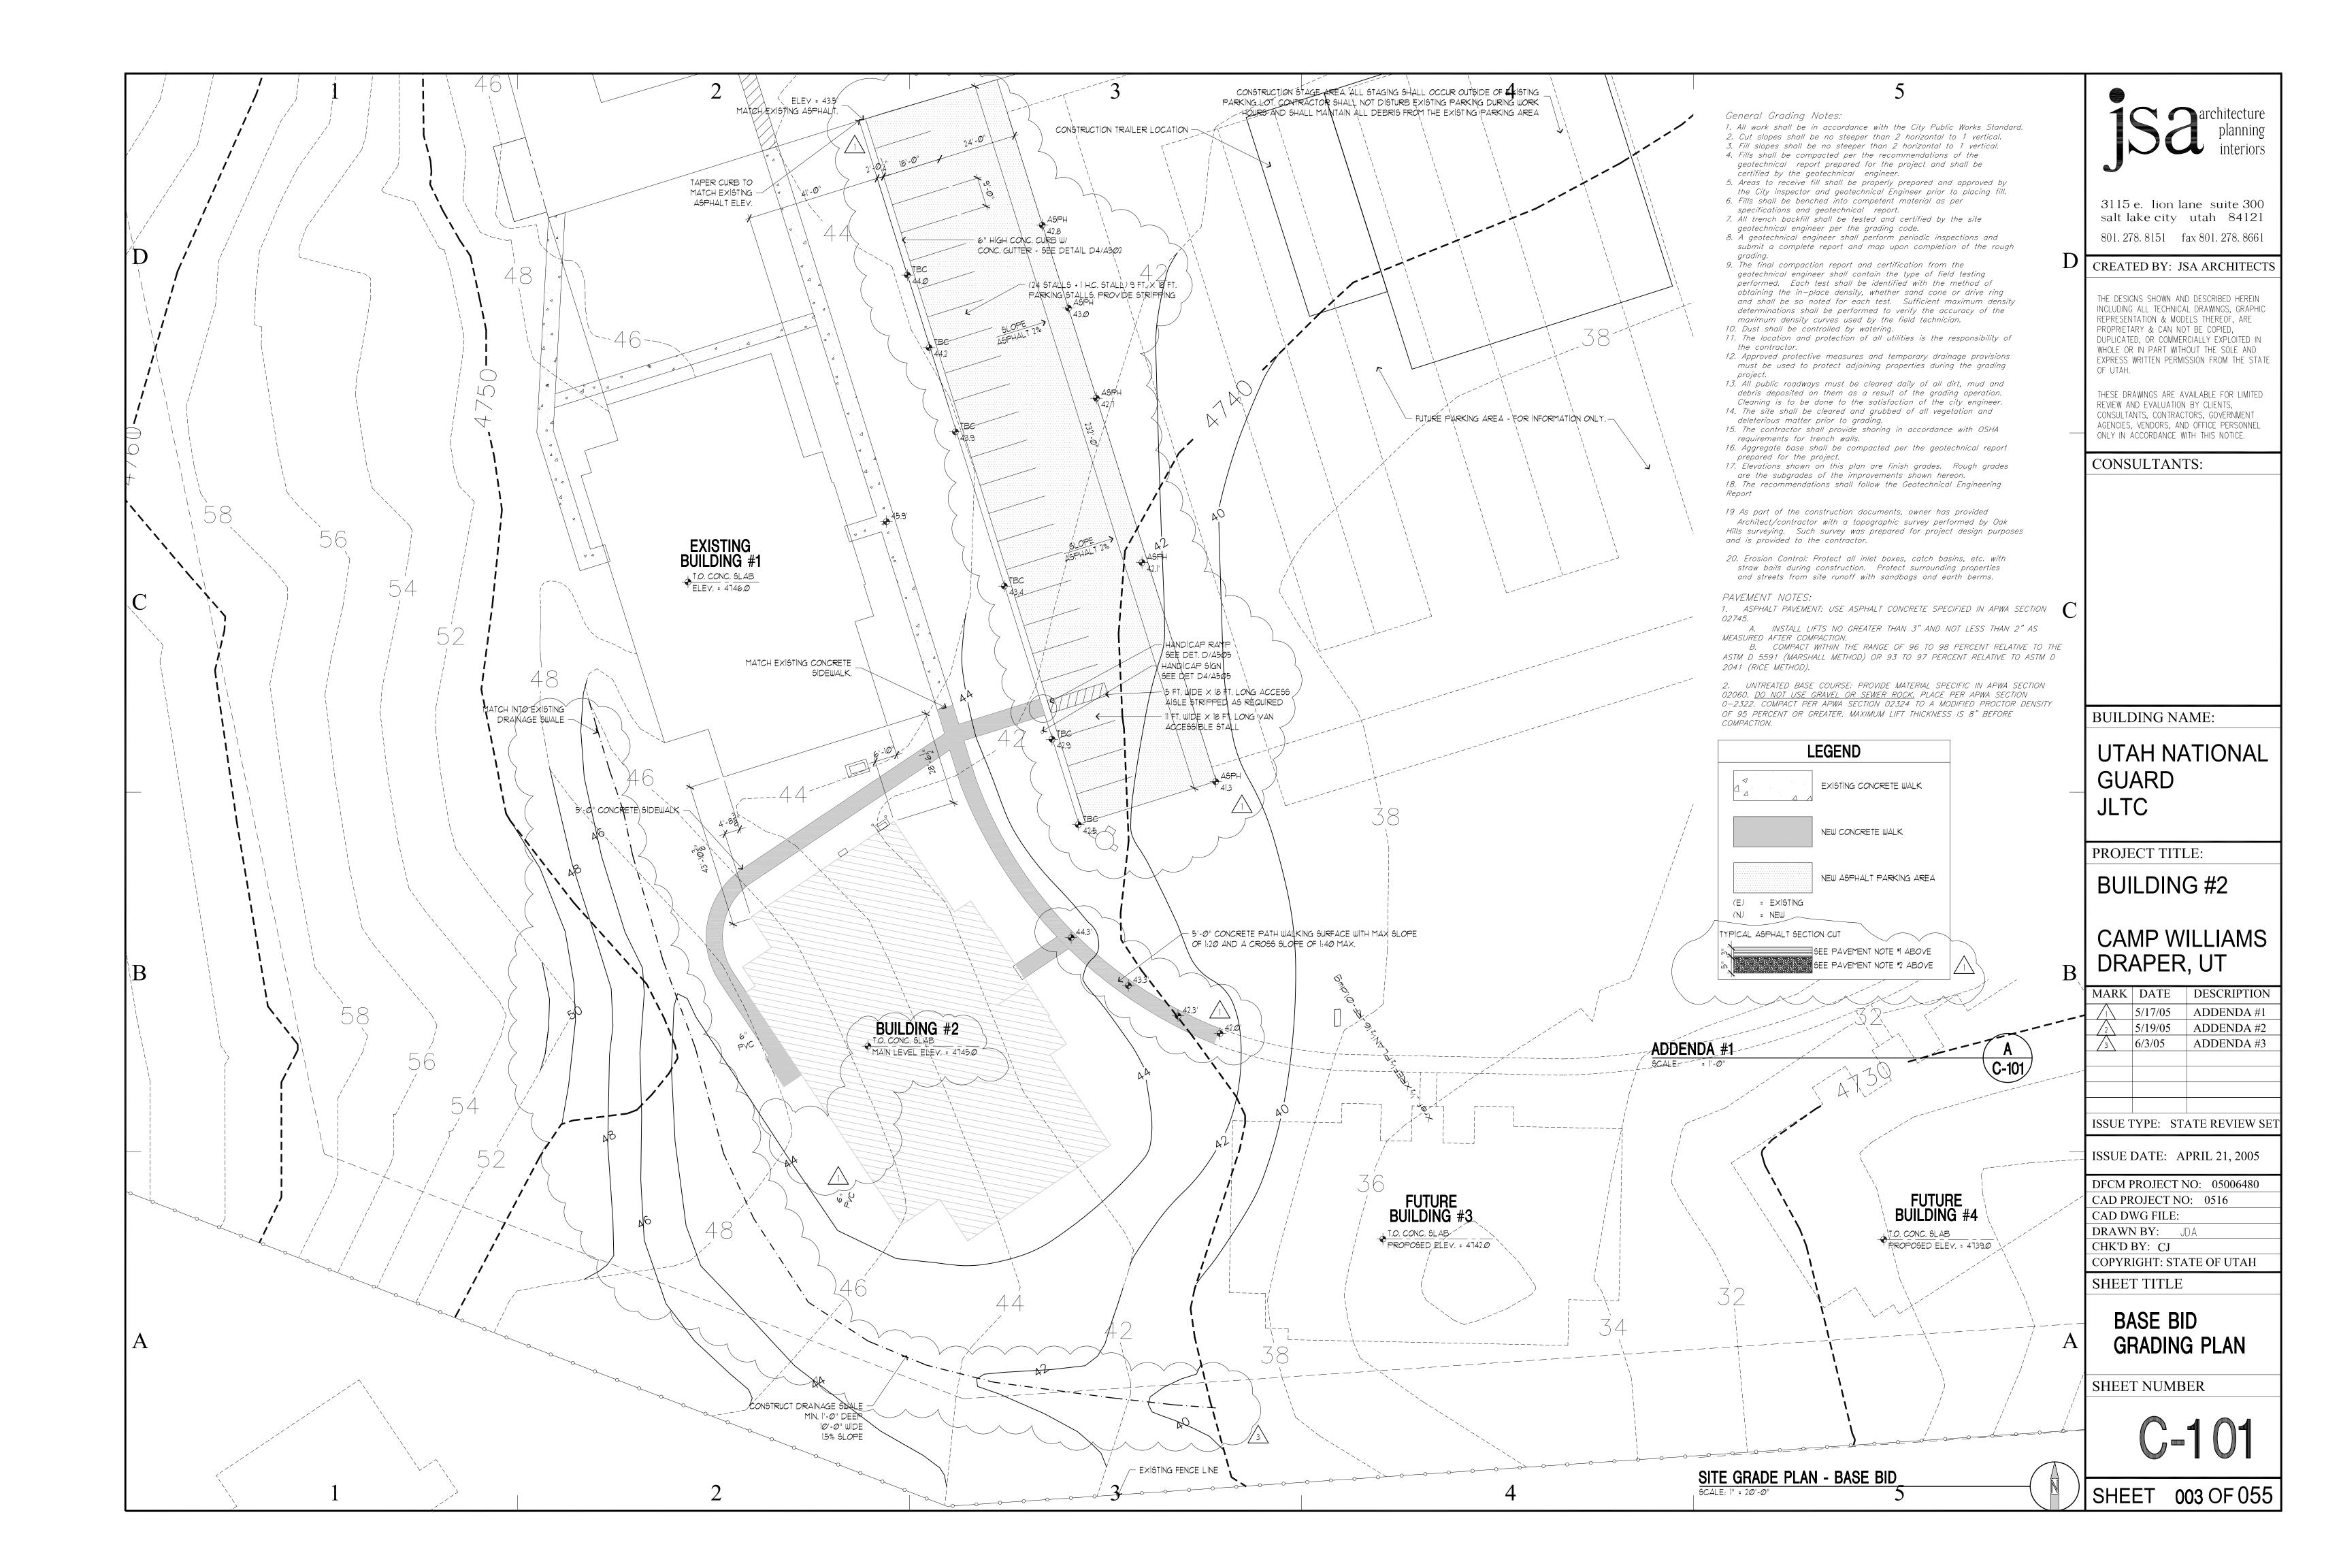
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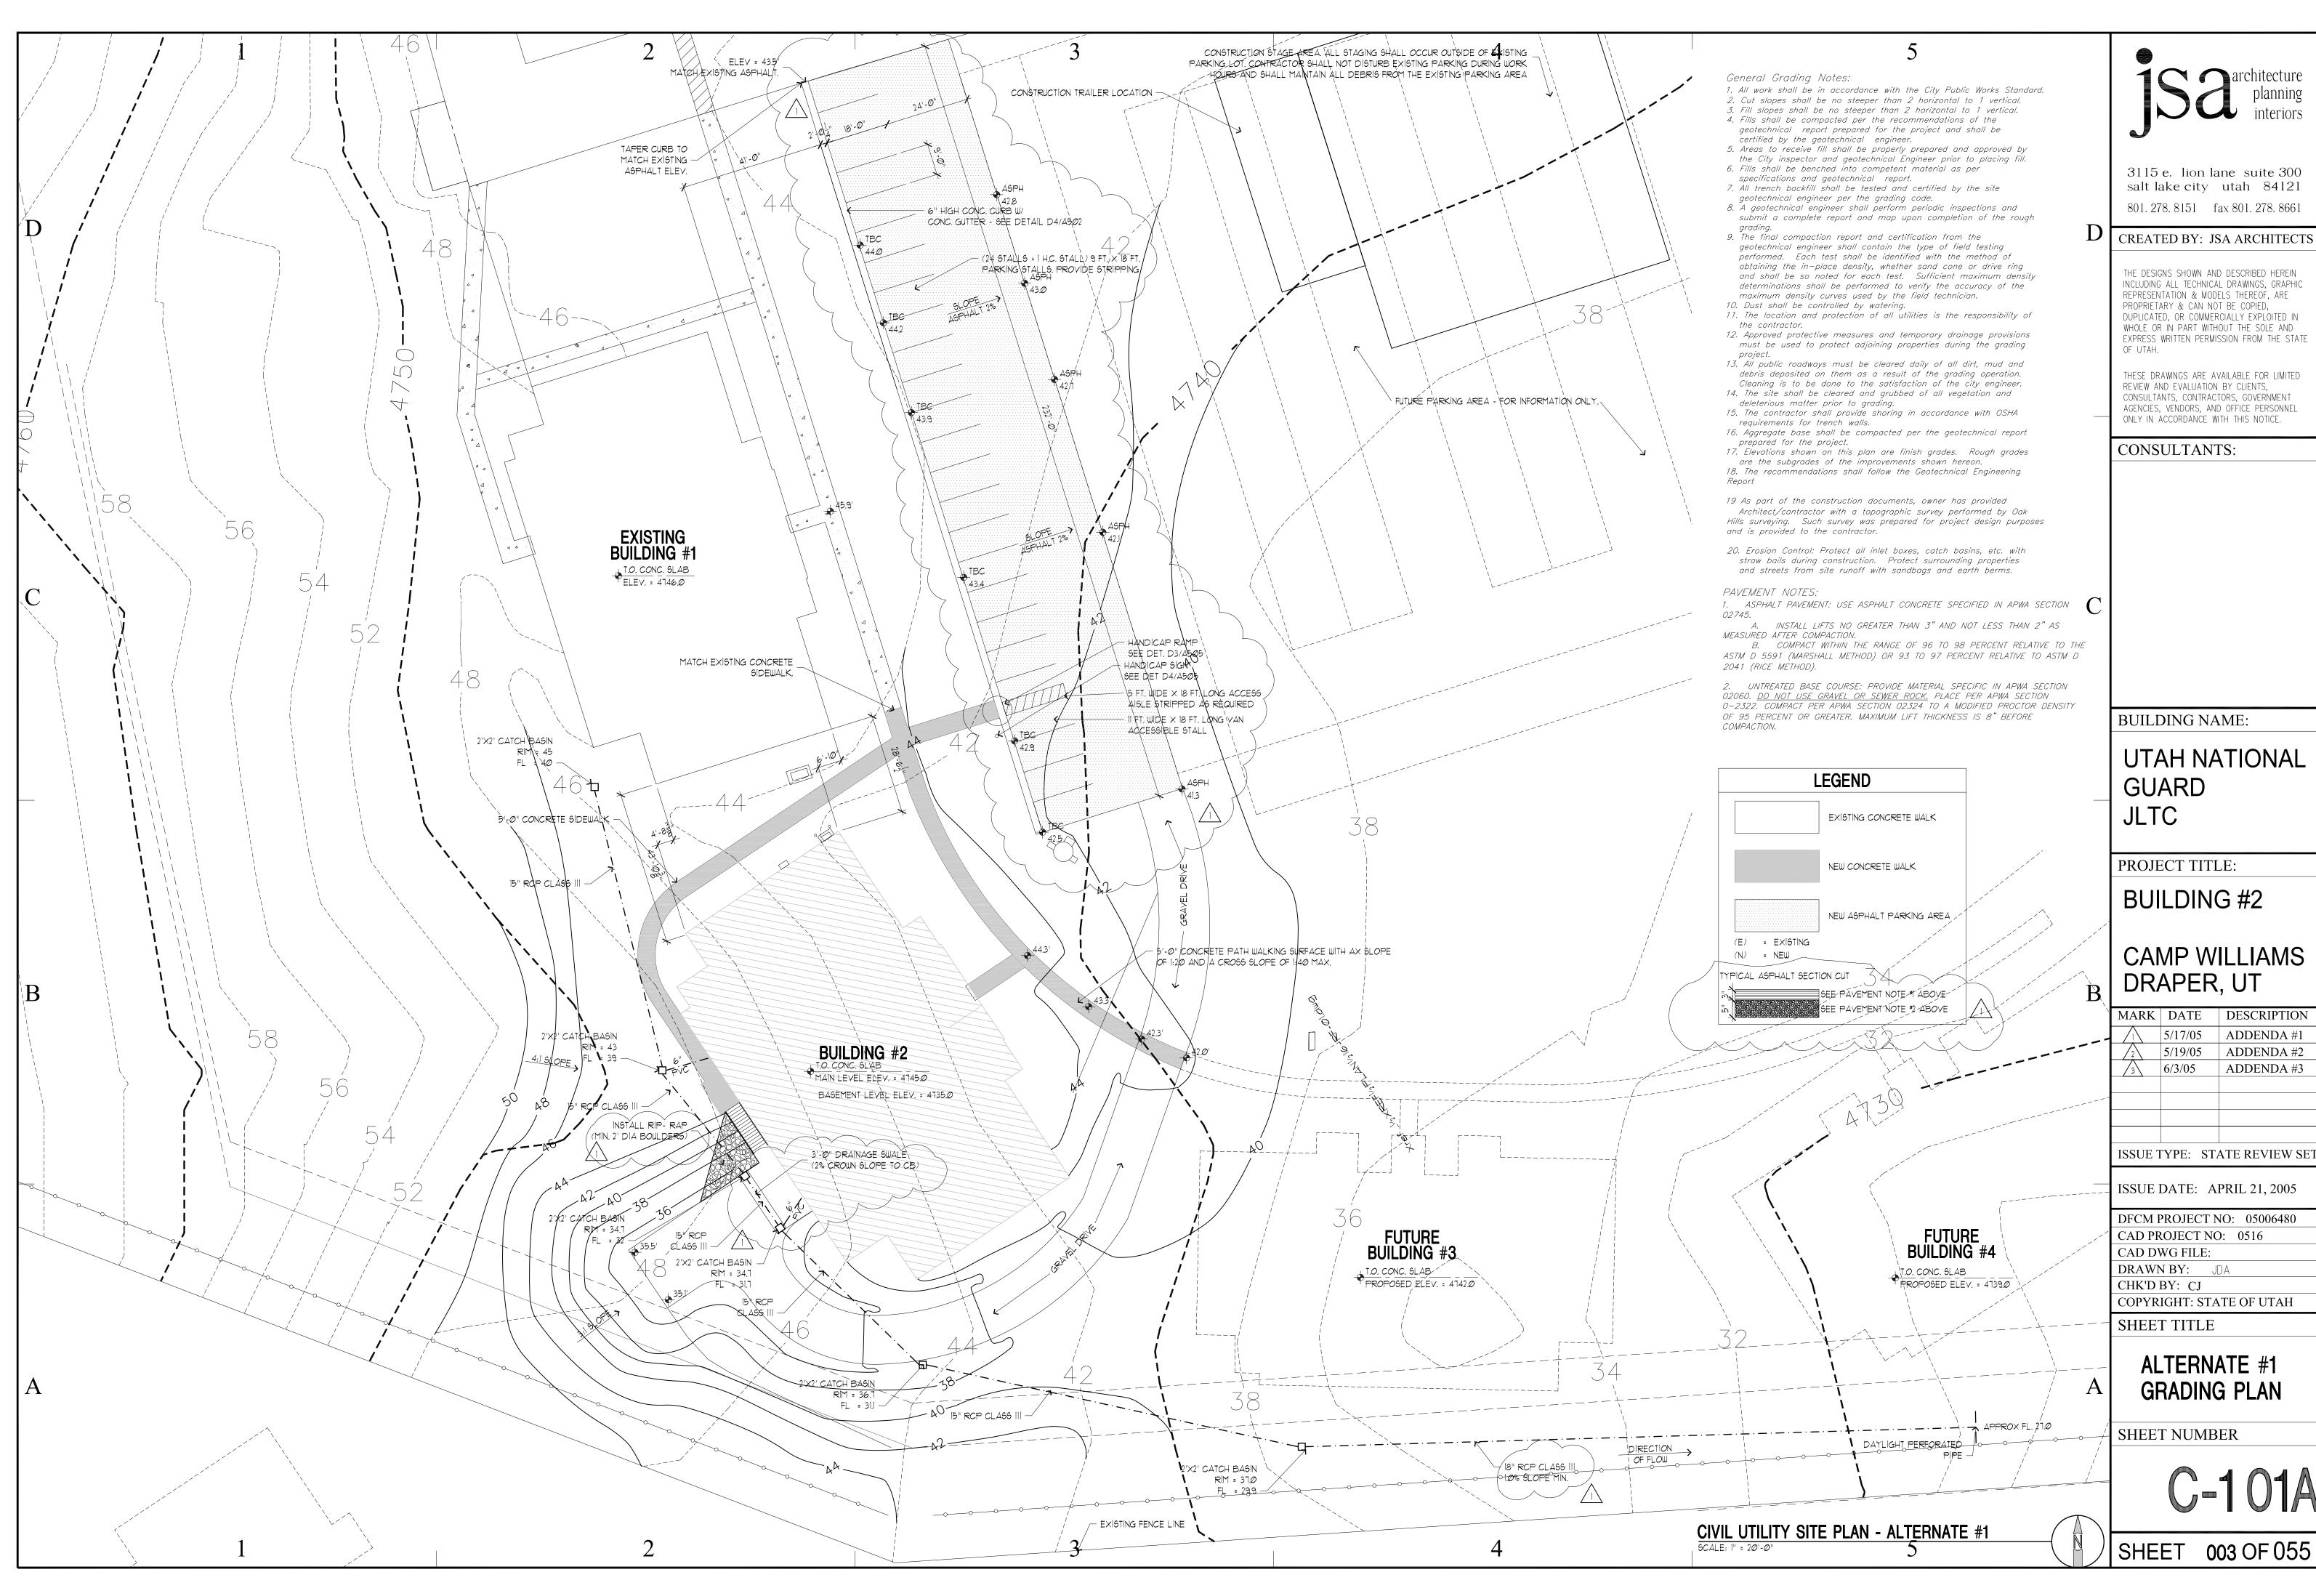
SHEET TITLE

**CODE REVIEW** VICINITY MAP


SHEET NUMBER

SHEET 002 OF 055





MARK	DATE	DESCRIPTION
Ţ	5/17/05	ADDENDA #1
$\sqrt{2}$	5/19/05	ADDENDA #2
3	6/3/05	ADDENDA #3

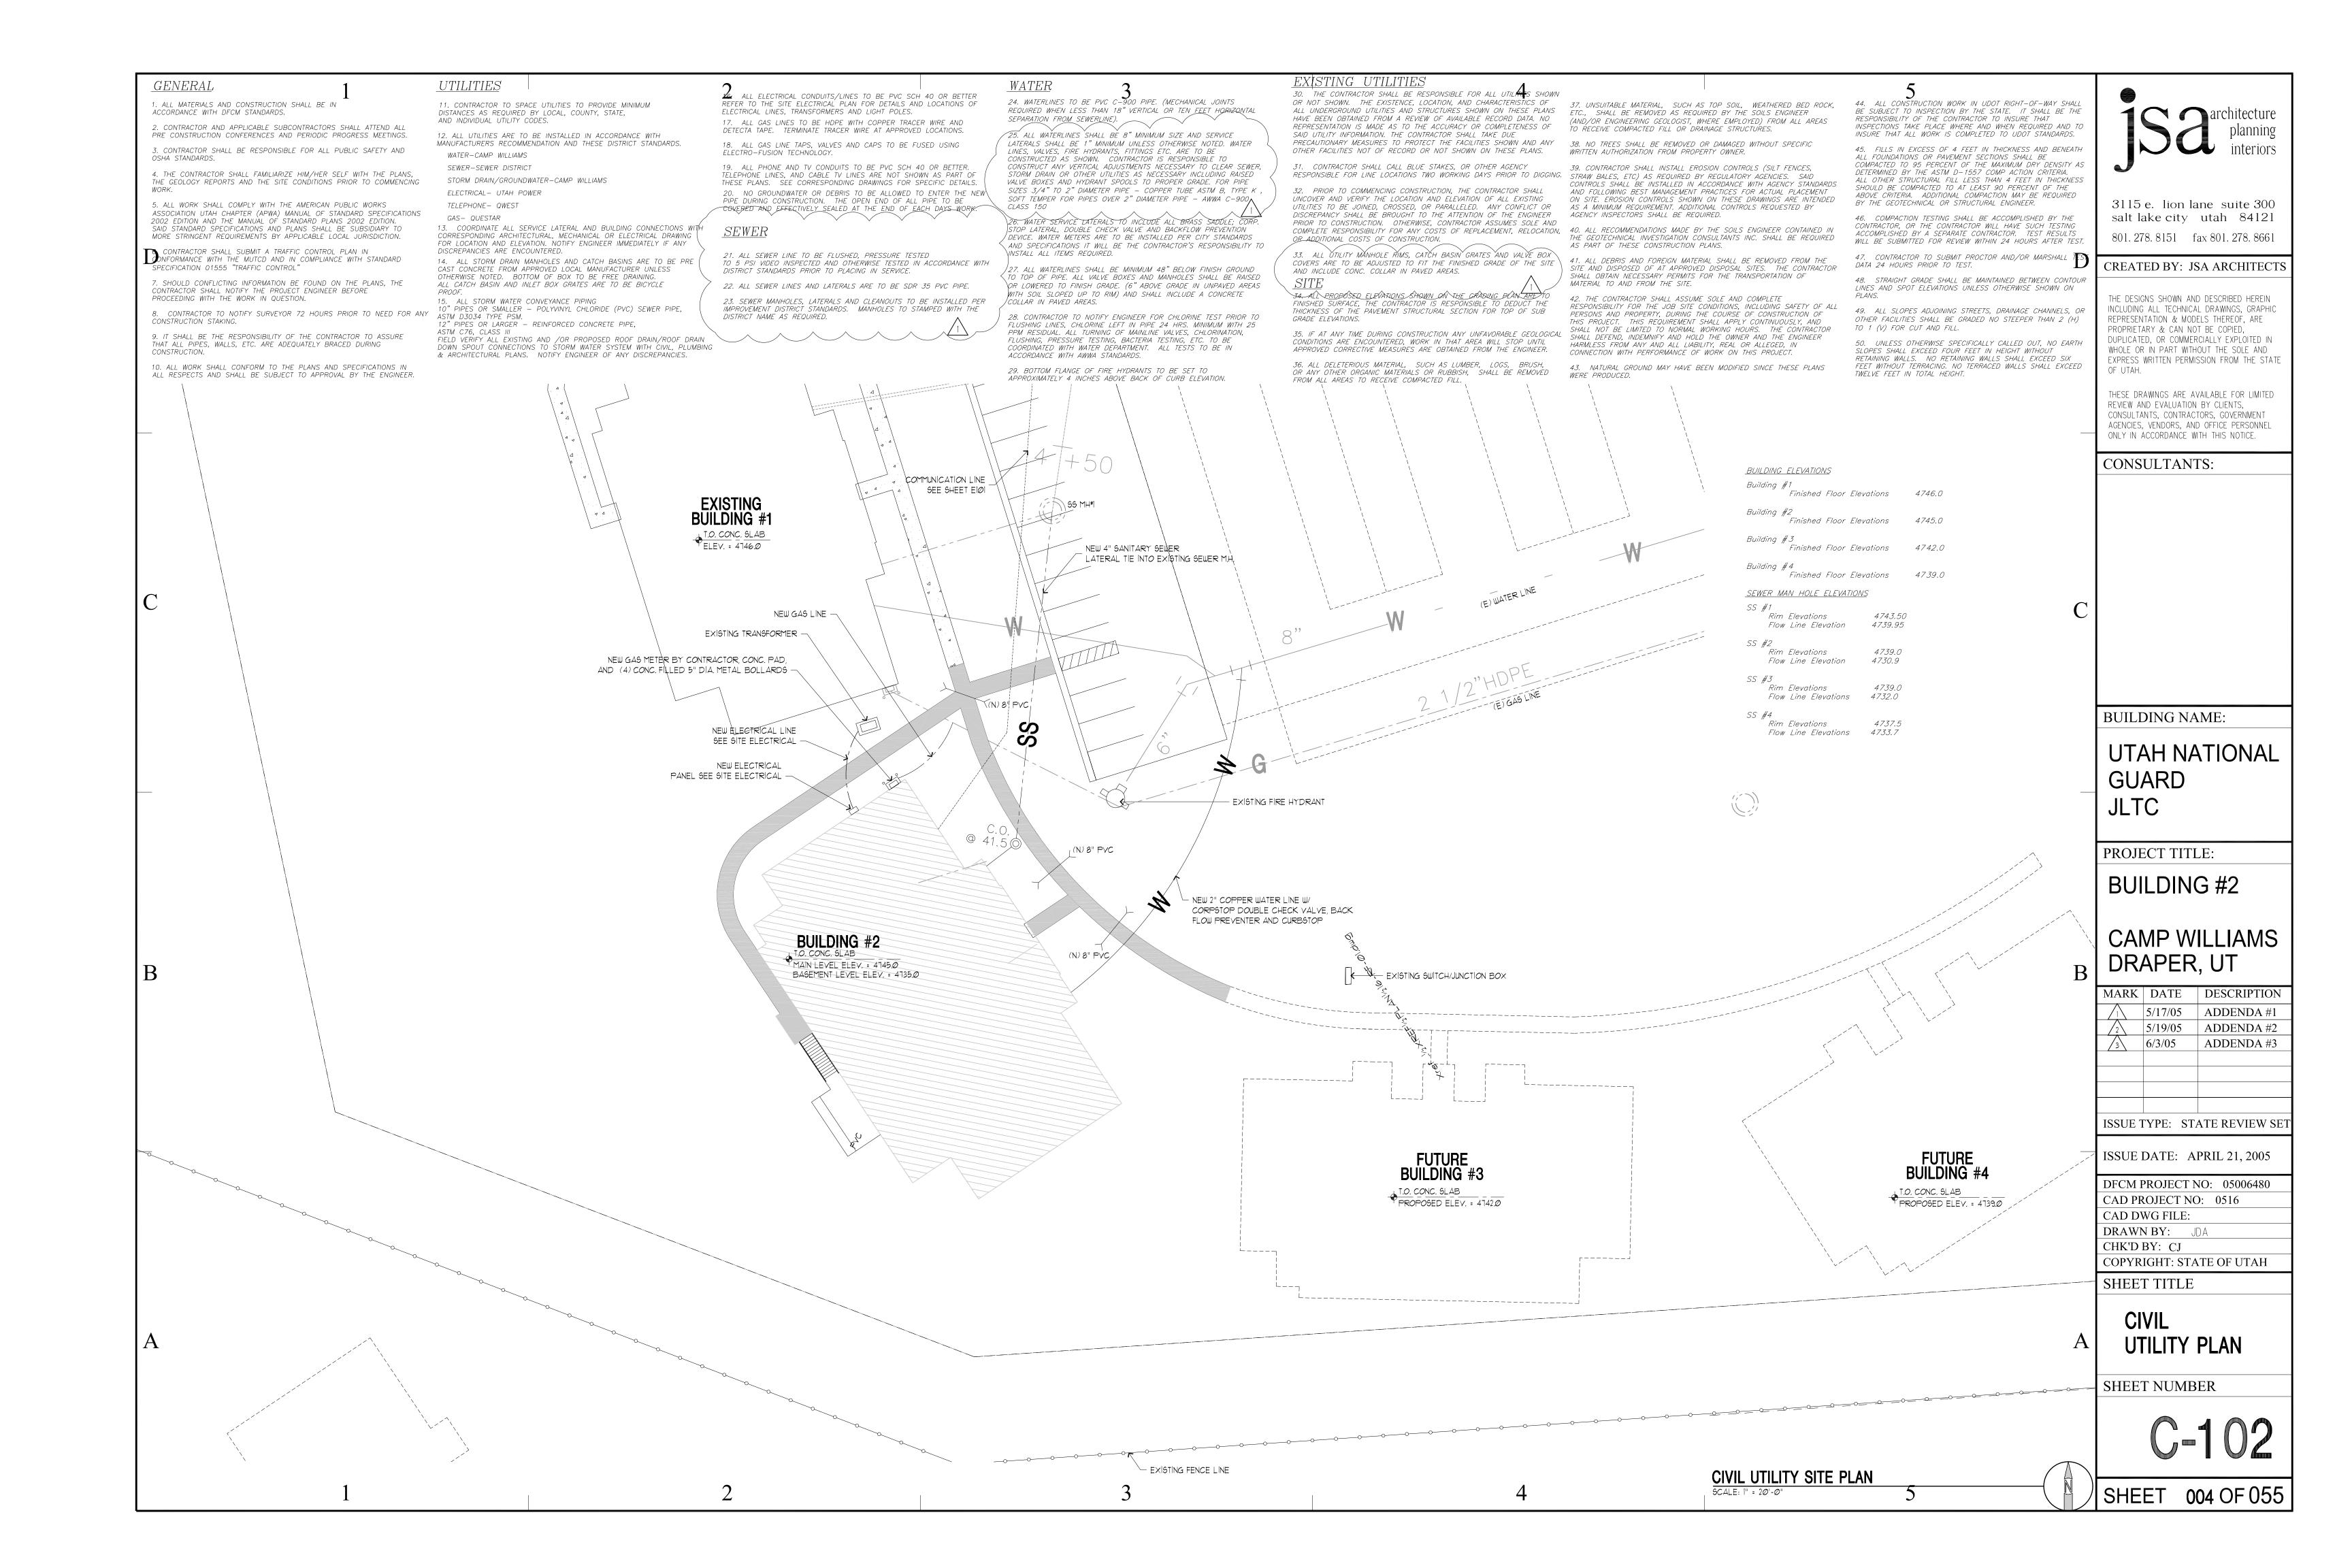

6. SUBSTITUTION OR ROOF DECK SHALL BE APPROVED BY ARCHITECT AND ENGINEER, IT SHALL HAVE CAPACITY FOR GRAVITY AND SHEAR LOADS EQUAL TO OR BETTER THAN SPECIFIED STEEL DECKS AND SHALL BE I.C.B.O. APPROVED.

## REINFORCING BARS

METAL REINFORCEMENT SHALL BE DEFORMED TYPE BARS AND SHALL CONFORM TO ASTM A-615 GRADE 60 WITH MINIMUM YIELD STRENGTH OF 60 KSI. ALL REINFORCEMENT BARS SHALL BE DETAILED, BOLSTERED AND SUPPORTED IN ACCORDANCE WITH ACI STANDARD 315 "MANUAL OF STANDARD PRACTICE FOR DETAILING REINFORCE CONCRETE STRUCTURES", CONCRETE REINFORCING STEEL INSTITUTE (CRSI) AND "BUILDING CODE REQUIREMENTS FOR REINFORCED CONCRETE" ACI 318,

#### STRUCTURAL STEEL

1. ALL STRUCTURAL STEEL SHALL CONFORM WITH ASTM A-36 STANDARDS AS OUTLINED IN THE AISC "MANUAL OF STEEL CONSTRUCTION" (LATEST EDITION) CONTAINING THE SPECIFICATIONS FOR THE DESIGN, FABRICATION AND ERECTION OF STRUCTURAL STEEL BUILDINGS, AND THE "CODE OF STANDARD PRACTICE" (LATEST EDITION).

2. STEEL TUBING SHALL CONFORM TO A-500, GRADE B, FY = 46 KSI

- 3. UNLESS OTHERWISE NOTES, ALL STRUCTURAL STEEL TO STEEL CONNECTIONS SHALL BE MADE IN SUCH A MANNER TO DEVELOP FULL SHEAR CAPACITY OF CONNECTING MEMBERS AS PER AISC SPECIFICATIONS.
- 4. UNLESS OTHERWISE NOTED, ALL STRUCTURAL STEEL TO STEEL BOLTED CONNECTIONS SHALL USE 3/4" DIAMETER HIGH STRENGTH BOLTS CONFORMING TO ASTM A-325 (IN) AND SHALL HAVE CARBONIZED WASHERS UNDER TURNING UNIT. ALL OTHER BOLTS SHALL CONFORM TO ASTM A-307, A-307 BOLTS ARE TO TIGHTENED BY THE TURN-OF-THE -NUT-METHOD, HIGH STRENGTH BOLTS ARE TO TIGHTENED BY EITHER TURN-OF-THE-NUT-METHOD OR LOAD INDICATOR WASHERS.
- 5. REMOVE RUST, OILS, MILL SCALE AND APPLY ONE COAT RED LEAD IRON OXIDE SHOP PAINT, 2 MILS (DRY) THICK. PROVIDE TOUCH UP FIELD COAT AT ALL ABRADED AND WELDED AREAS, 2 MILS(DRY) THICK,
- 6. PRIOR TO FABRICATION AND PLACEMENT, SHOP DRAWINGS FOR ALL STEEL ITEMS SHALL BE PREPARED FOR AND REVIEWED BY THE STRUCTURAL ENGINEER.
- 7. ALL WELDS SHALL BE MADE WITH ETØXX ELECTRODES AND BY WELDERS CERTIFIED BY A.W.X. STANDARDS WITHIN THE LAST 12 MONTHS (PROVIDE WRITTEN CERTIFICATION IF REQUESTED) WHERE NOTED ON THE DRAWING:
- A, ALL FIELD WELDING SHALL BE DONE UNDER THE DIRECT SUPERVISION OF AN INDEPENDENT TESTING LABORATORY AS SELECTED BY THE ARCHITECT/ENGINEER.
- B. ALL FULL PENETRATION OR FUSION WELDS SHOWN ON DRAWINGS ARE TO BE TESTED BY X-RAY PER A.W.S.
- C. THE OWNER MAY TEST ALL FILLET WELDS OR PORTIONS THERE OF
- D. COPIES OF TEST RESULTS TO BE SENT TO ARCHITECT/STRUCTURAL ENGINEER.

SPECIFICATION,

## SPECIAL INSPECTION:

1. SPECIAL INSPECTIONS SHALL BE PROVIDED DURING CONSTRUCTION FOR THE FOLLOWING:

CONCRETE: DURING THE TAKING OF TEST SPECIMANS AND PLACING OF REINFORCED CONCRETE (EXCEPT SLABS ON GRADE). BOLTS INSTALLED IN CONCRETE:
PRIOR TO AND DURING THE PLACEMENT OF CONCRETE AROUND

BOLTS IDENTIFIED ON THE DRAWINGS (IF ANY) AS REQUIRING SPECIAL INSPECTIONS.

REINFORCING STEEL:
FOR CONFORMANCE WITH THE APPROVED PLANS PRIOR TO THE CLOSING OF FORMS OR THE DELIVERY OF CONCRETE TO THE JOB SITE.

STRUCTURAL WELDING: VERIFY THE MATERIALS, QUALIFICATIONS OF THE WELDING PROCEDURES AND WELDERS PRIOR TO THE START OF WORK AND PROVIDE PERIODIC INSPECTIONS OF WORK IN PROGRESS AND A VISUAL INSPECTION OF ALL WELDS (INCLUDING WELDING OF METAL ROOF DECK) PRIOR TO COMPLETION OF WORK, STRUCTURAL STEEL SHALL BE PROVIDE FOR BY A REGISTERED AND APPROVED FABRICATOR. INSPECTION IS NOT REQUIRED FOR WELDING DONE IN AN APPROVED FABRICATOR'S SHOP.

HIGH STRENGTH BOLTING: PROVIDE PERIODIC INSPECTIONS TO INSURE THAT THE PLIES OF THE CONNECTED ELEMENTS HAVE BEEN BROUGHT IN TO SNUG CONTACT. STRUCTURAL MASONRY: DURING THE PREPARATION AND TAKING OF ANY REQUIRED PRISMS

OR TEST SPECIMENS, AT THE START OF LAYING UNITS, AFTER THE PLACEMENT OF REINFORCING STEEL, GROUT SPACE PRIOR TO EACH GROUTING OPERATION, AND DURING ALL GROUTING OPERATIONS. EPOXY ANCHORS AND REINFORCEMENT EMBEDDED WITH EPOXY PROVIDE INSPECTION OF HOLES AND PROVIDE CONTINUOUS

INSPECTION DURING PLACEMENT OF EPOXY ANCHORS OR OTHER ITEMS EMBEDDED IN CONCRETE OR MASONRY. INSPECTOR TO VERIFY TYPE AND EMBEDMENT OF ANCHORS. 2. THE SPECIAL INSPECTOR SHALL BE A QUALIFIED PERSON WHO SHALL DEMONSTRATE HIS COMPETENCE, TO THE SATISFACTION OF THE BUILDING

OFFICIAL FOR INSPECTION OF THE PARTICULAR TYPE OF CONSTRUCTION OR OPERATION REQUIRING SPECIAL INSPECTION. 3. DUTIES AND RESPONSIBILITIES OF THE SPECIAL INSPECTOR OBSERVE THE WORK ASSIGNED FOR CONFORMANCE WITH THE APPROVED DESIGN DRAWINGS AND SPECIFICATIONS. THE INSPECTOR MAY NOT

ALTER, MODIFY, ENLARGE OR WAIVE ANY OF THE REQUIREMENTS OF THE DOCUMENTS. FURNISH INSPECTION REPORTS TO THE OWNER, THE BUILDING OFFICIAL, AND THE PROFESSIONAL OF RECORD. ALL DISCREPANCIES SHALL BE BROUGHT TO THE IMMEDIATE ATTENTION OF THE CONTRACTOR FOR CORRECTION, THEN, IF UNCORRECTED, SUBMIT A COMPLETE LIST TO ALL OUTSTANDING DISCREPANCIES ON A WEEKLY BASIS TO THE OWNER, THE BUILDING OFFICIAL, AND THE PROFESSIONAL OF RECORD UNTIL ALL

CORRECTIONS HAVE BEEN COMPLETED. SUBMIT A FINAL SIGNED REPORT STATING WHETHER THE WORK REQUIRING SPECIAL INSPECTIONS WAS, TO THE BEST OF THE INSPECTOR'S KNOWLEDGE, IN CONFORMANCE WITH THE APPROVED PLANS AND SPECIFICATIONS AND THE APPLICABLE WORKMANSHIP PROVISIONS OF THE CODE.

MASONRY REINFORCING LAP SPLICE LENGTH, inches

NOMINAL WALL THICKNESS

10"

25

31

(2) LAYERS

10"

NOMINAL WALL THICKNESS

8"

31

48

4. STRUCTURAL OBSERVATION (AS DEFINED IN CHAPTER 17 OF THE BUILDING CODE) IS NOT REQUIRED.

5. WHERE SPECIAL INSPECTION REQUIREMENTS DUPLICATE THE REQUIREMENTS OF OTHER SPECIFIED TESTING, DUPLICATE INSPECTIONS SHALL NOT BE REQUIRED.

architecture

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**UTAH NATIONAL GUARD** 

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CAMP WILLIAMS | DRAPER, UT

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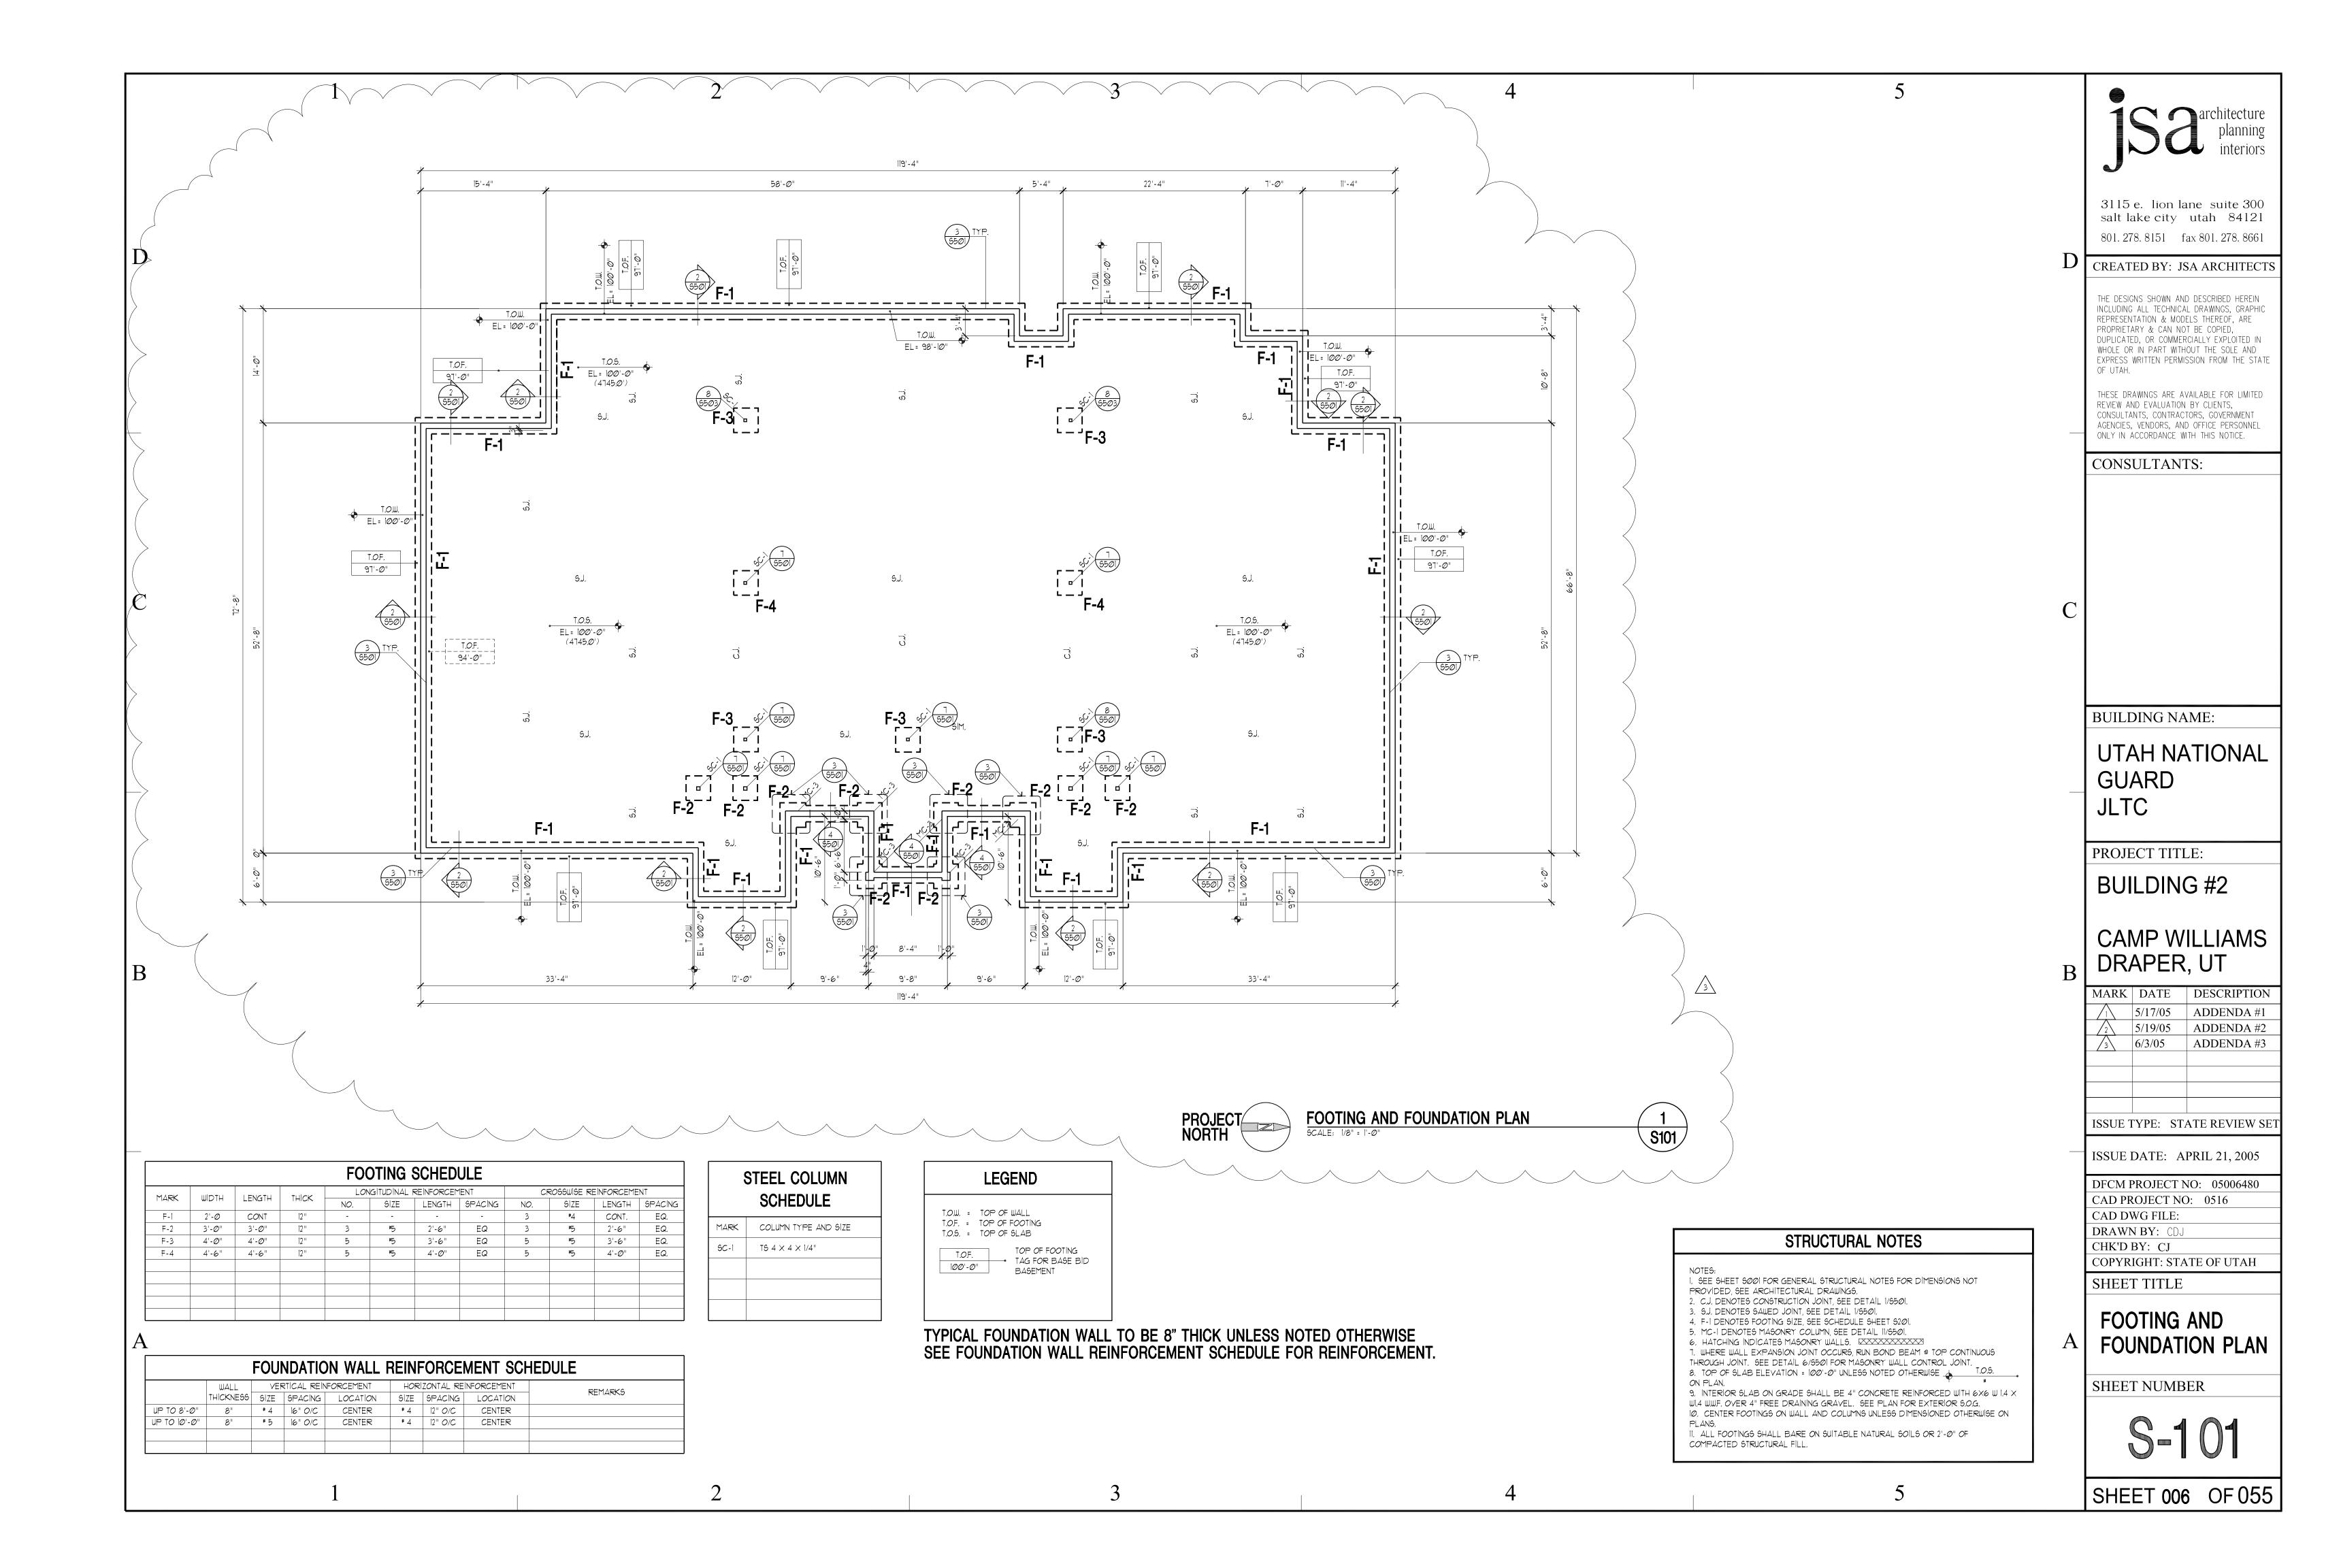
**GENERAL** 


STRUCTURAL NOTES


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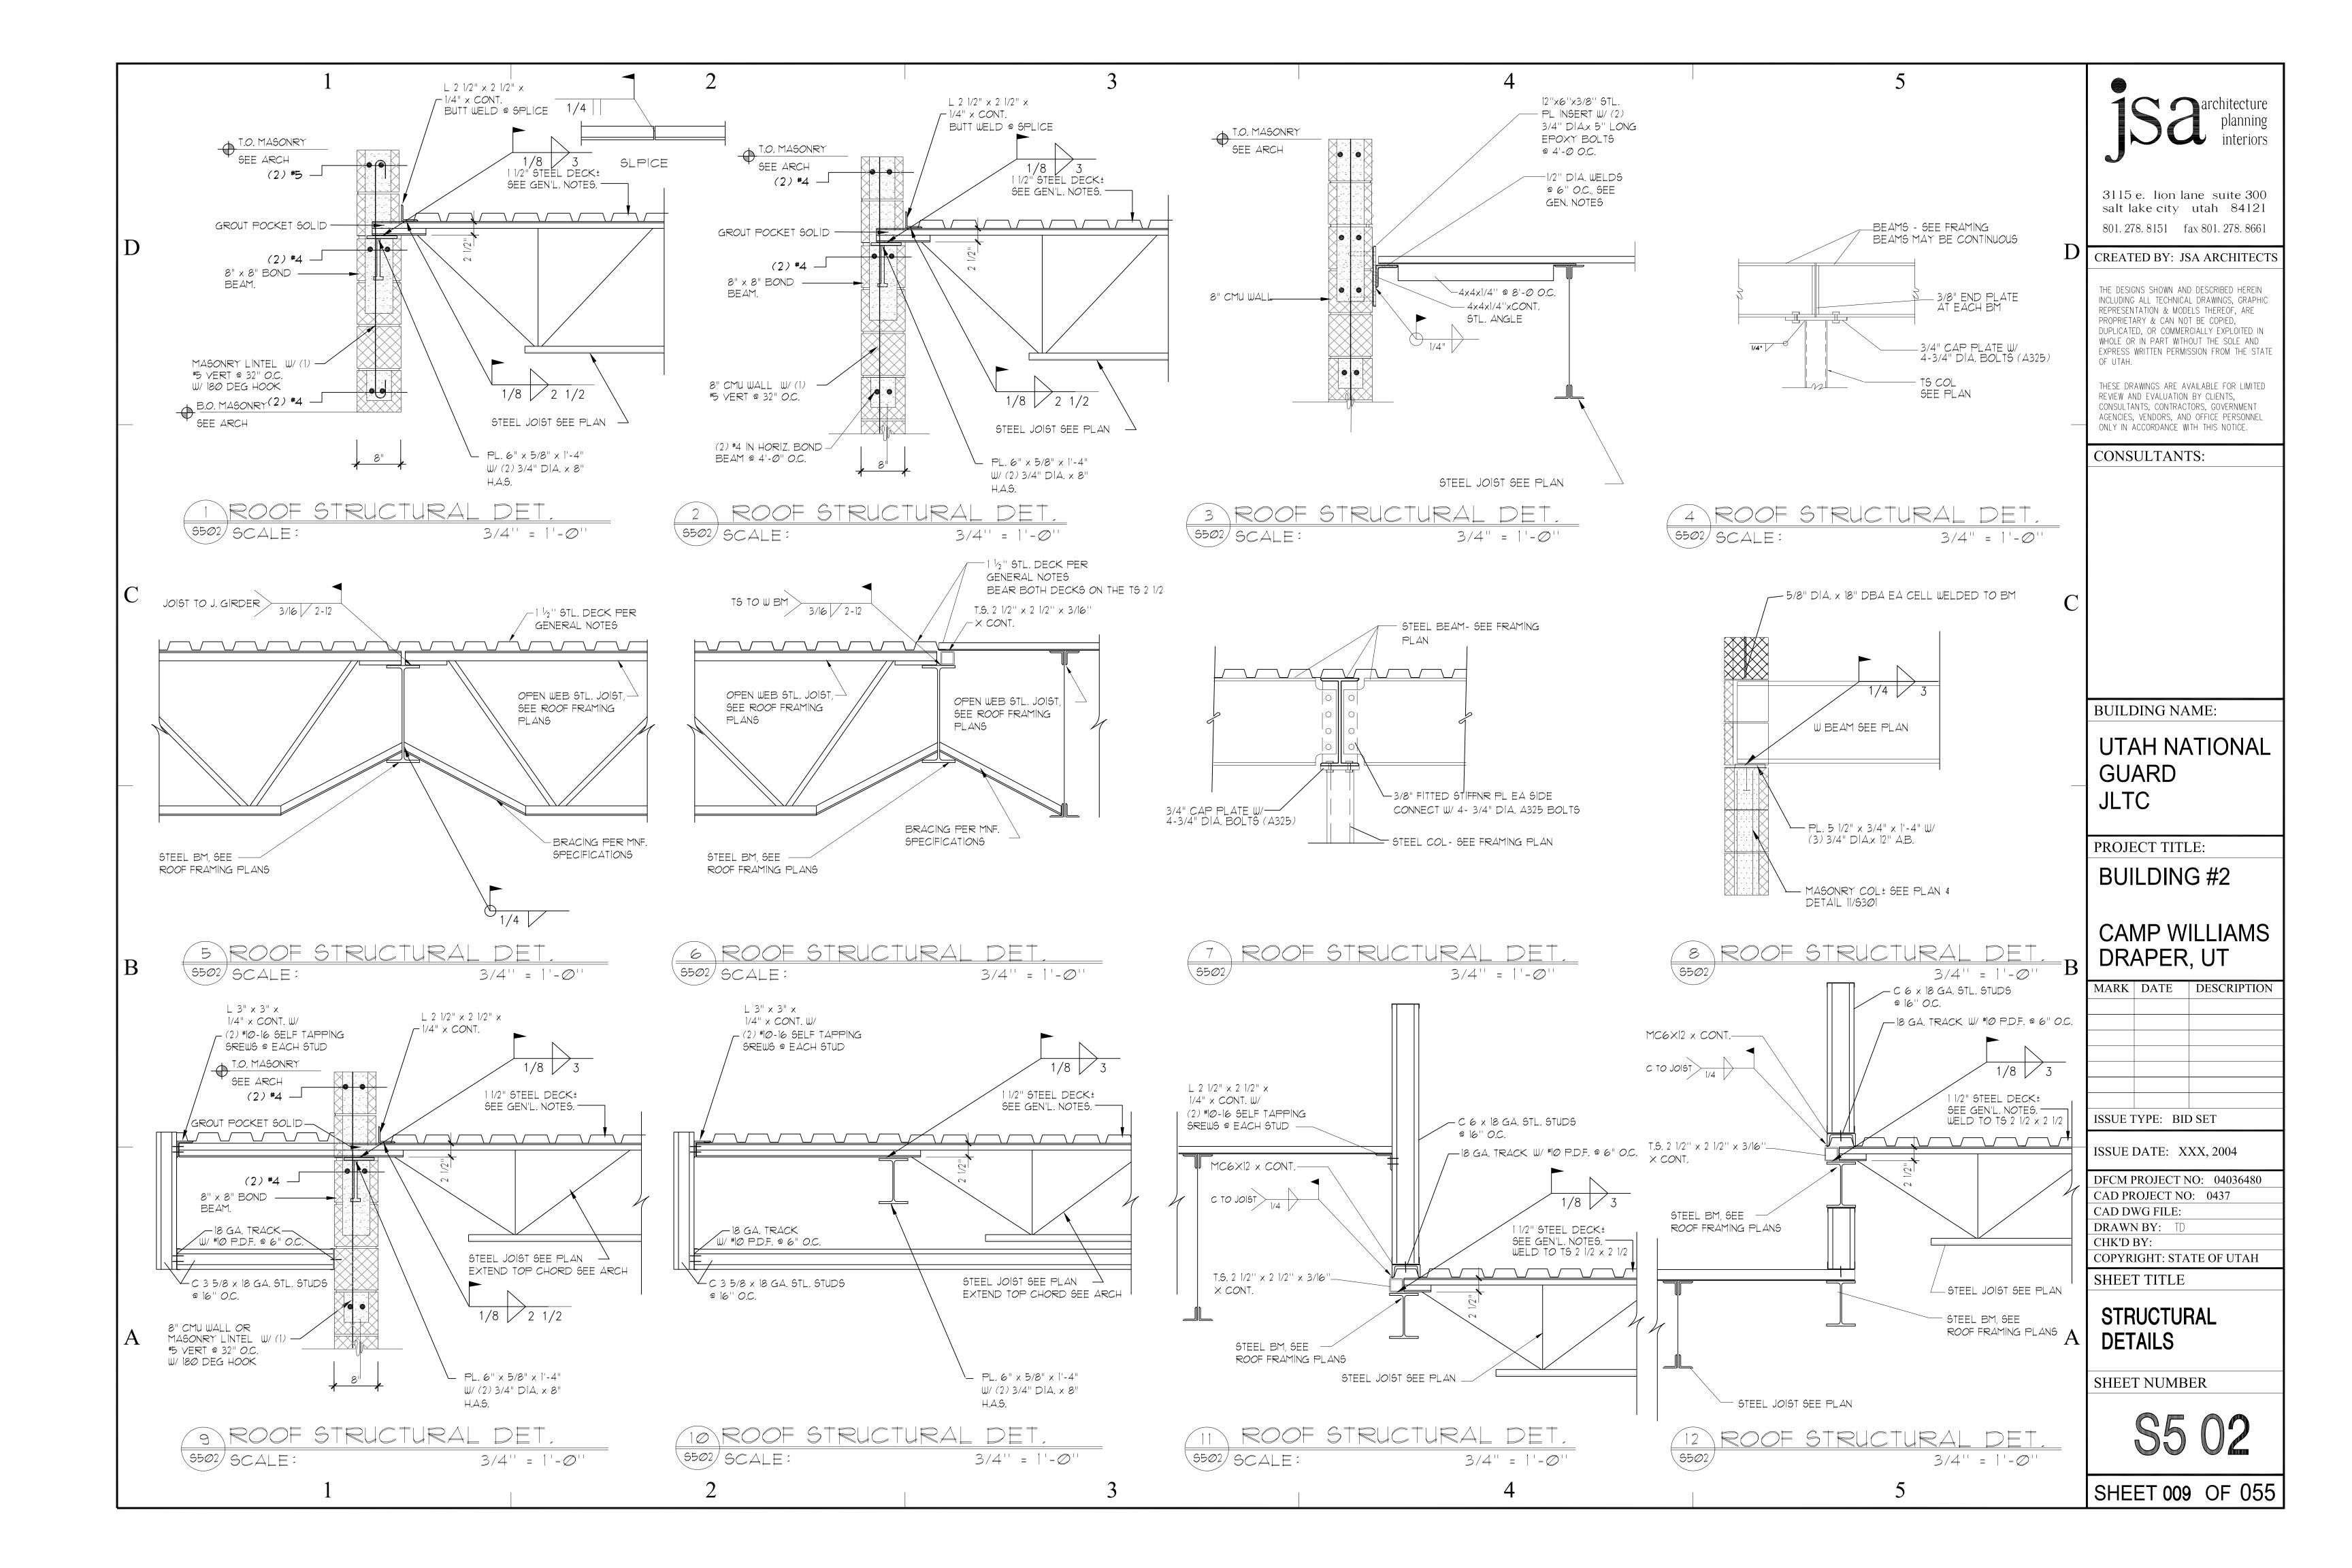
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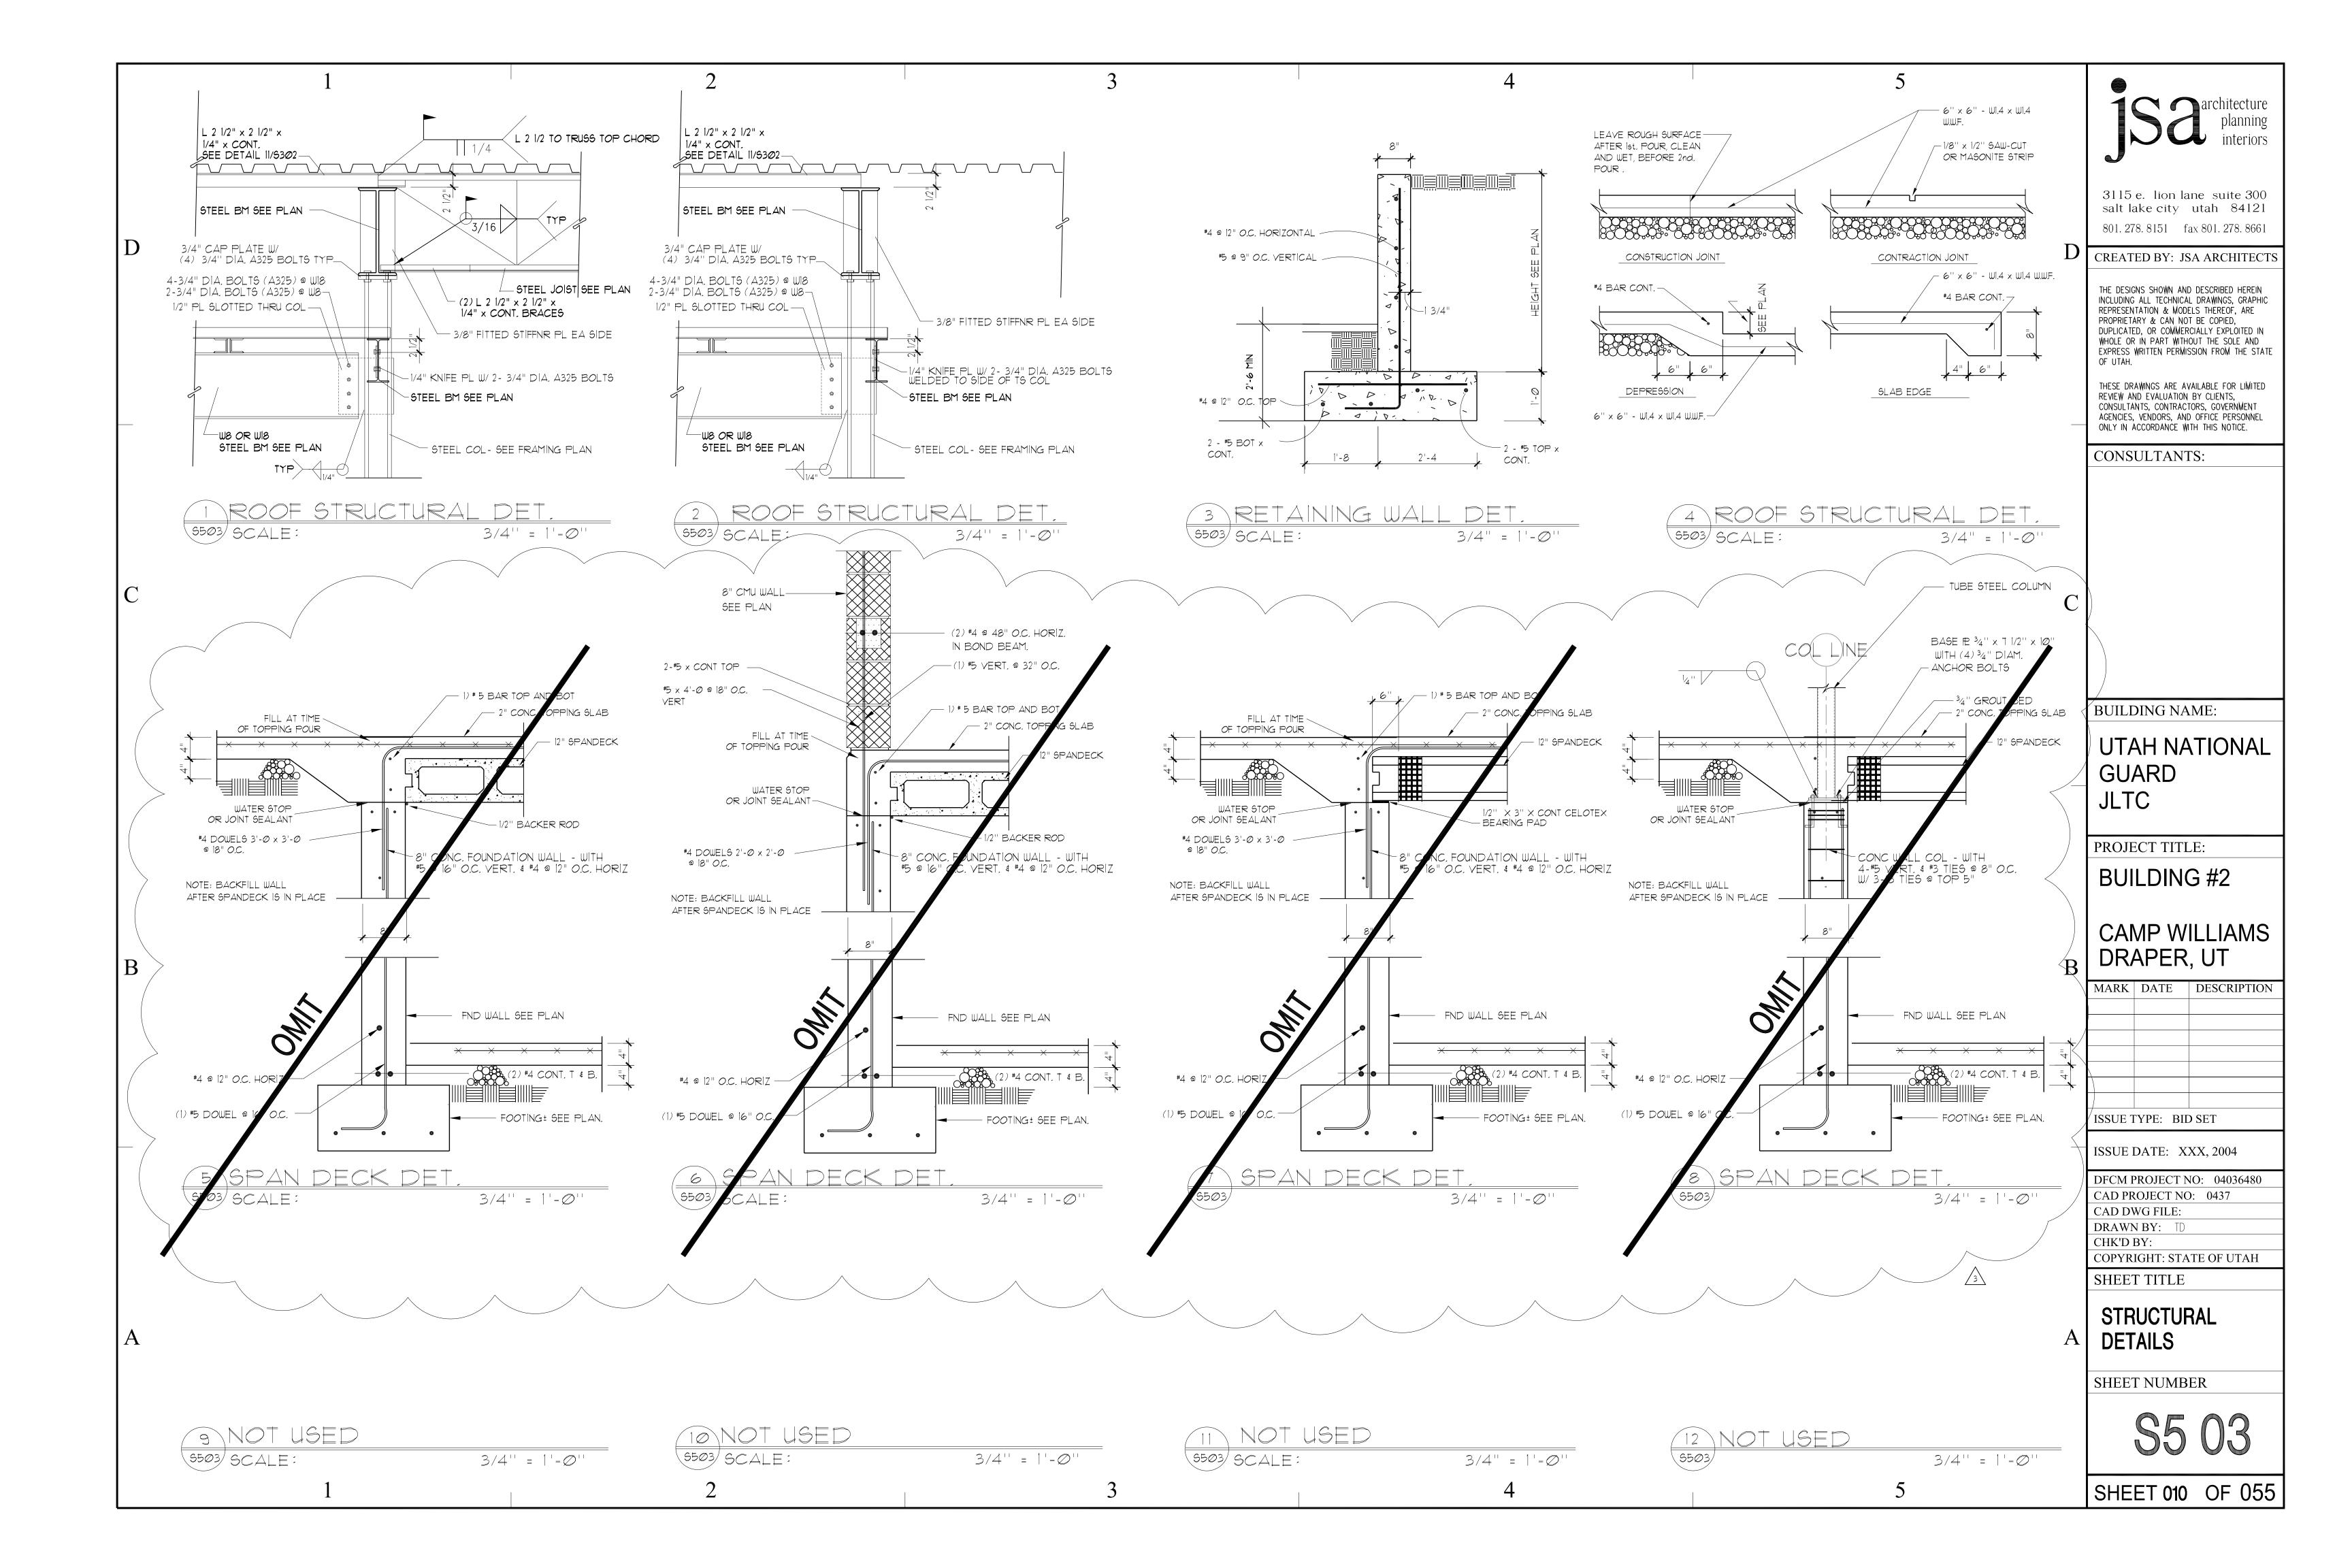
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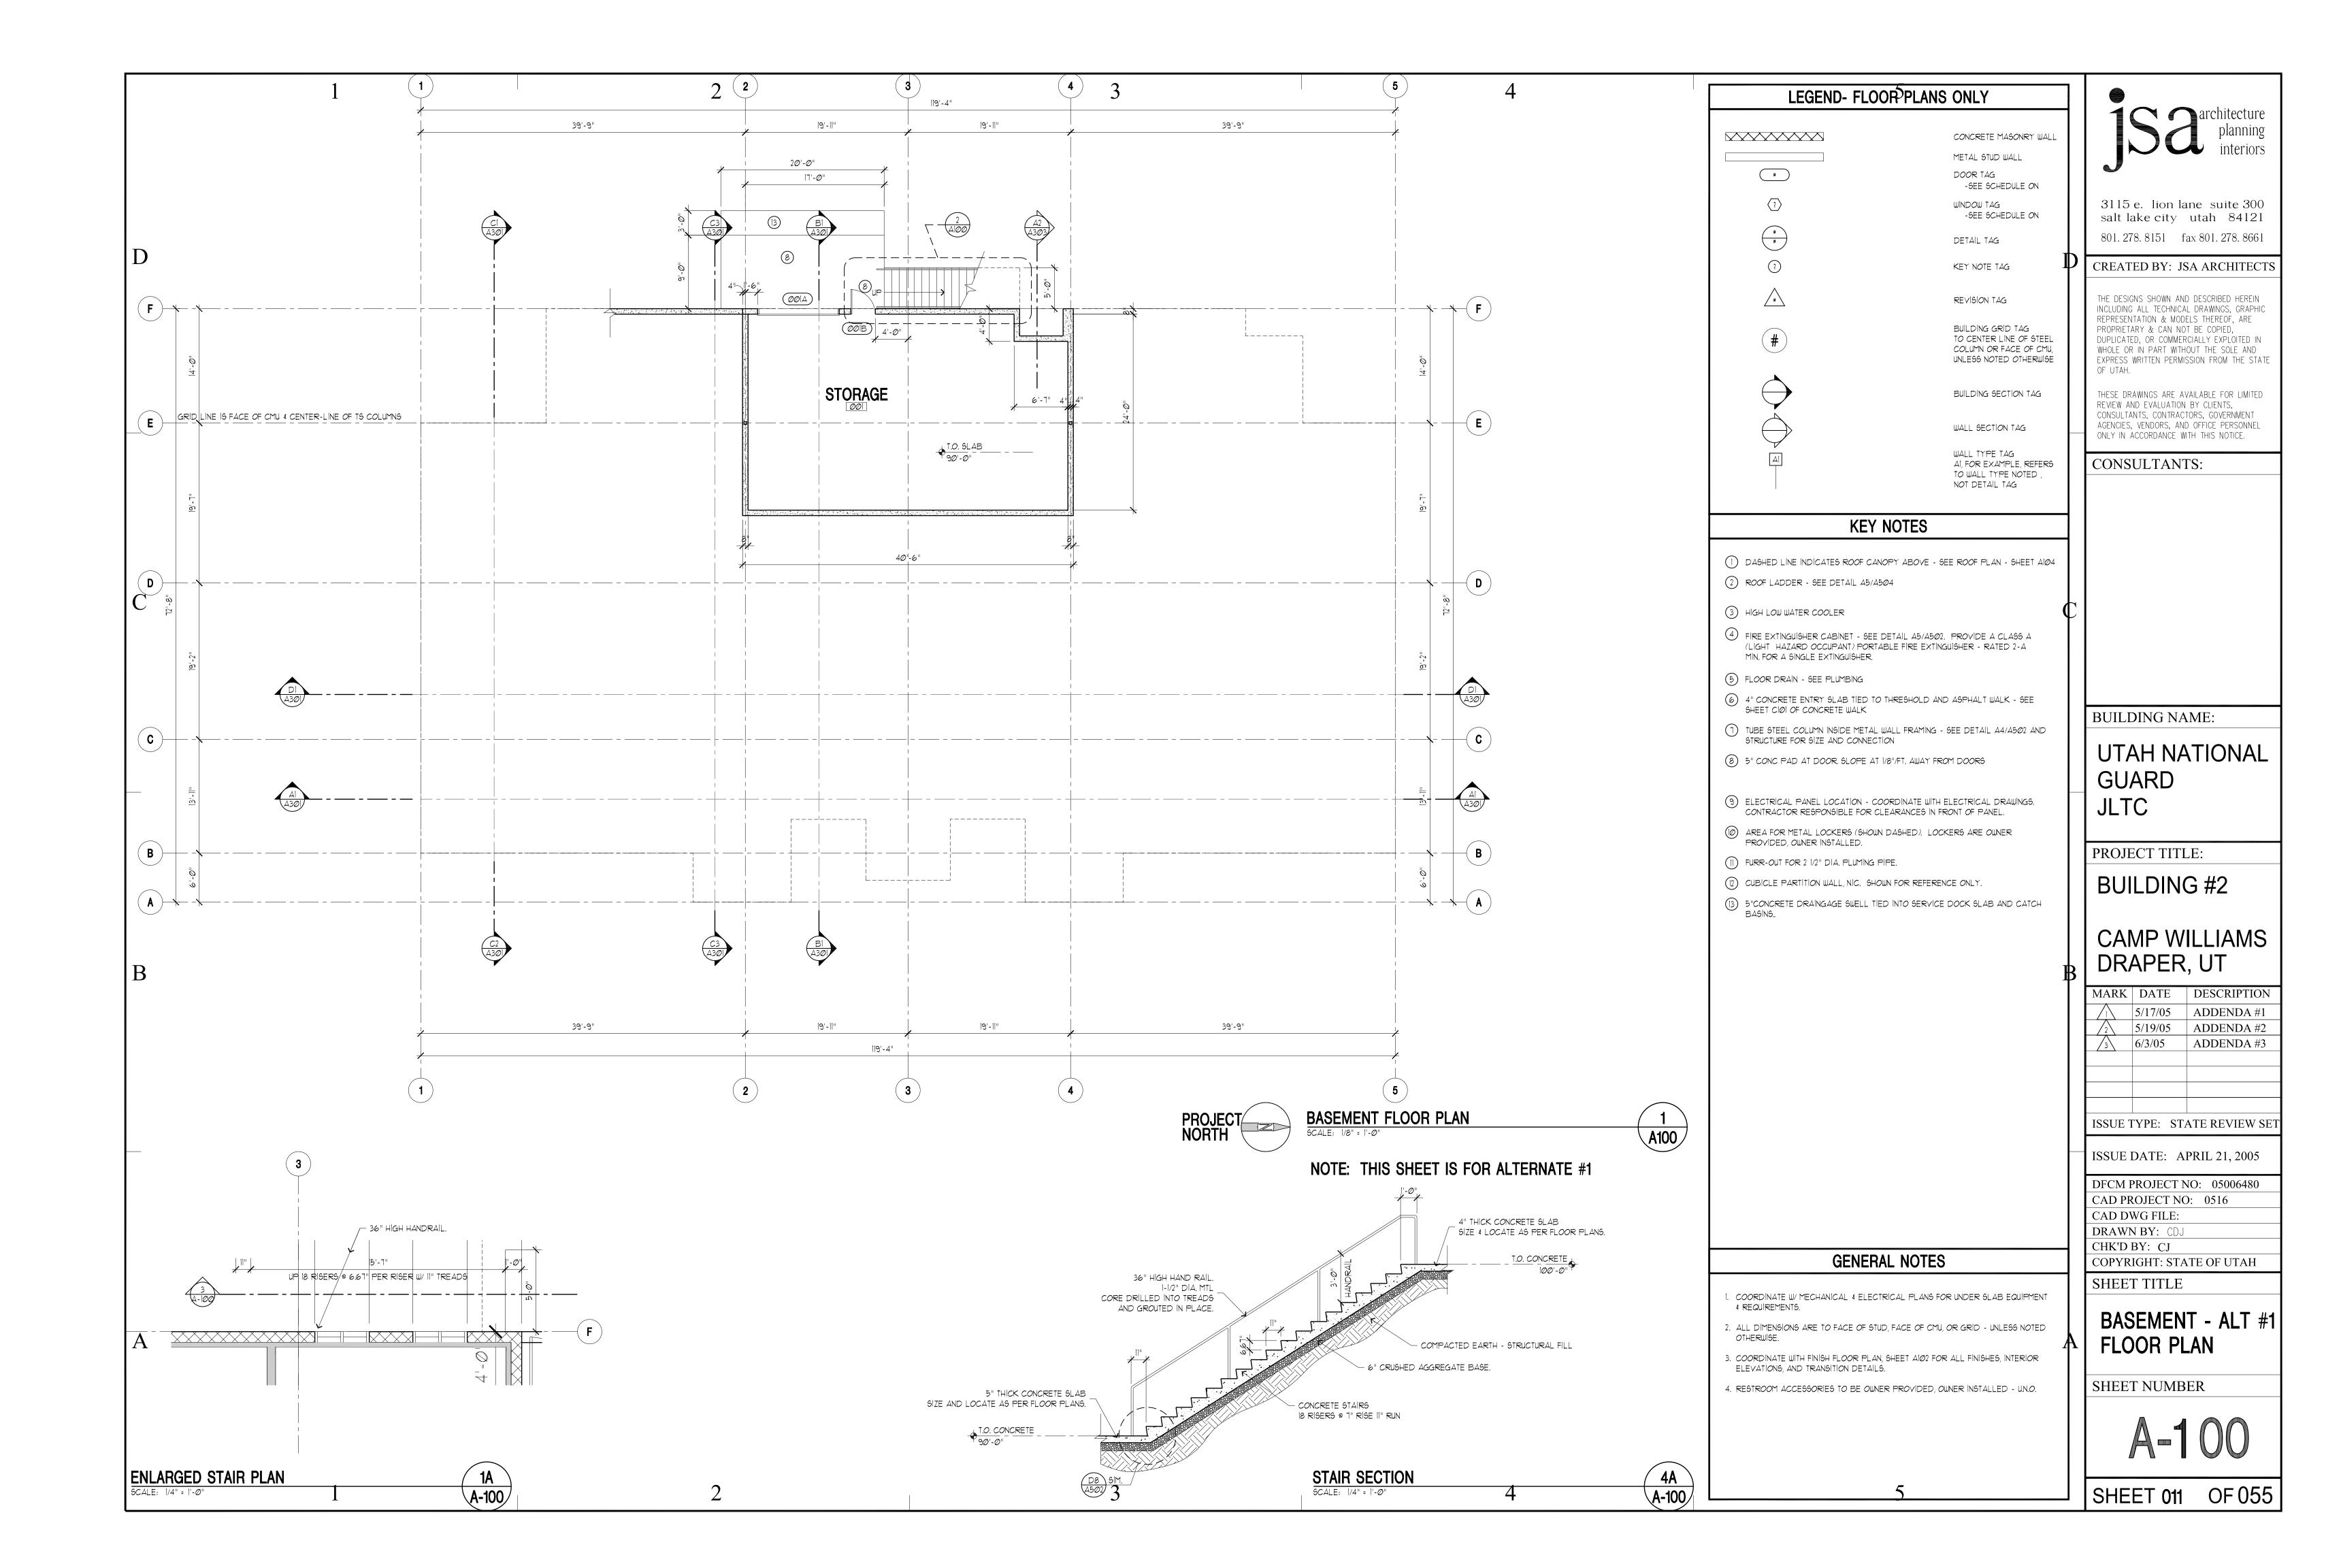











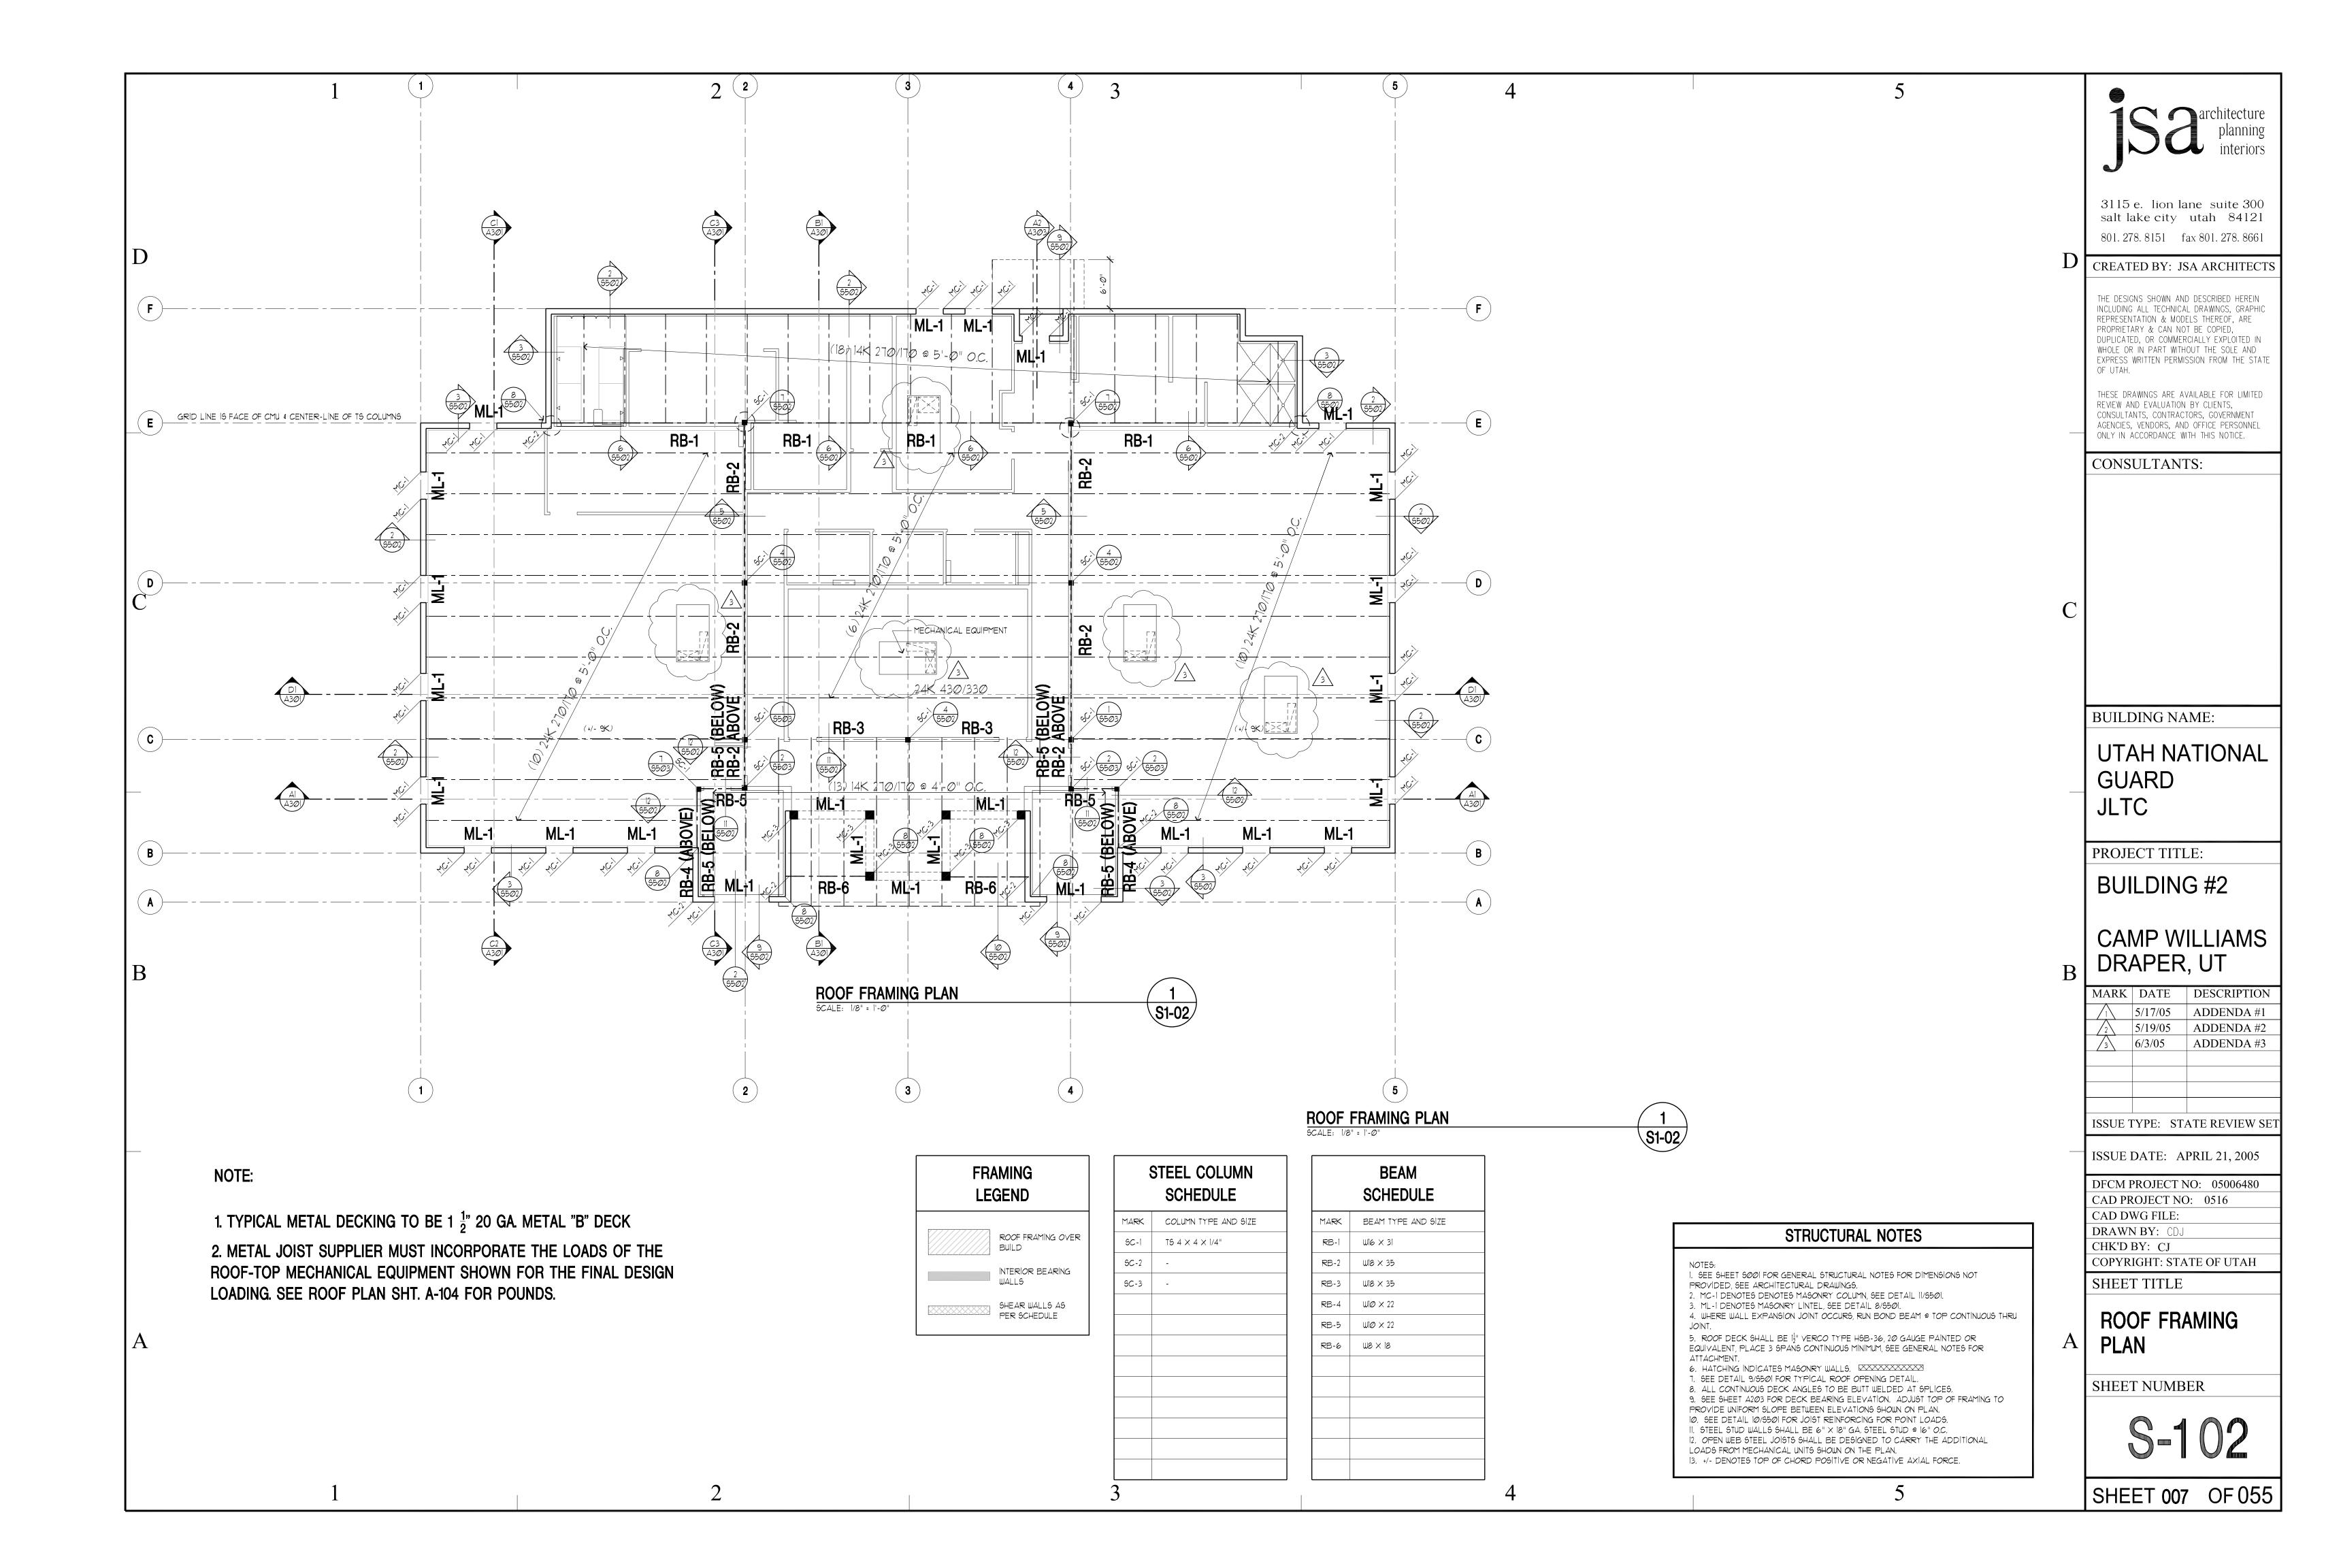


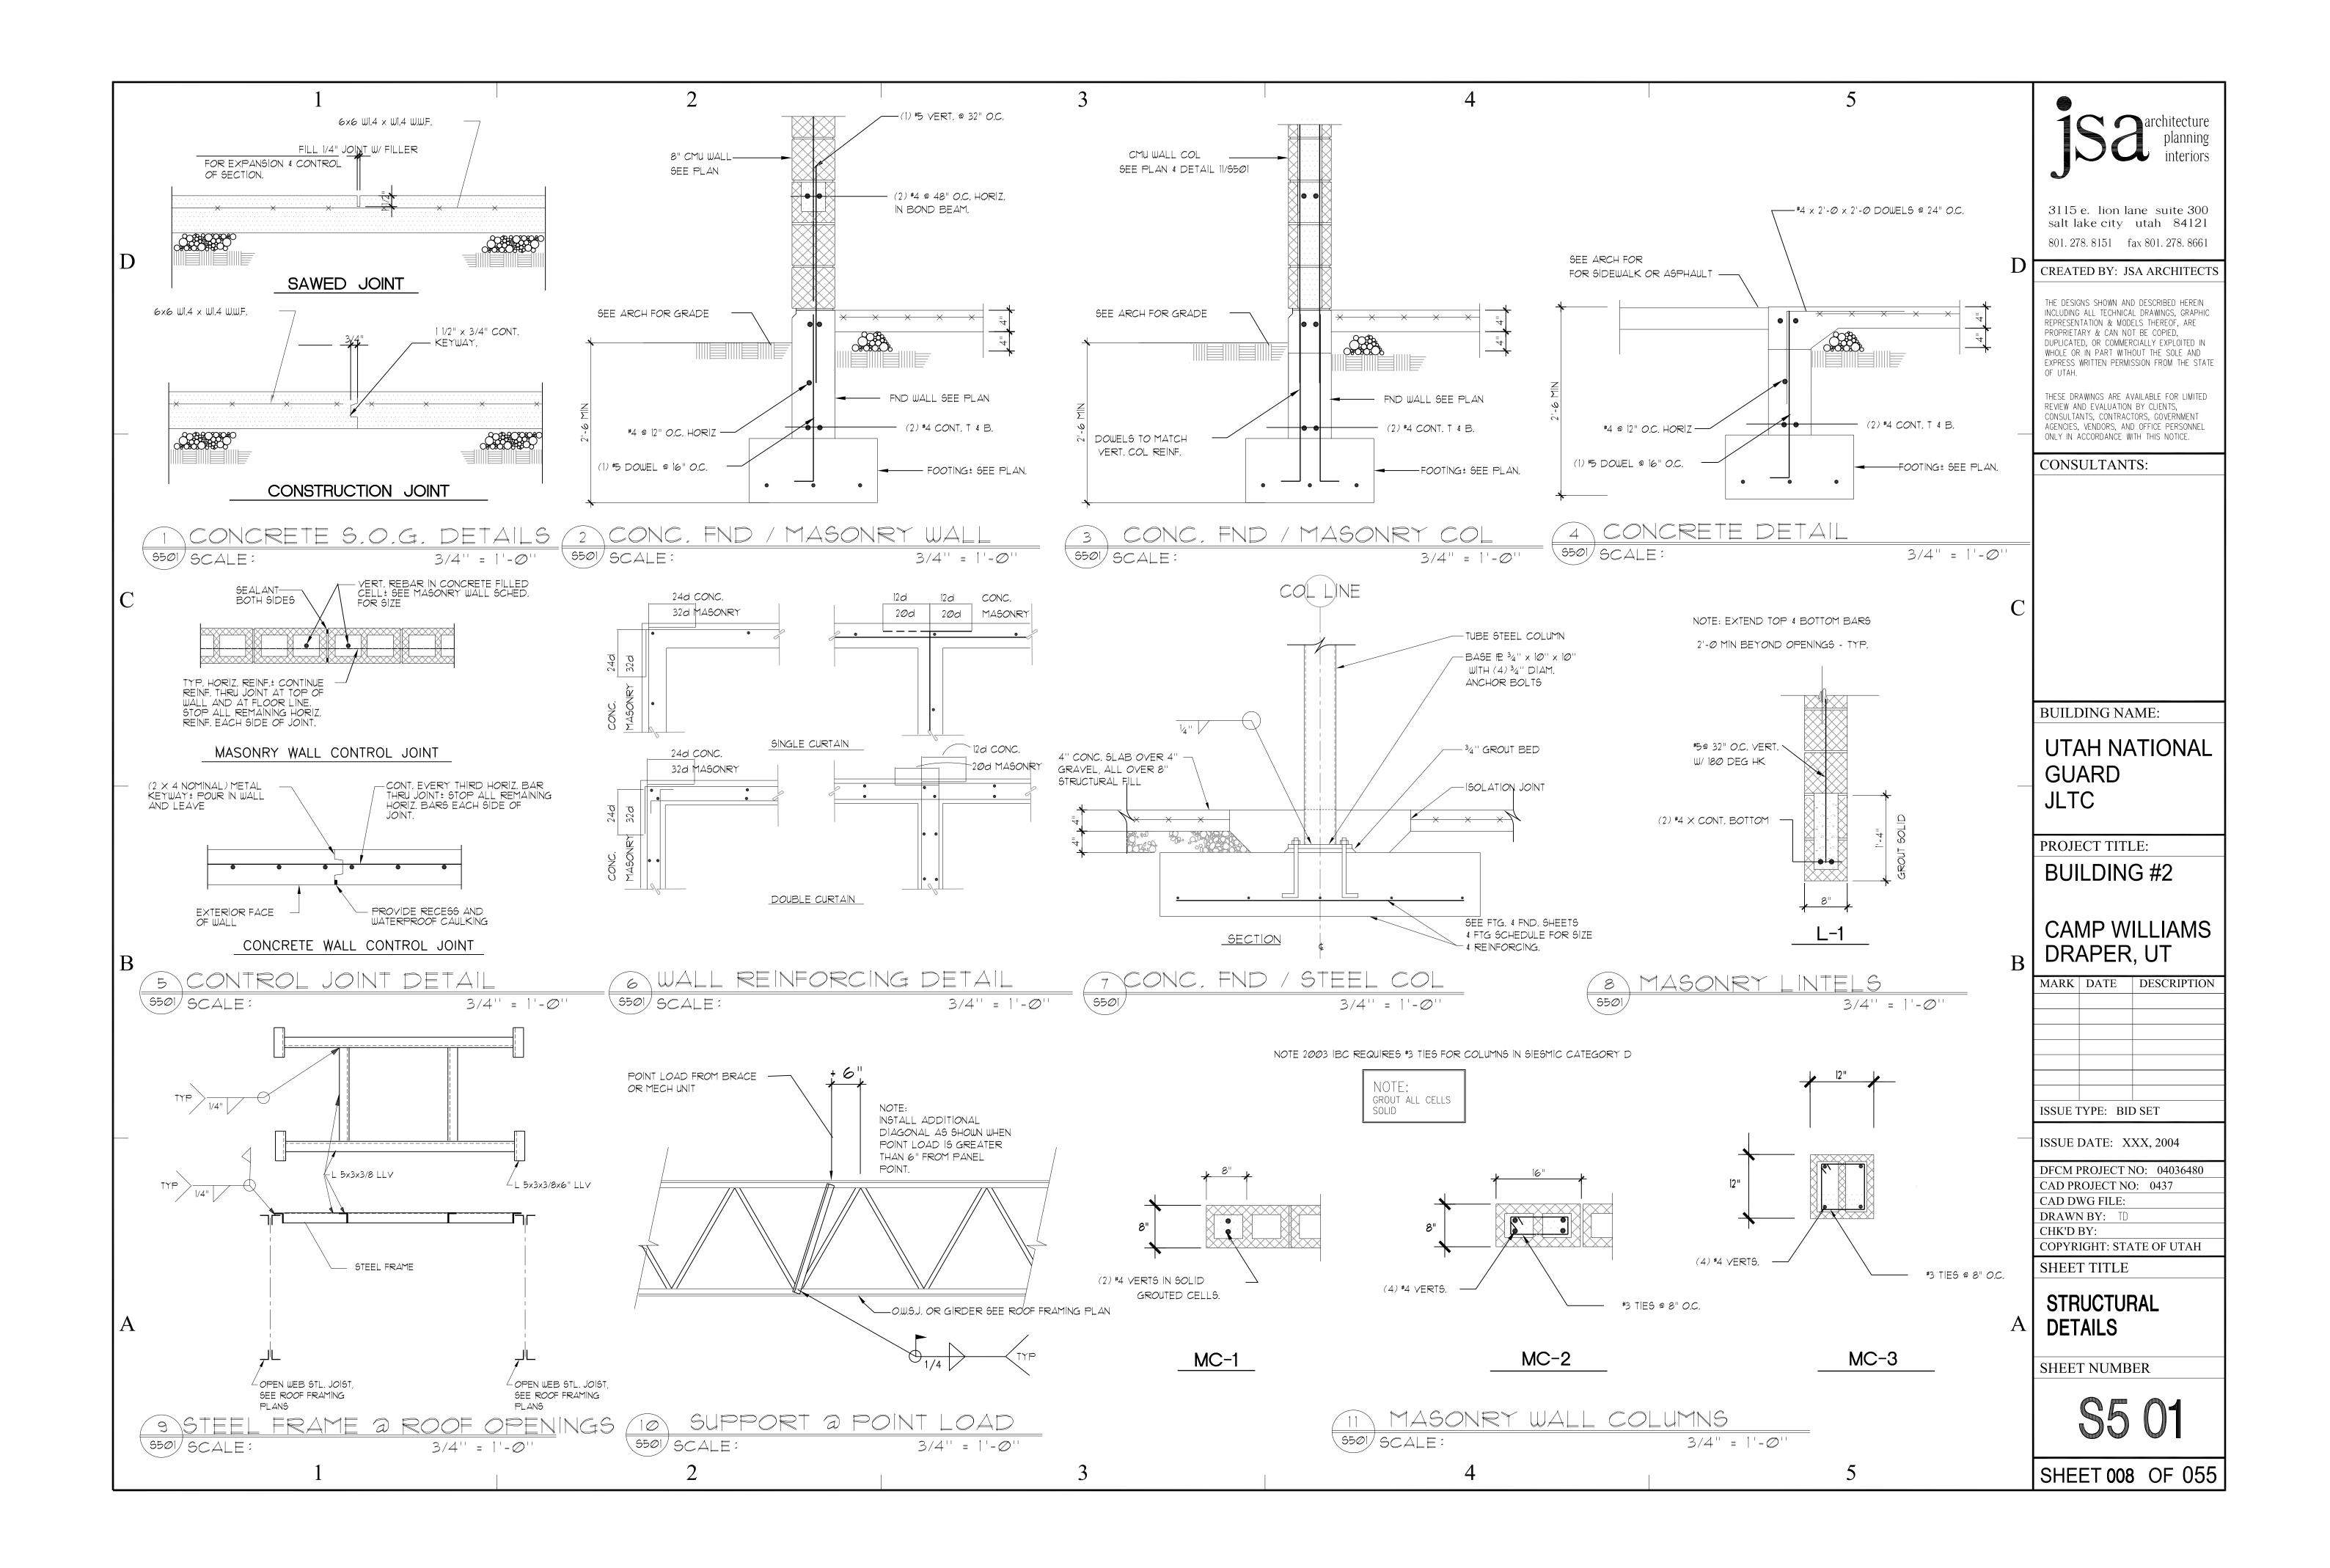


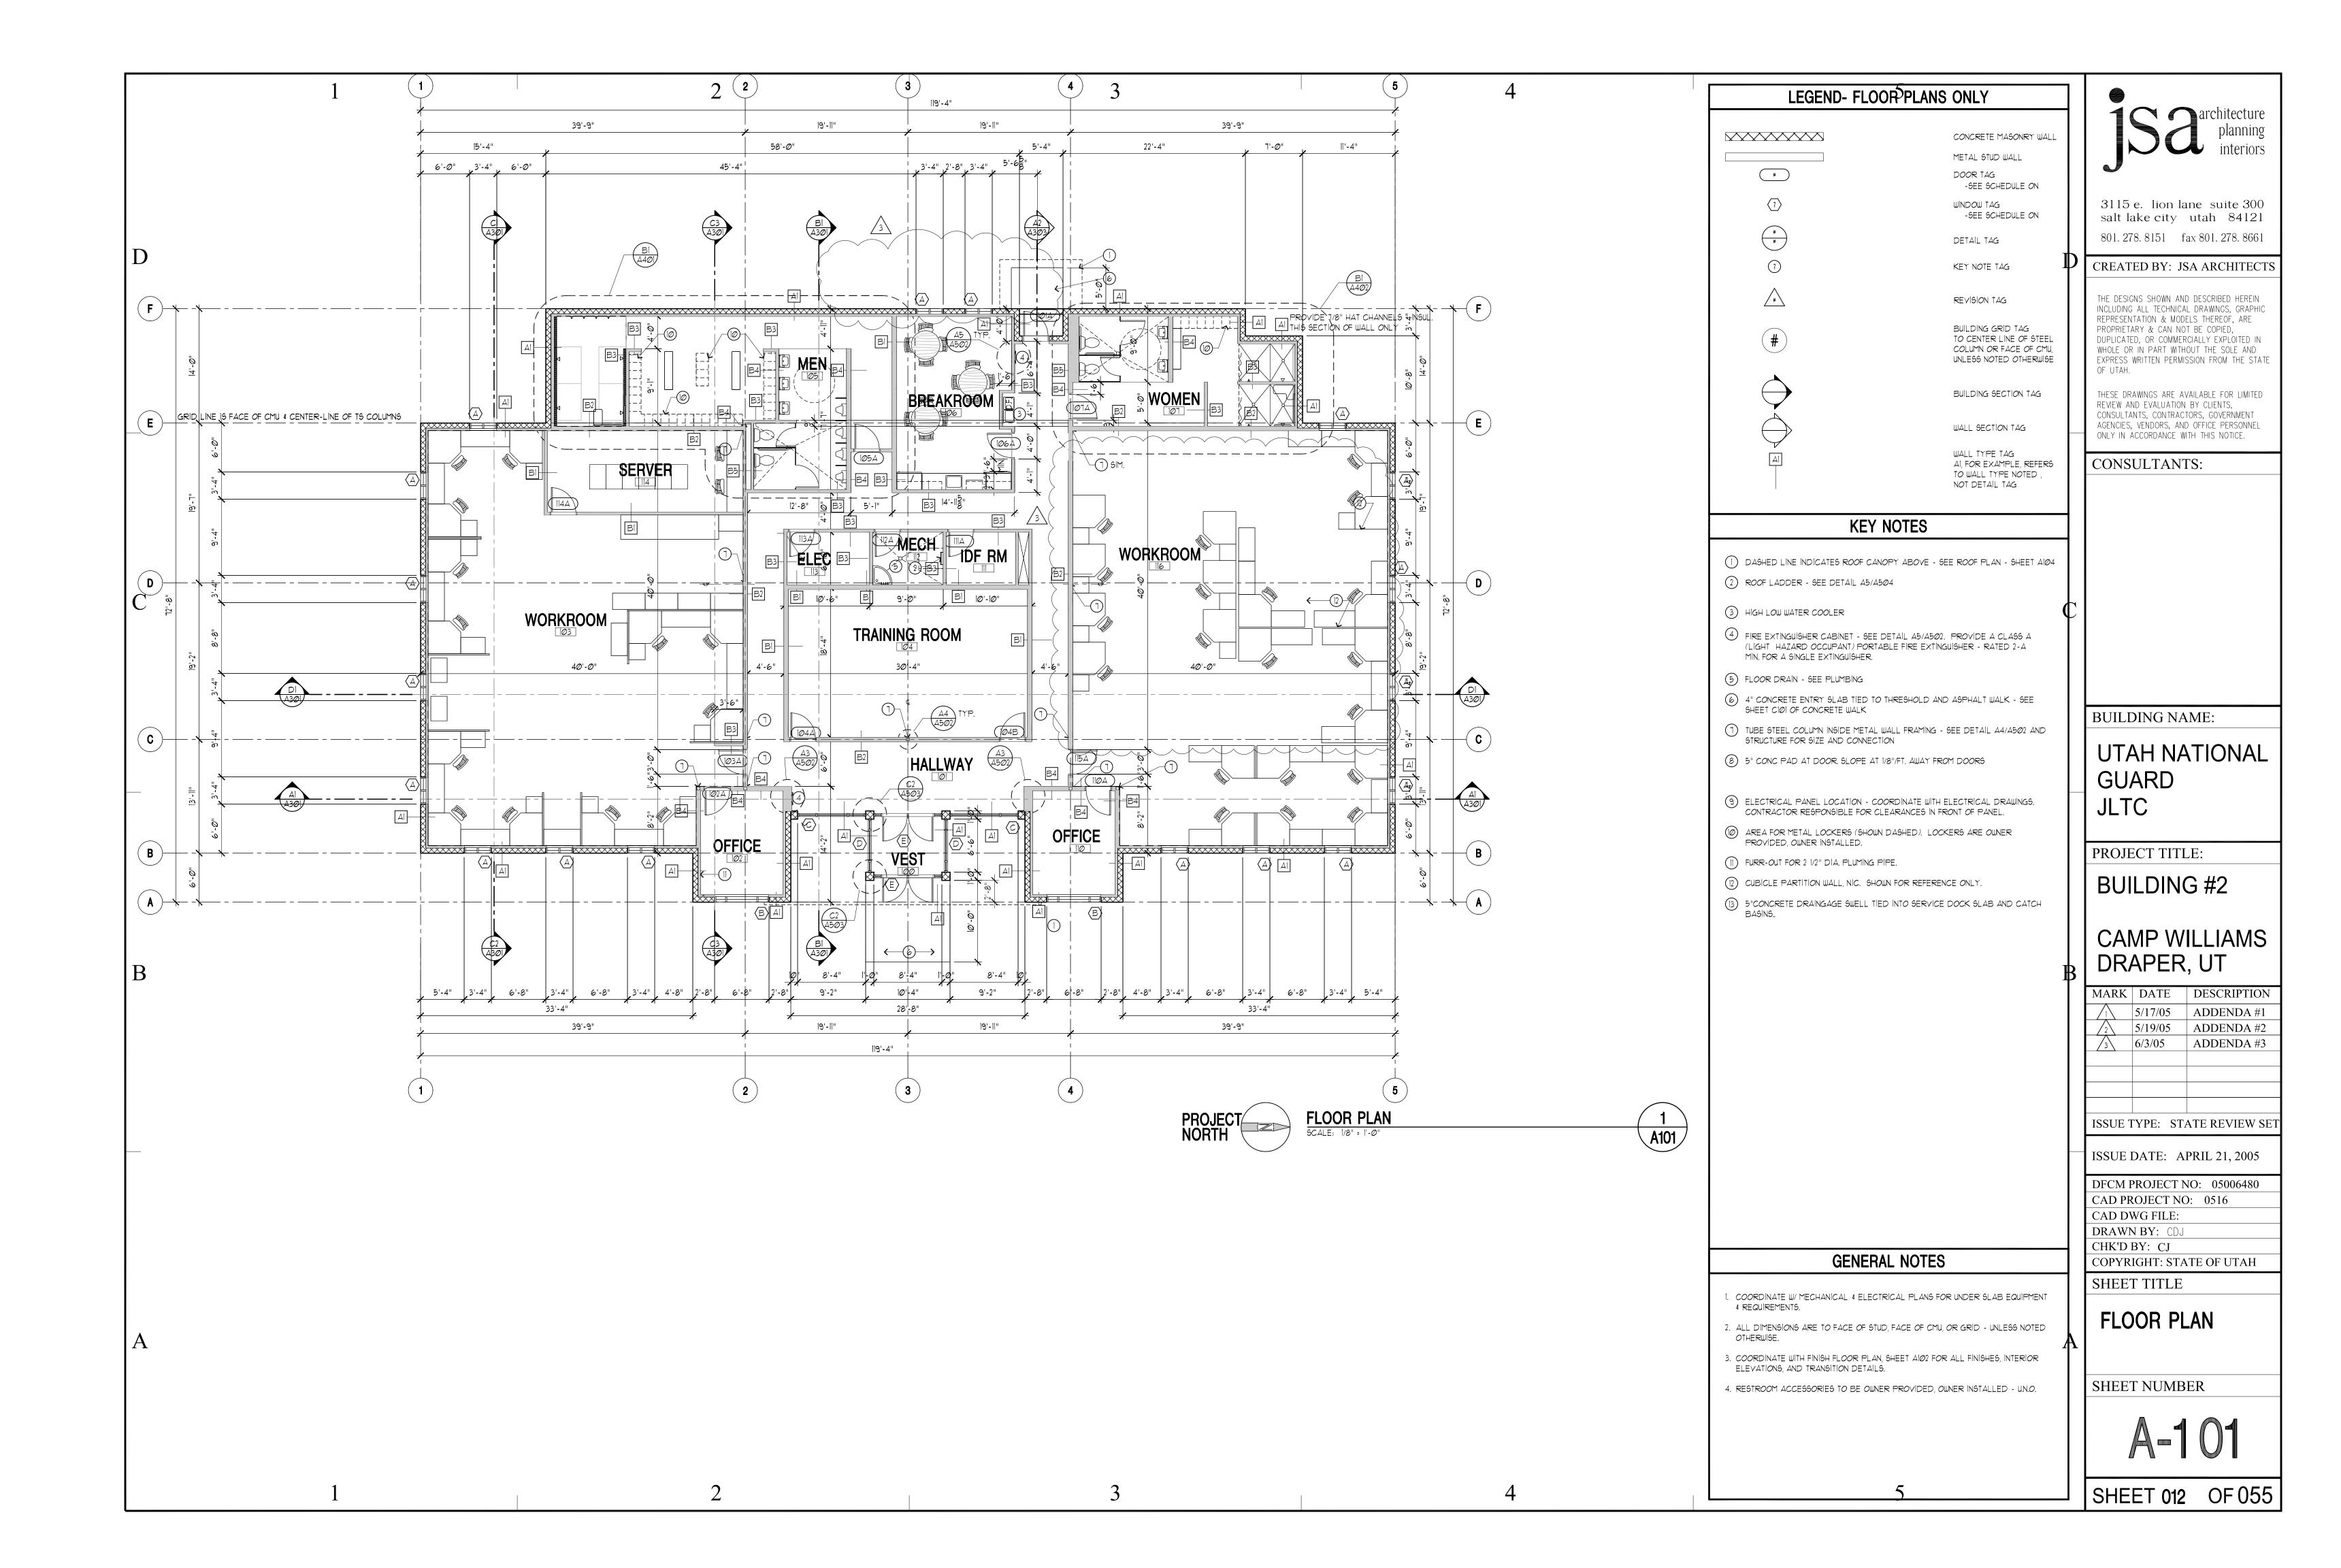


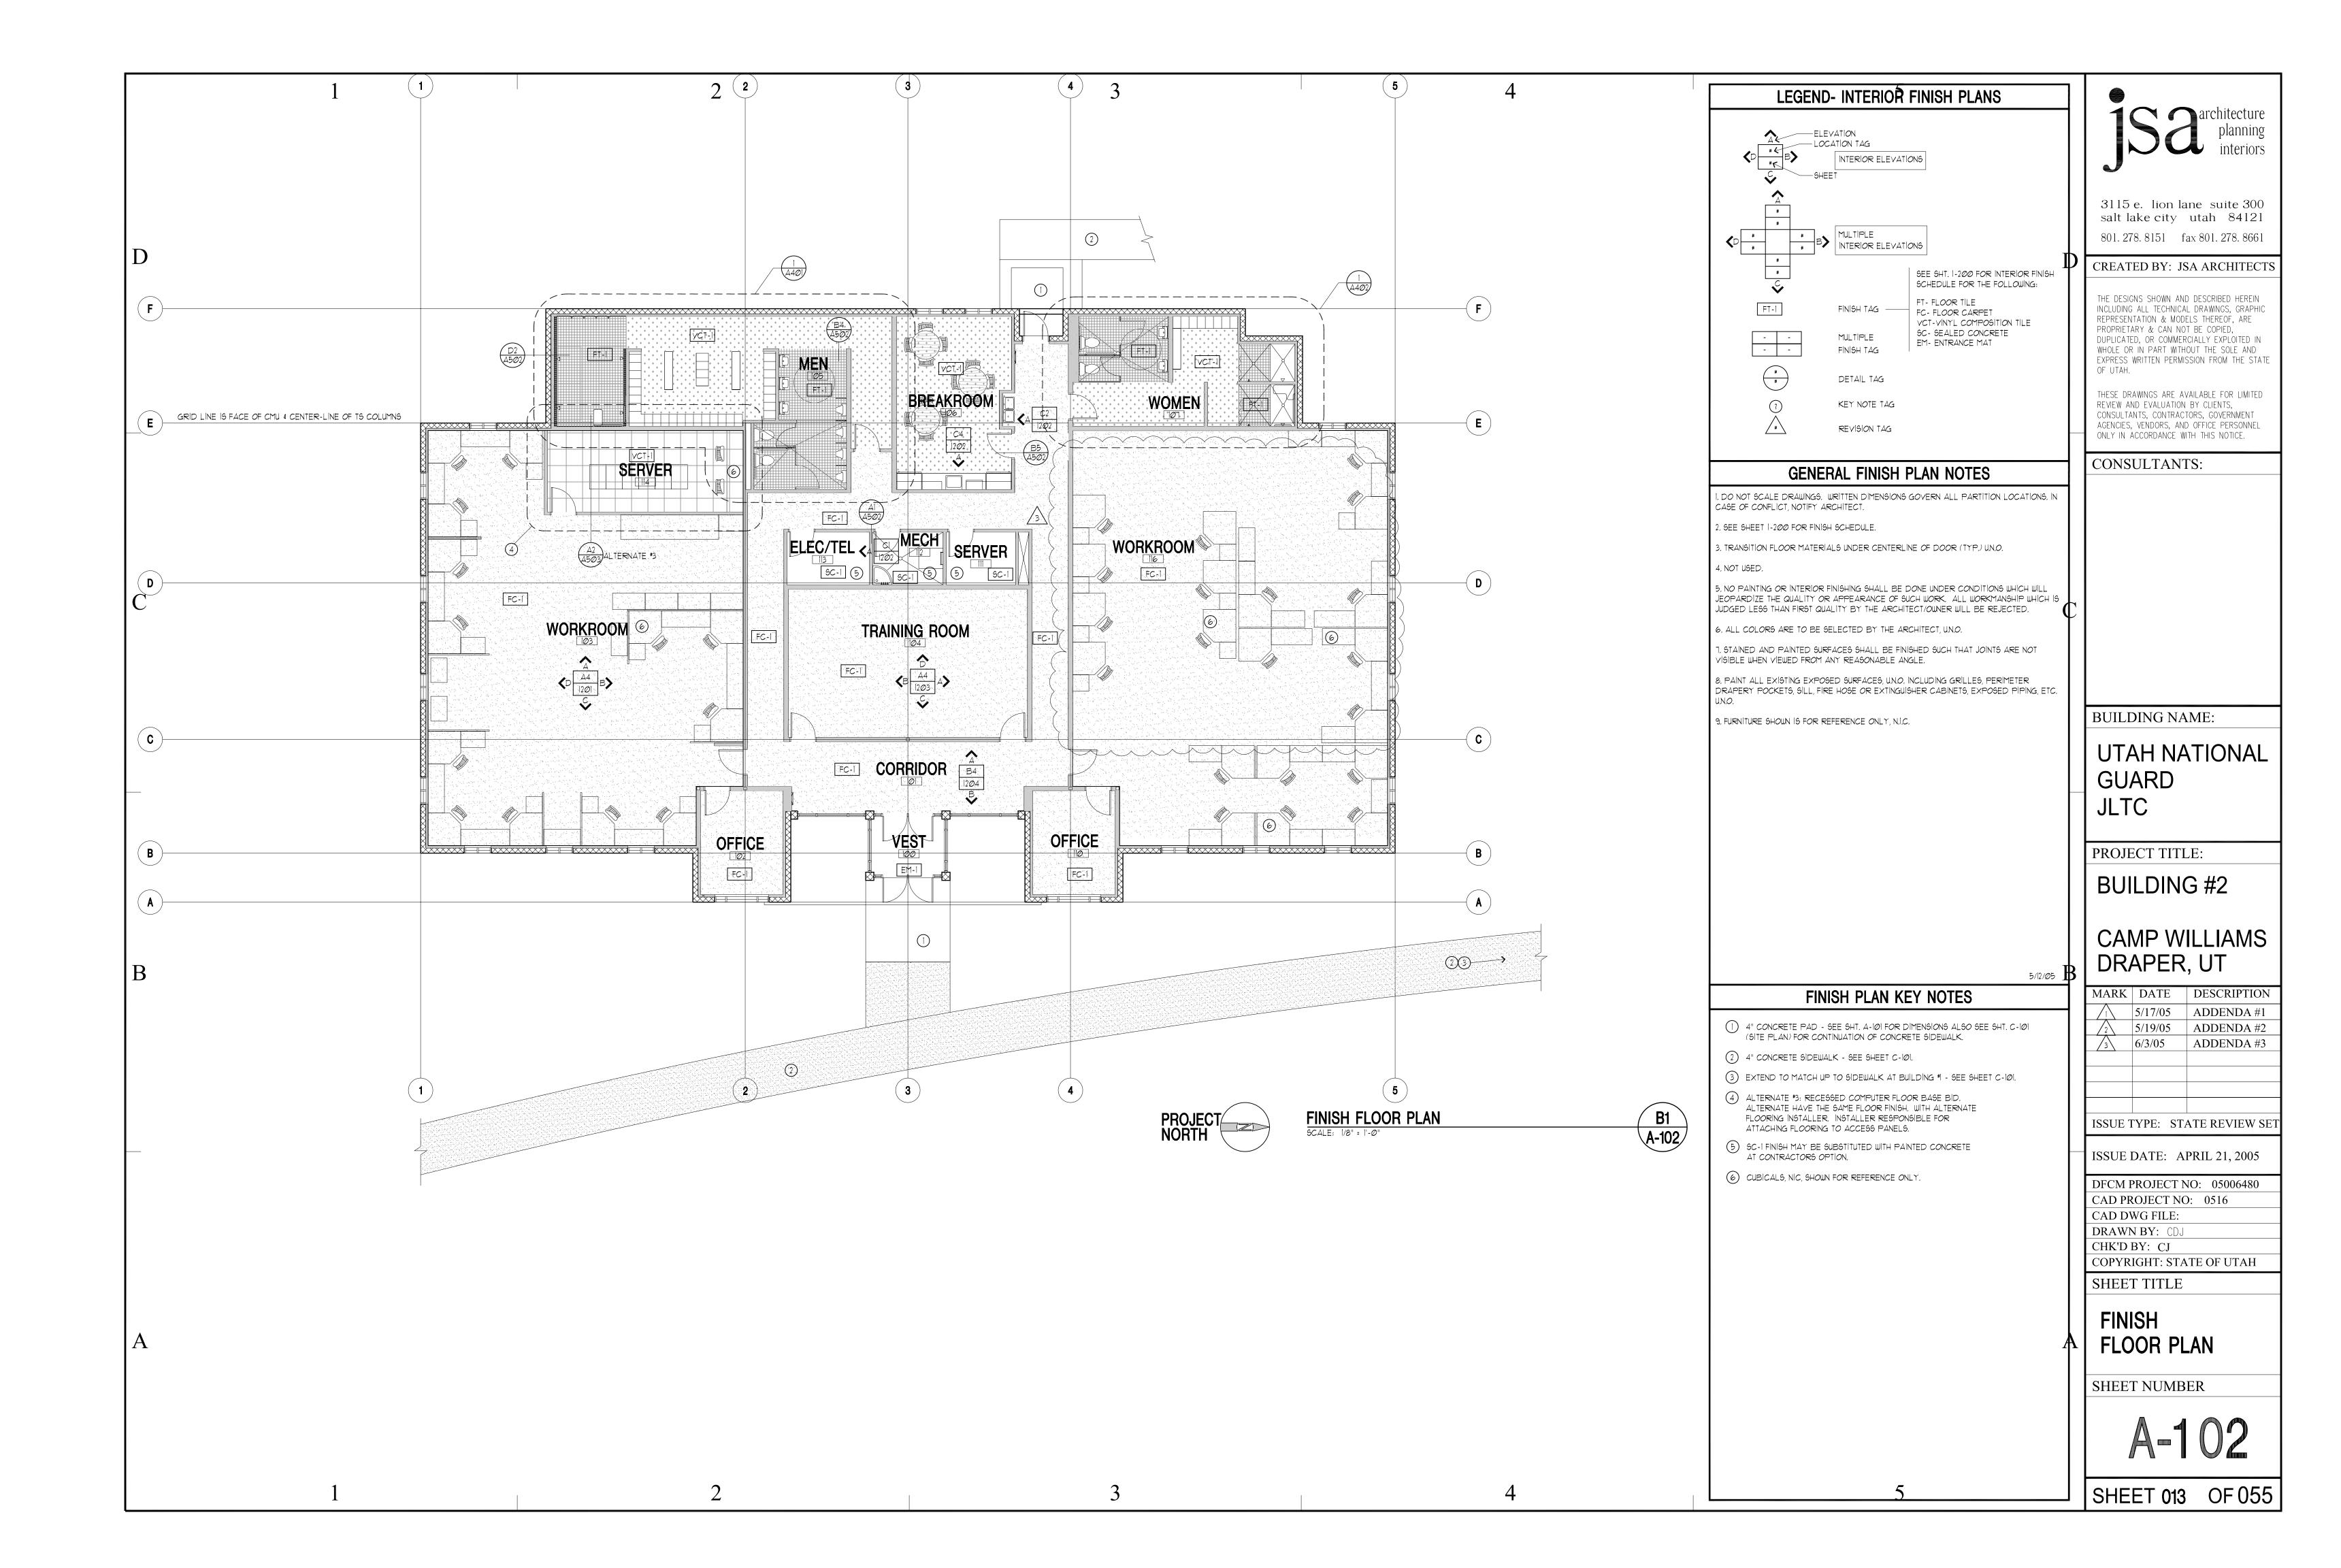


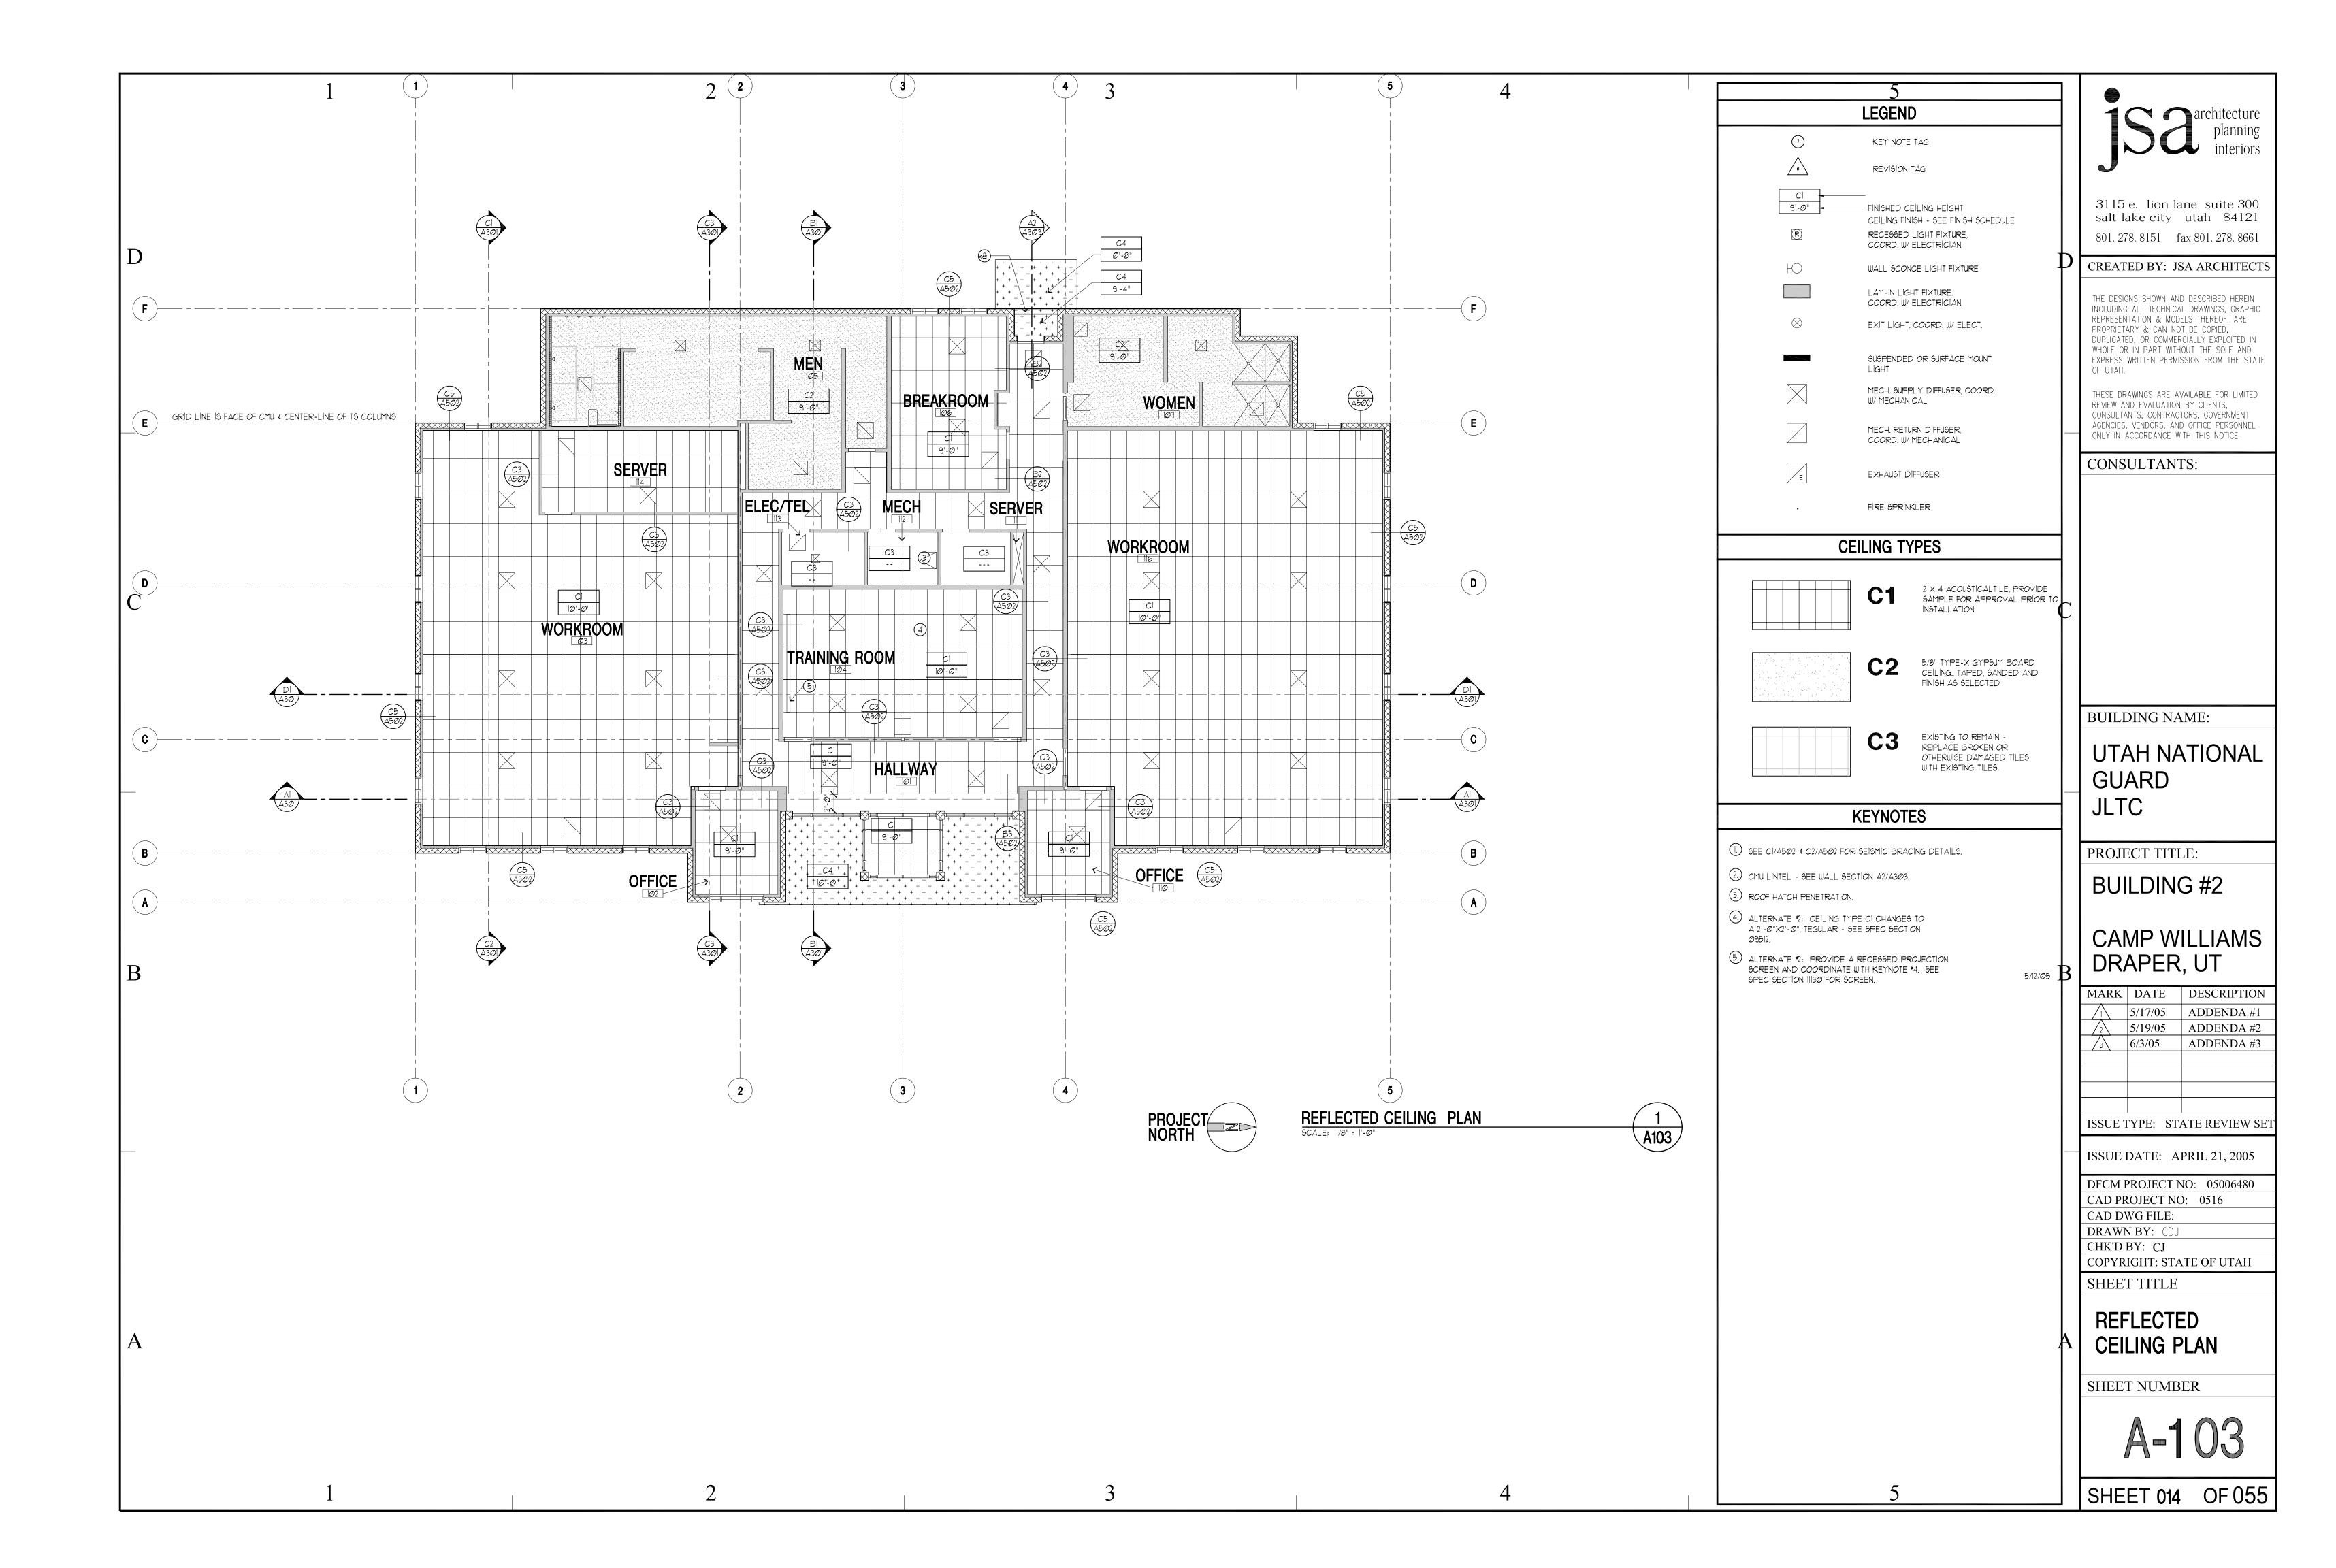

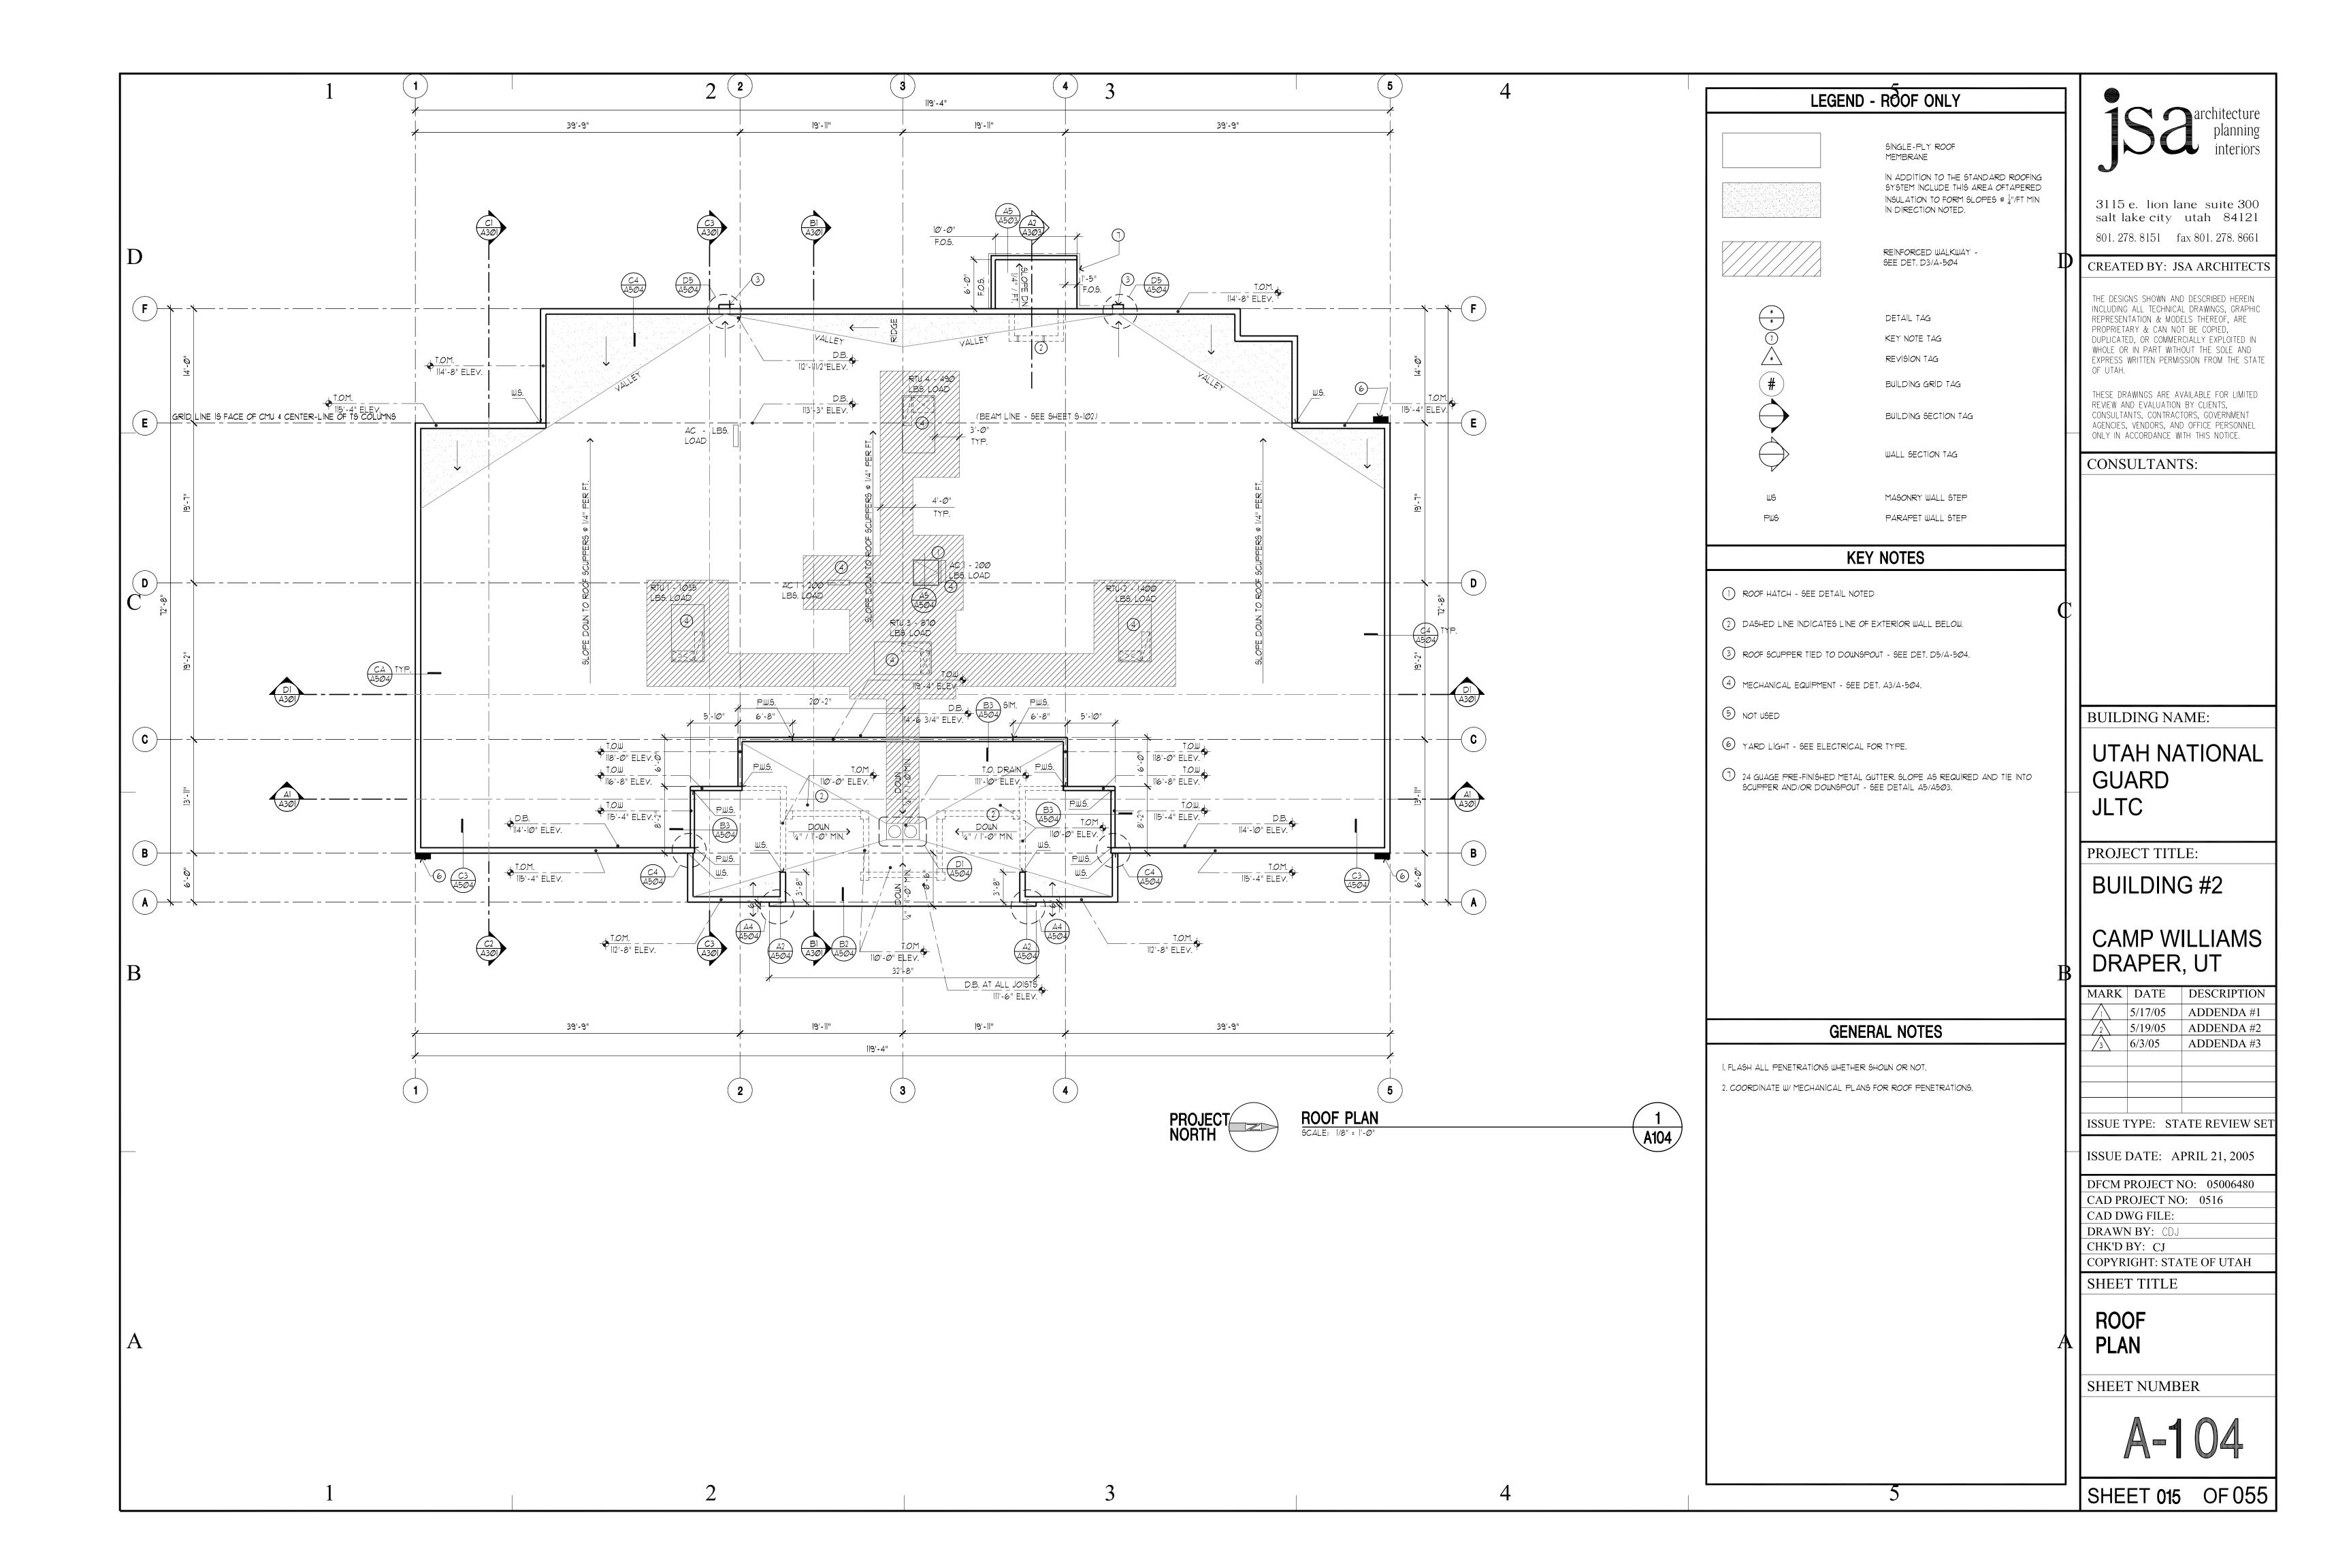


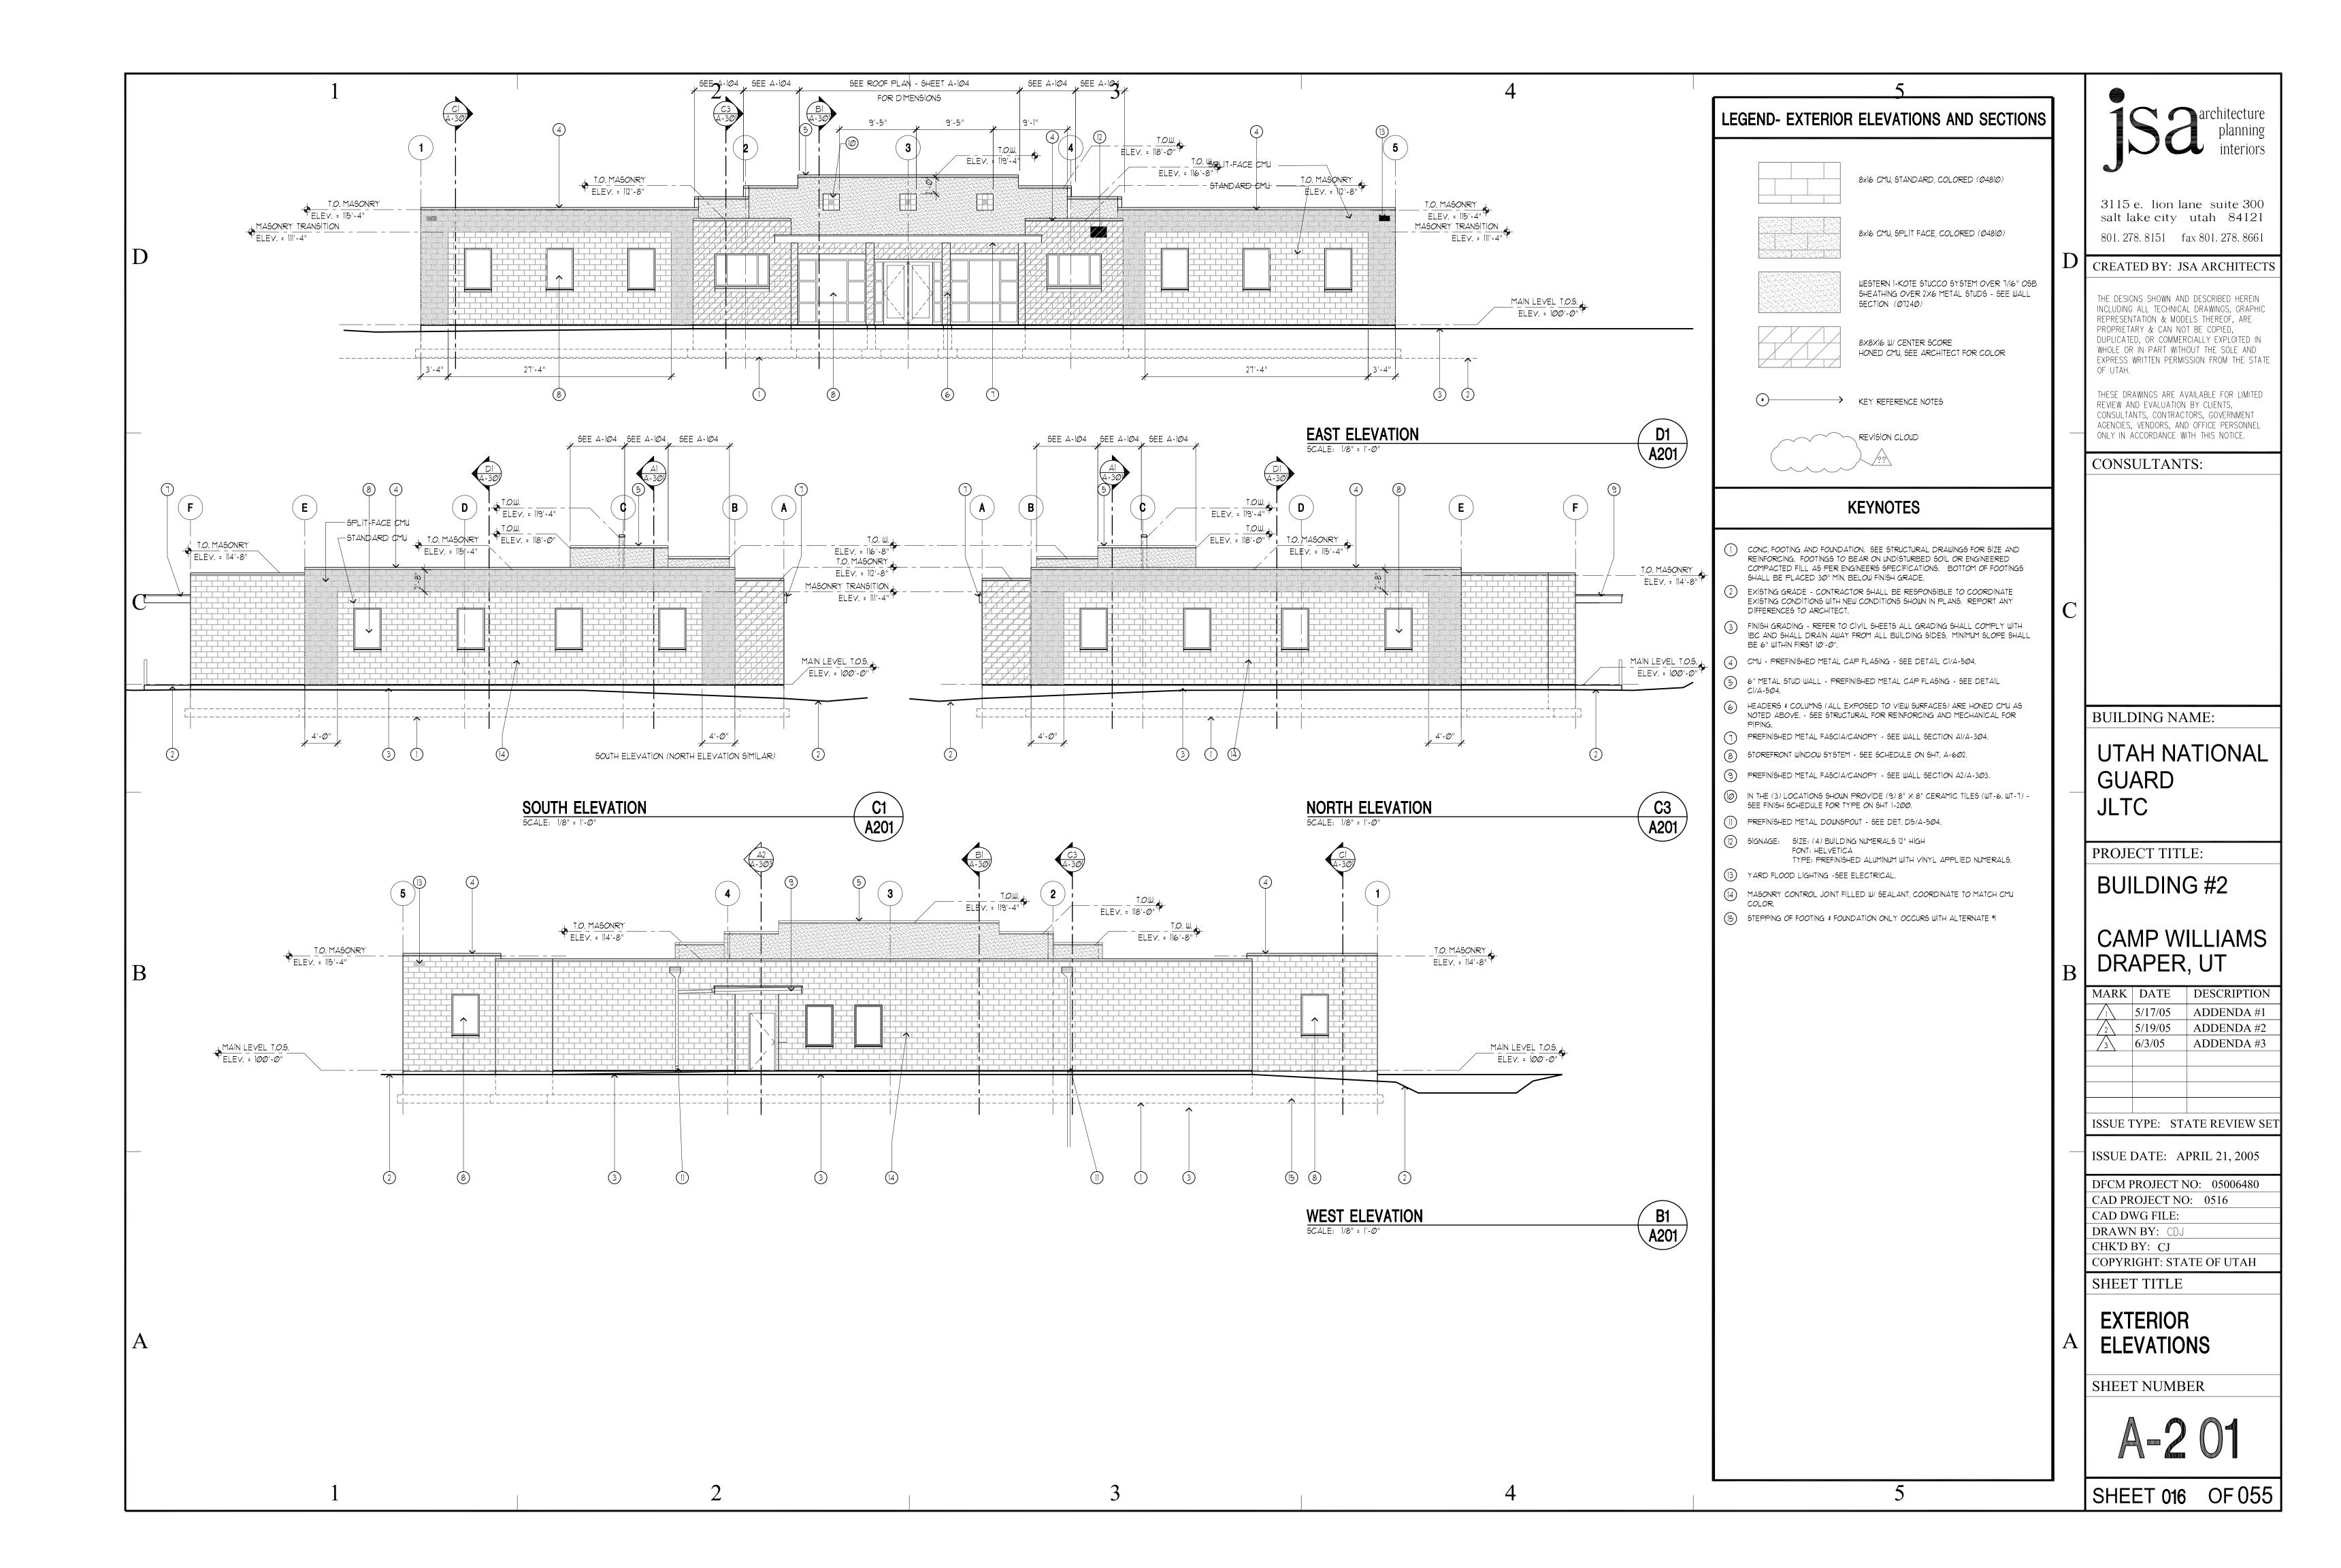


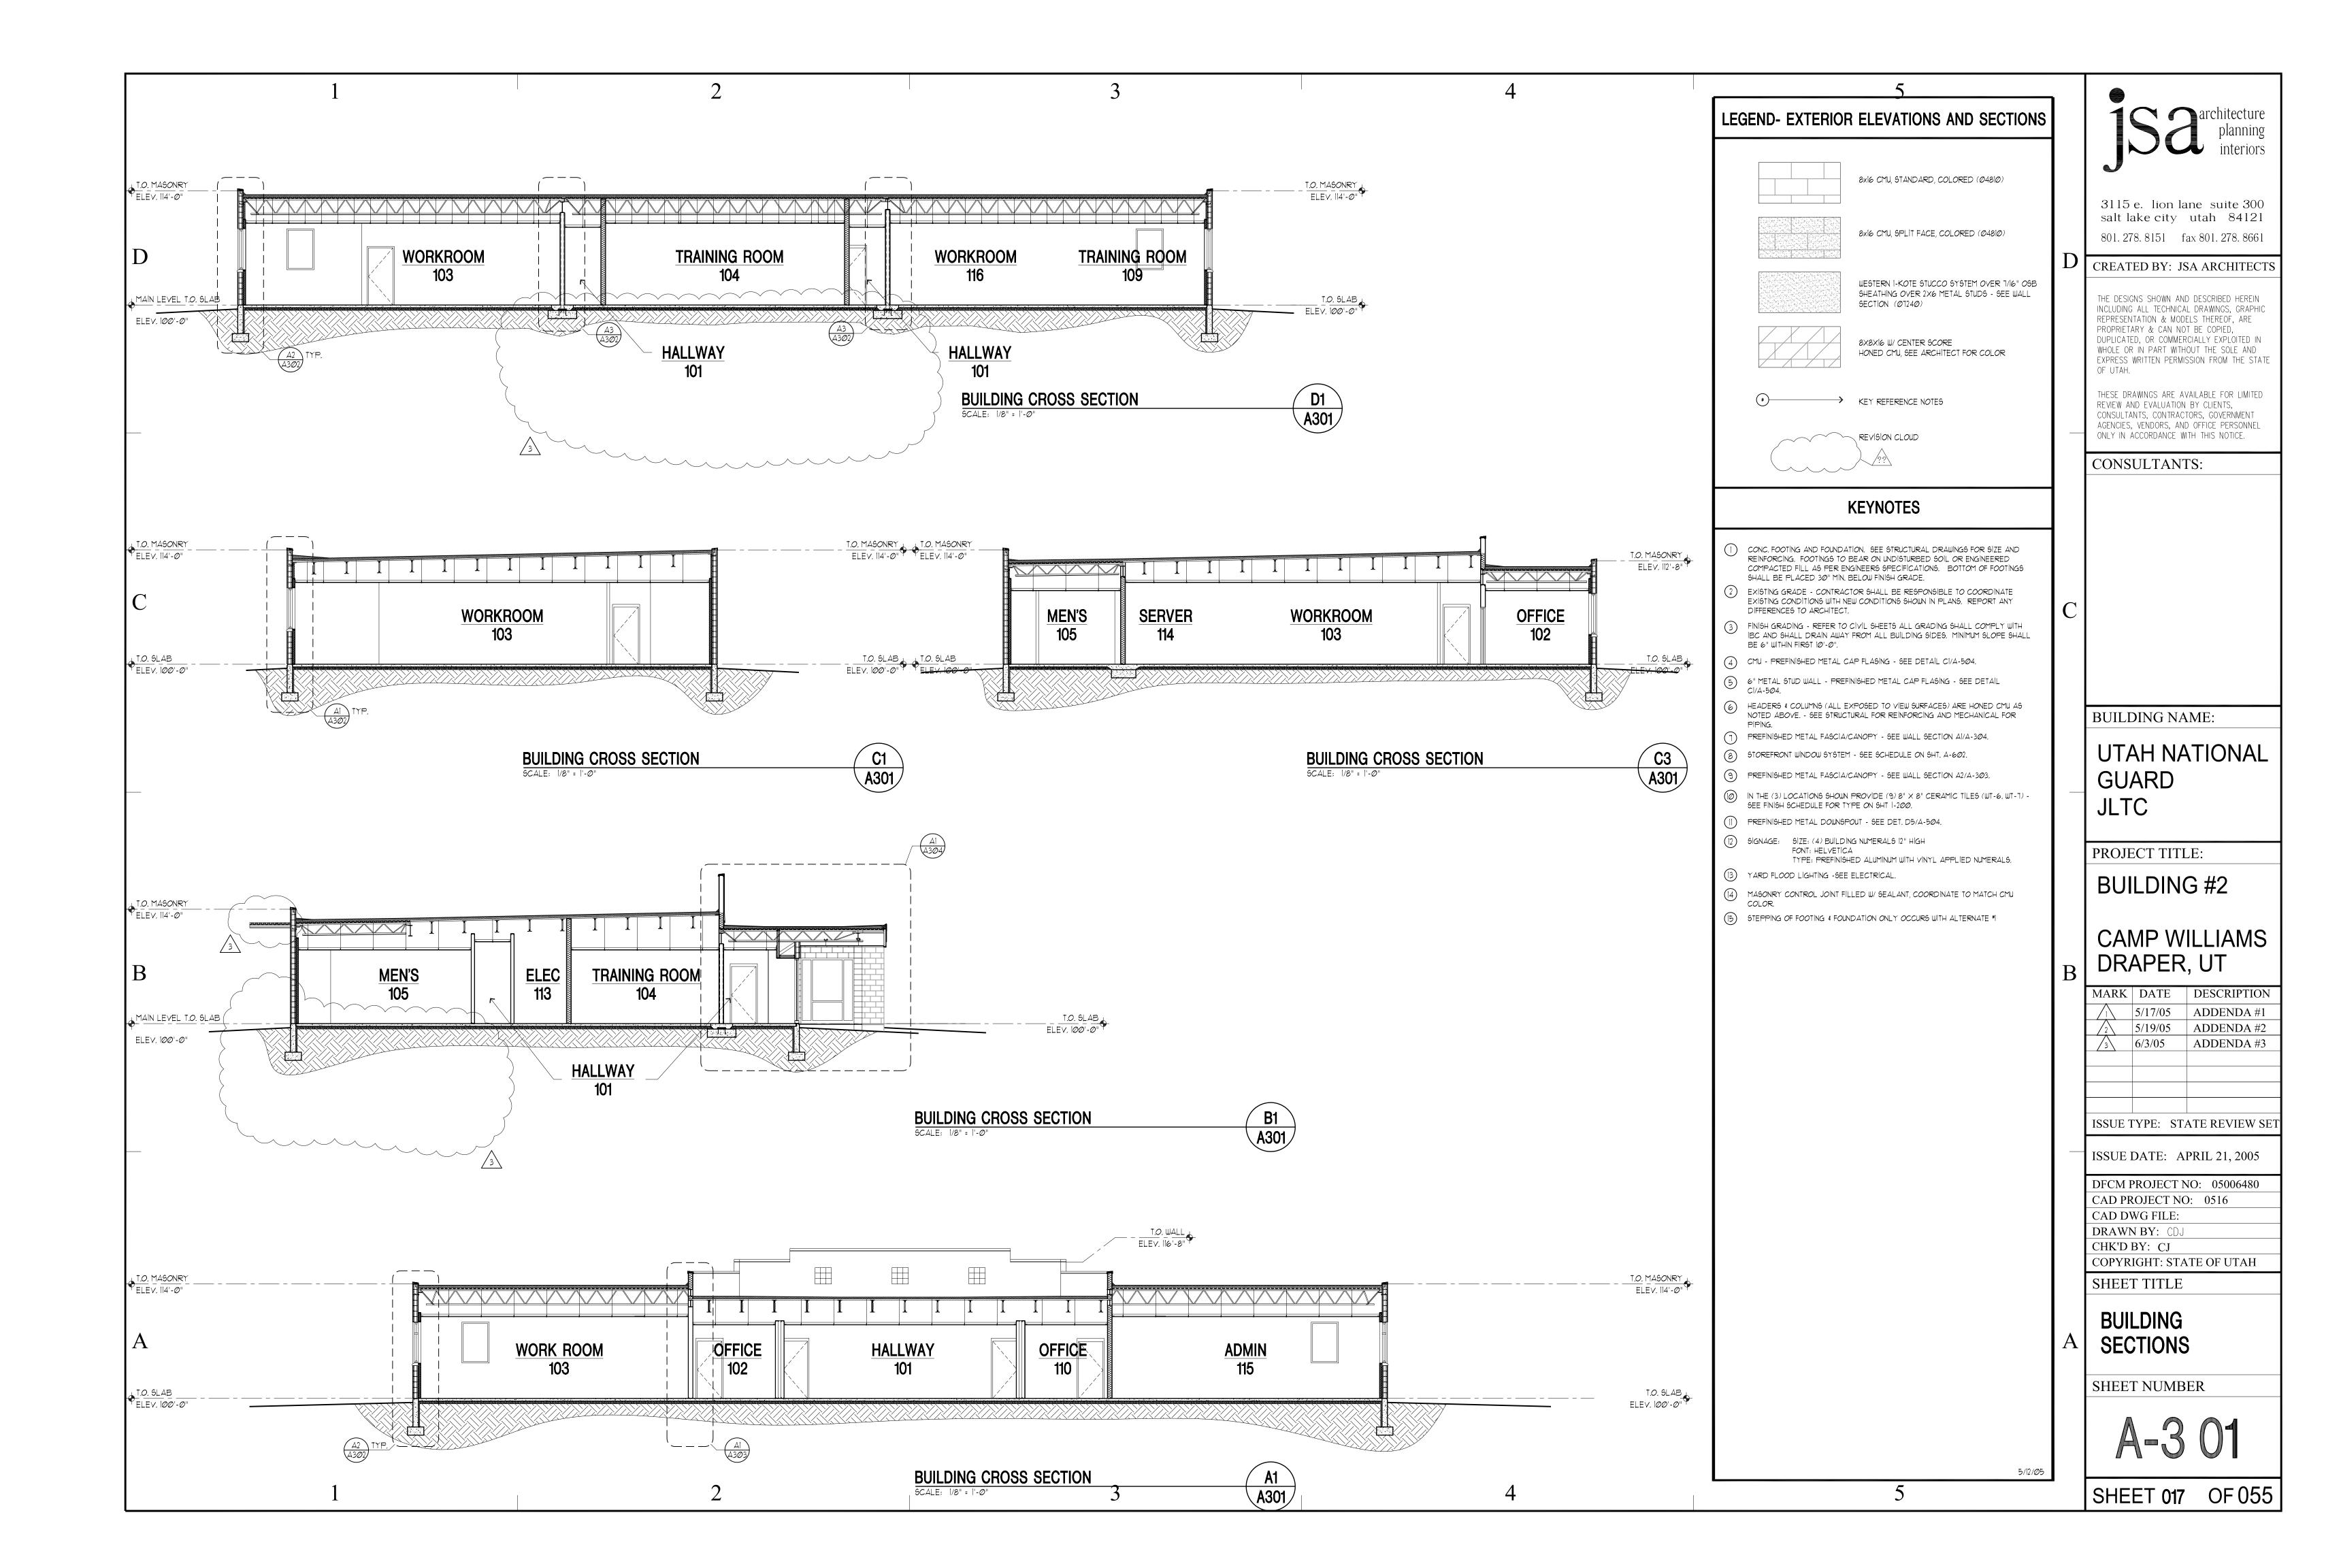


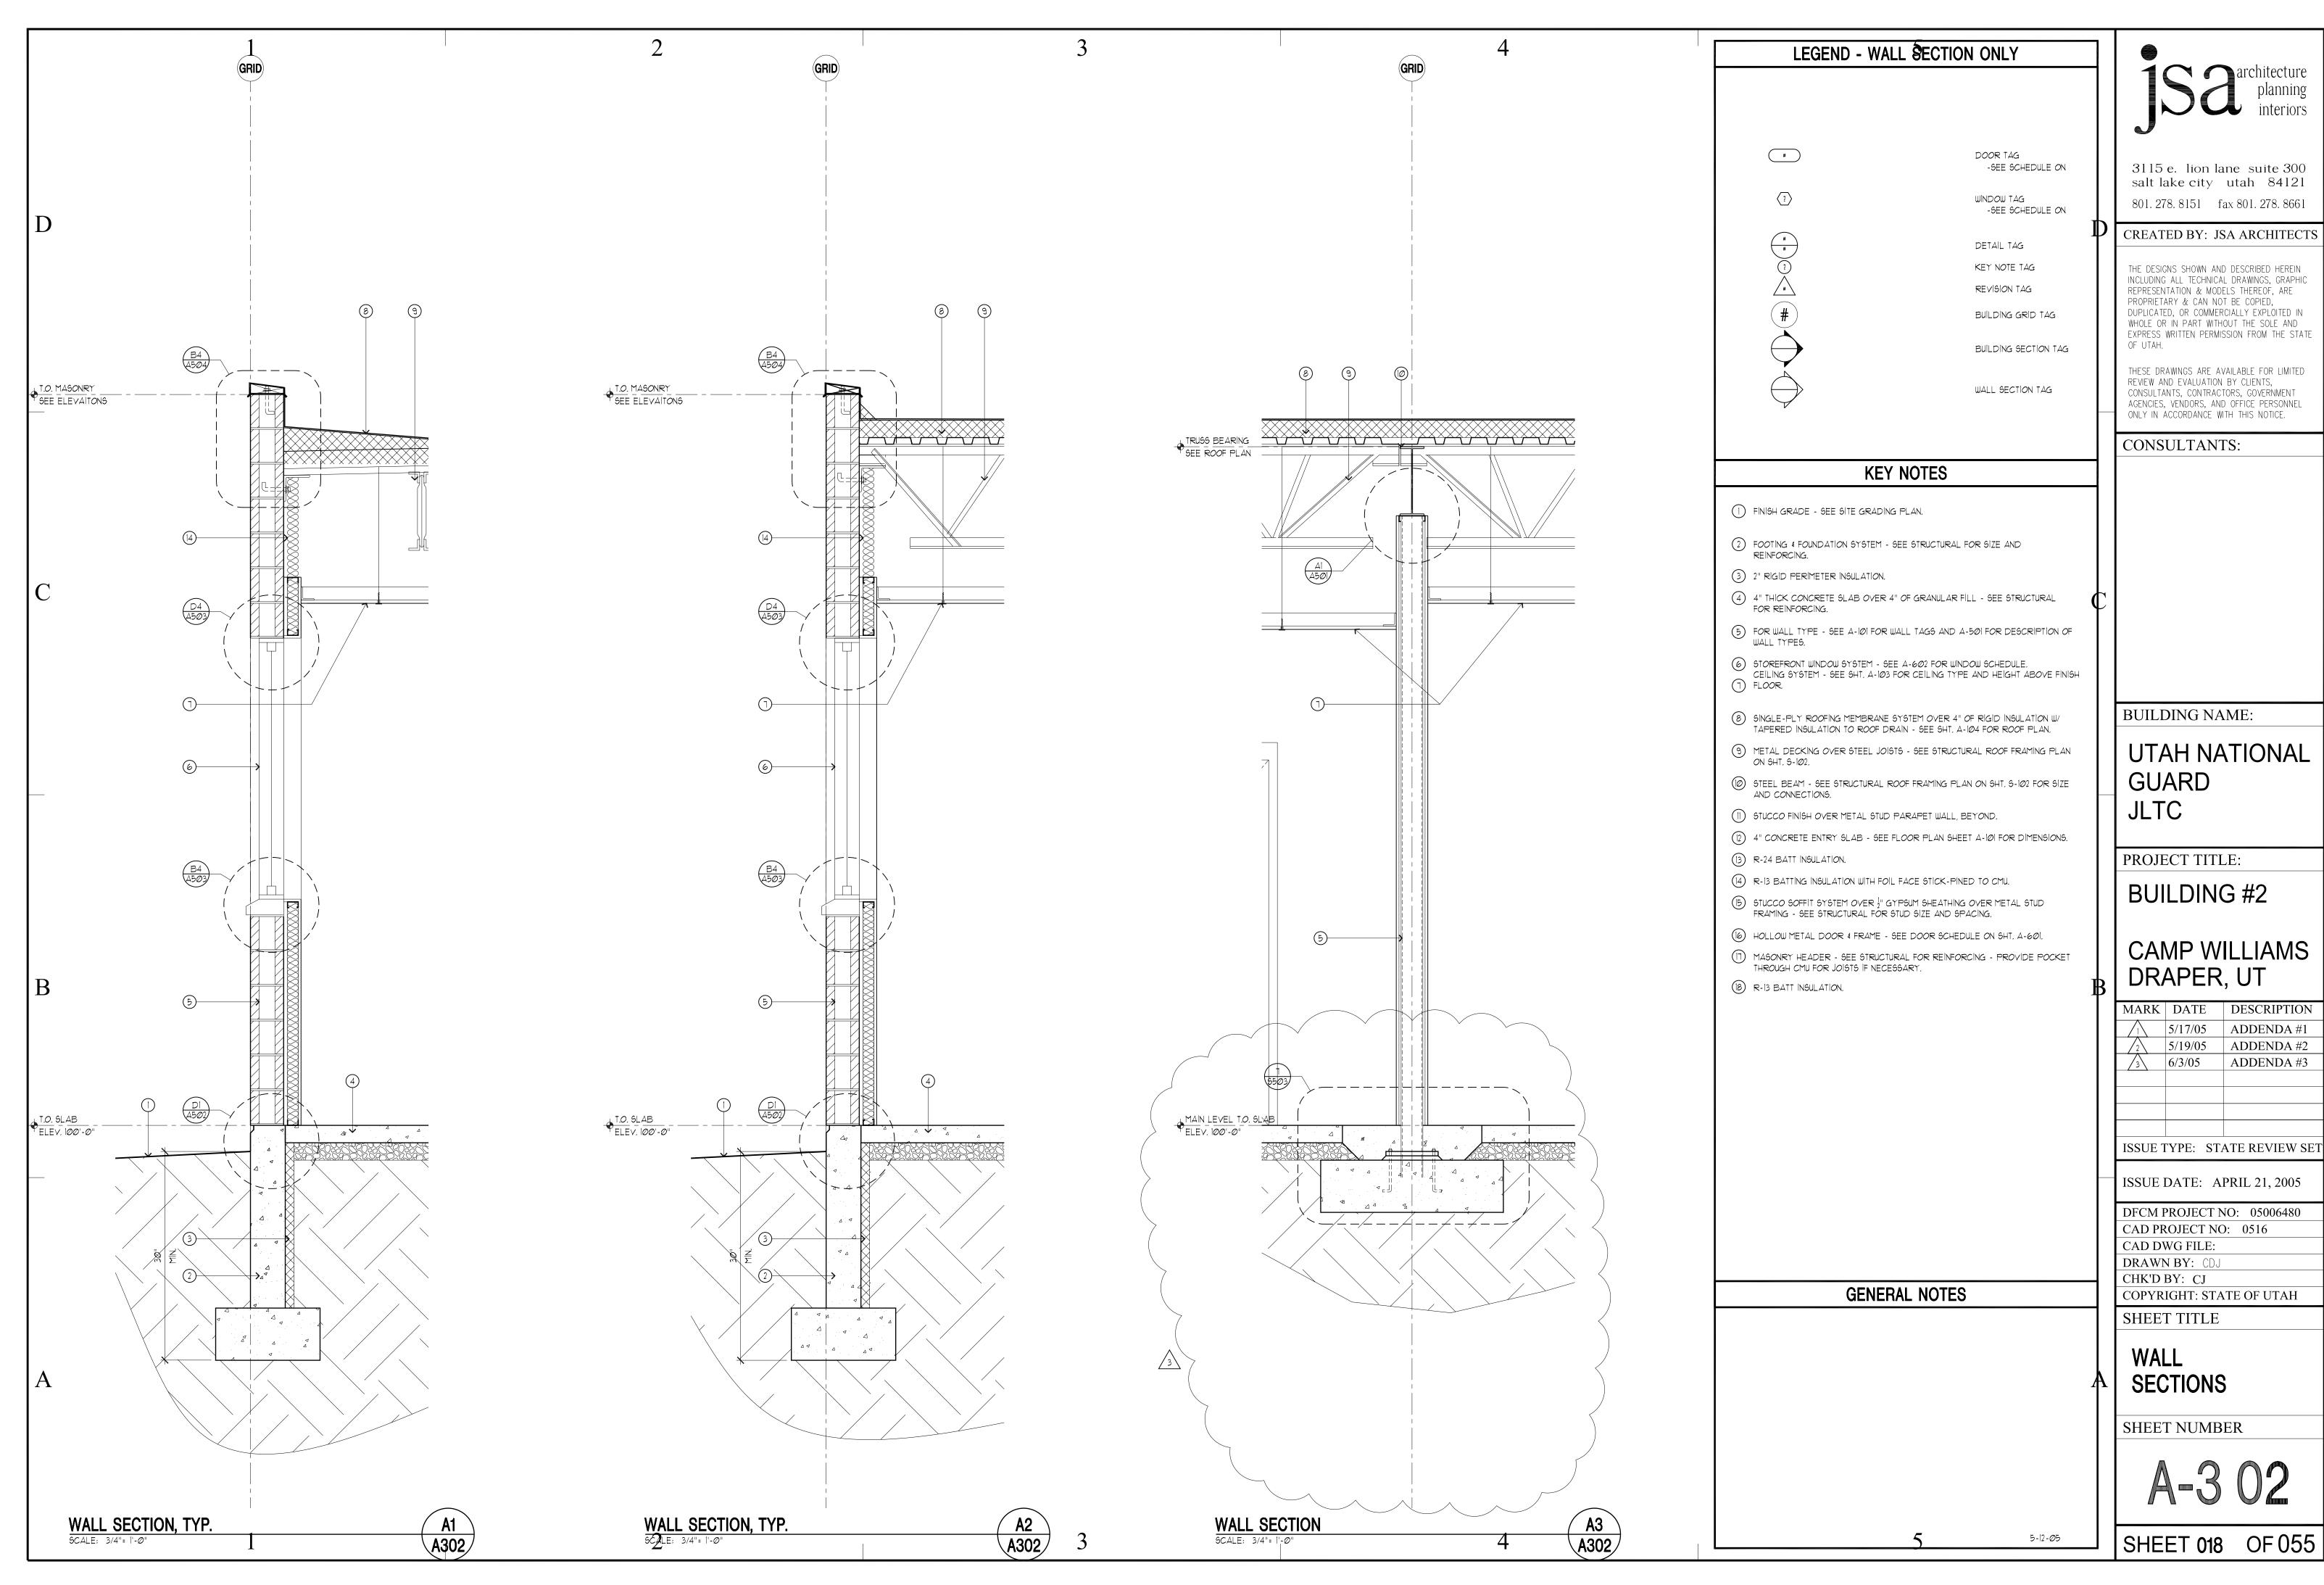



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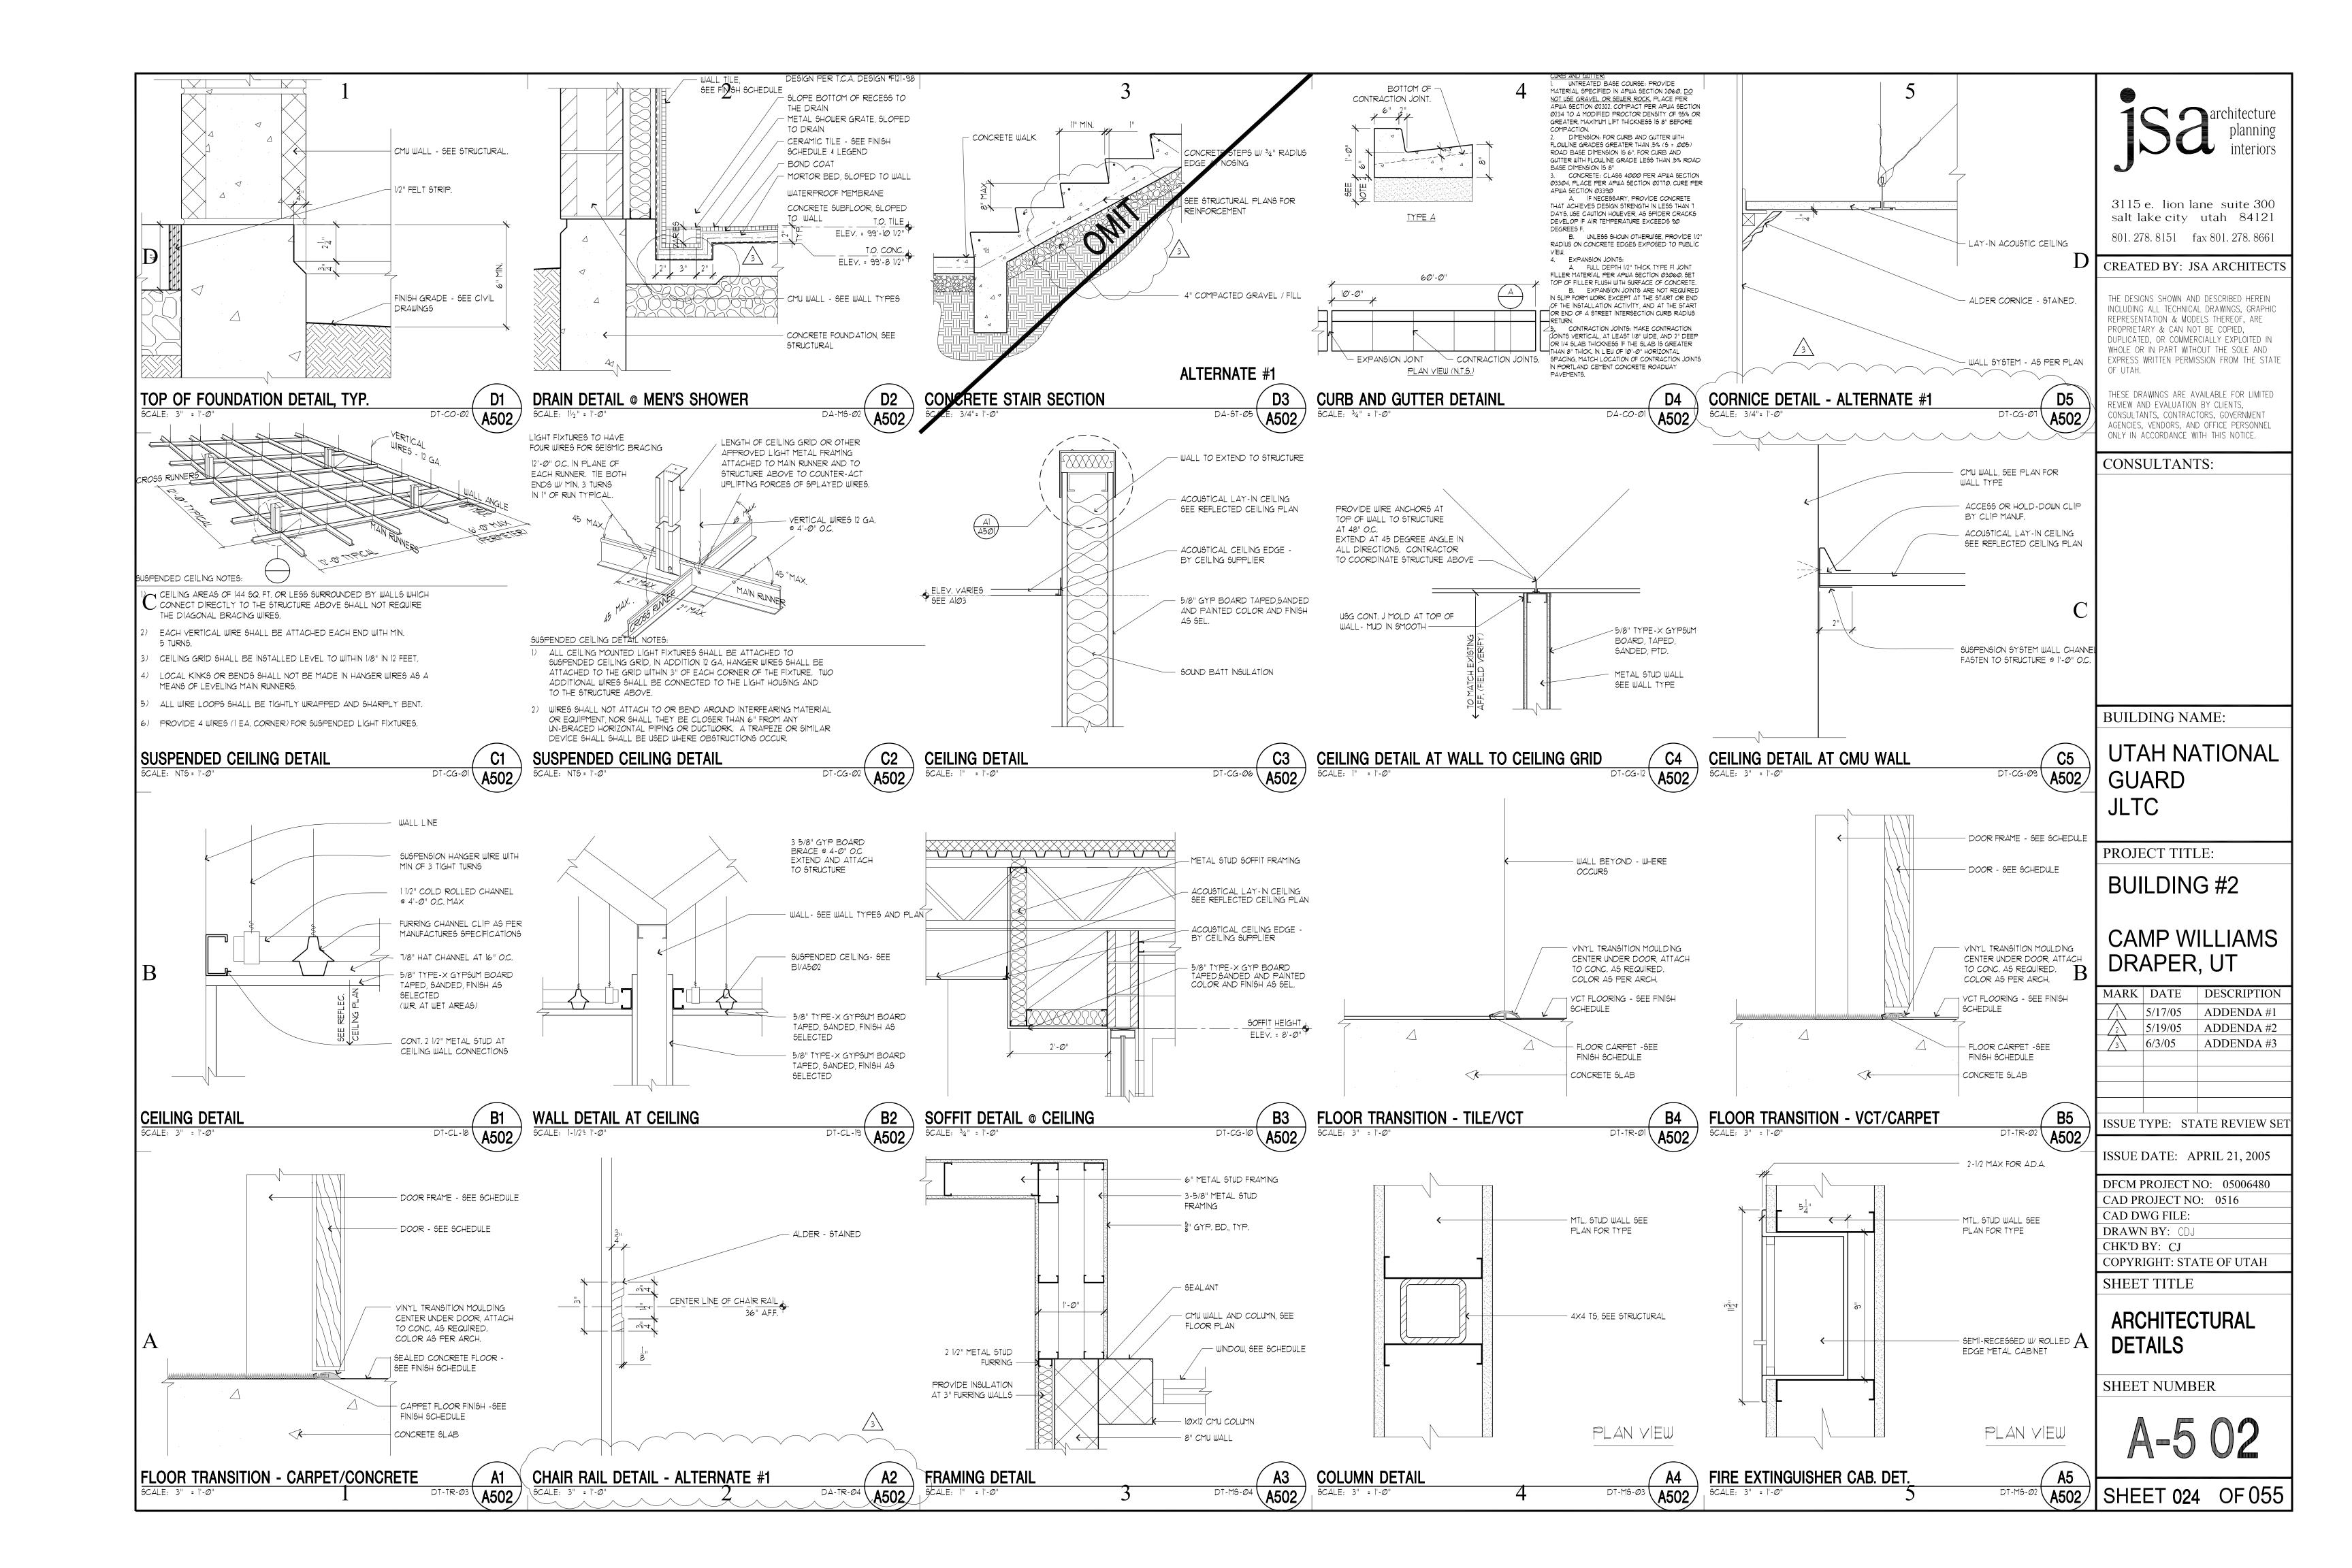


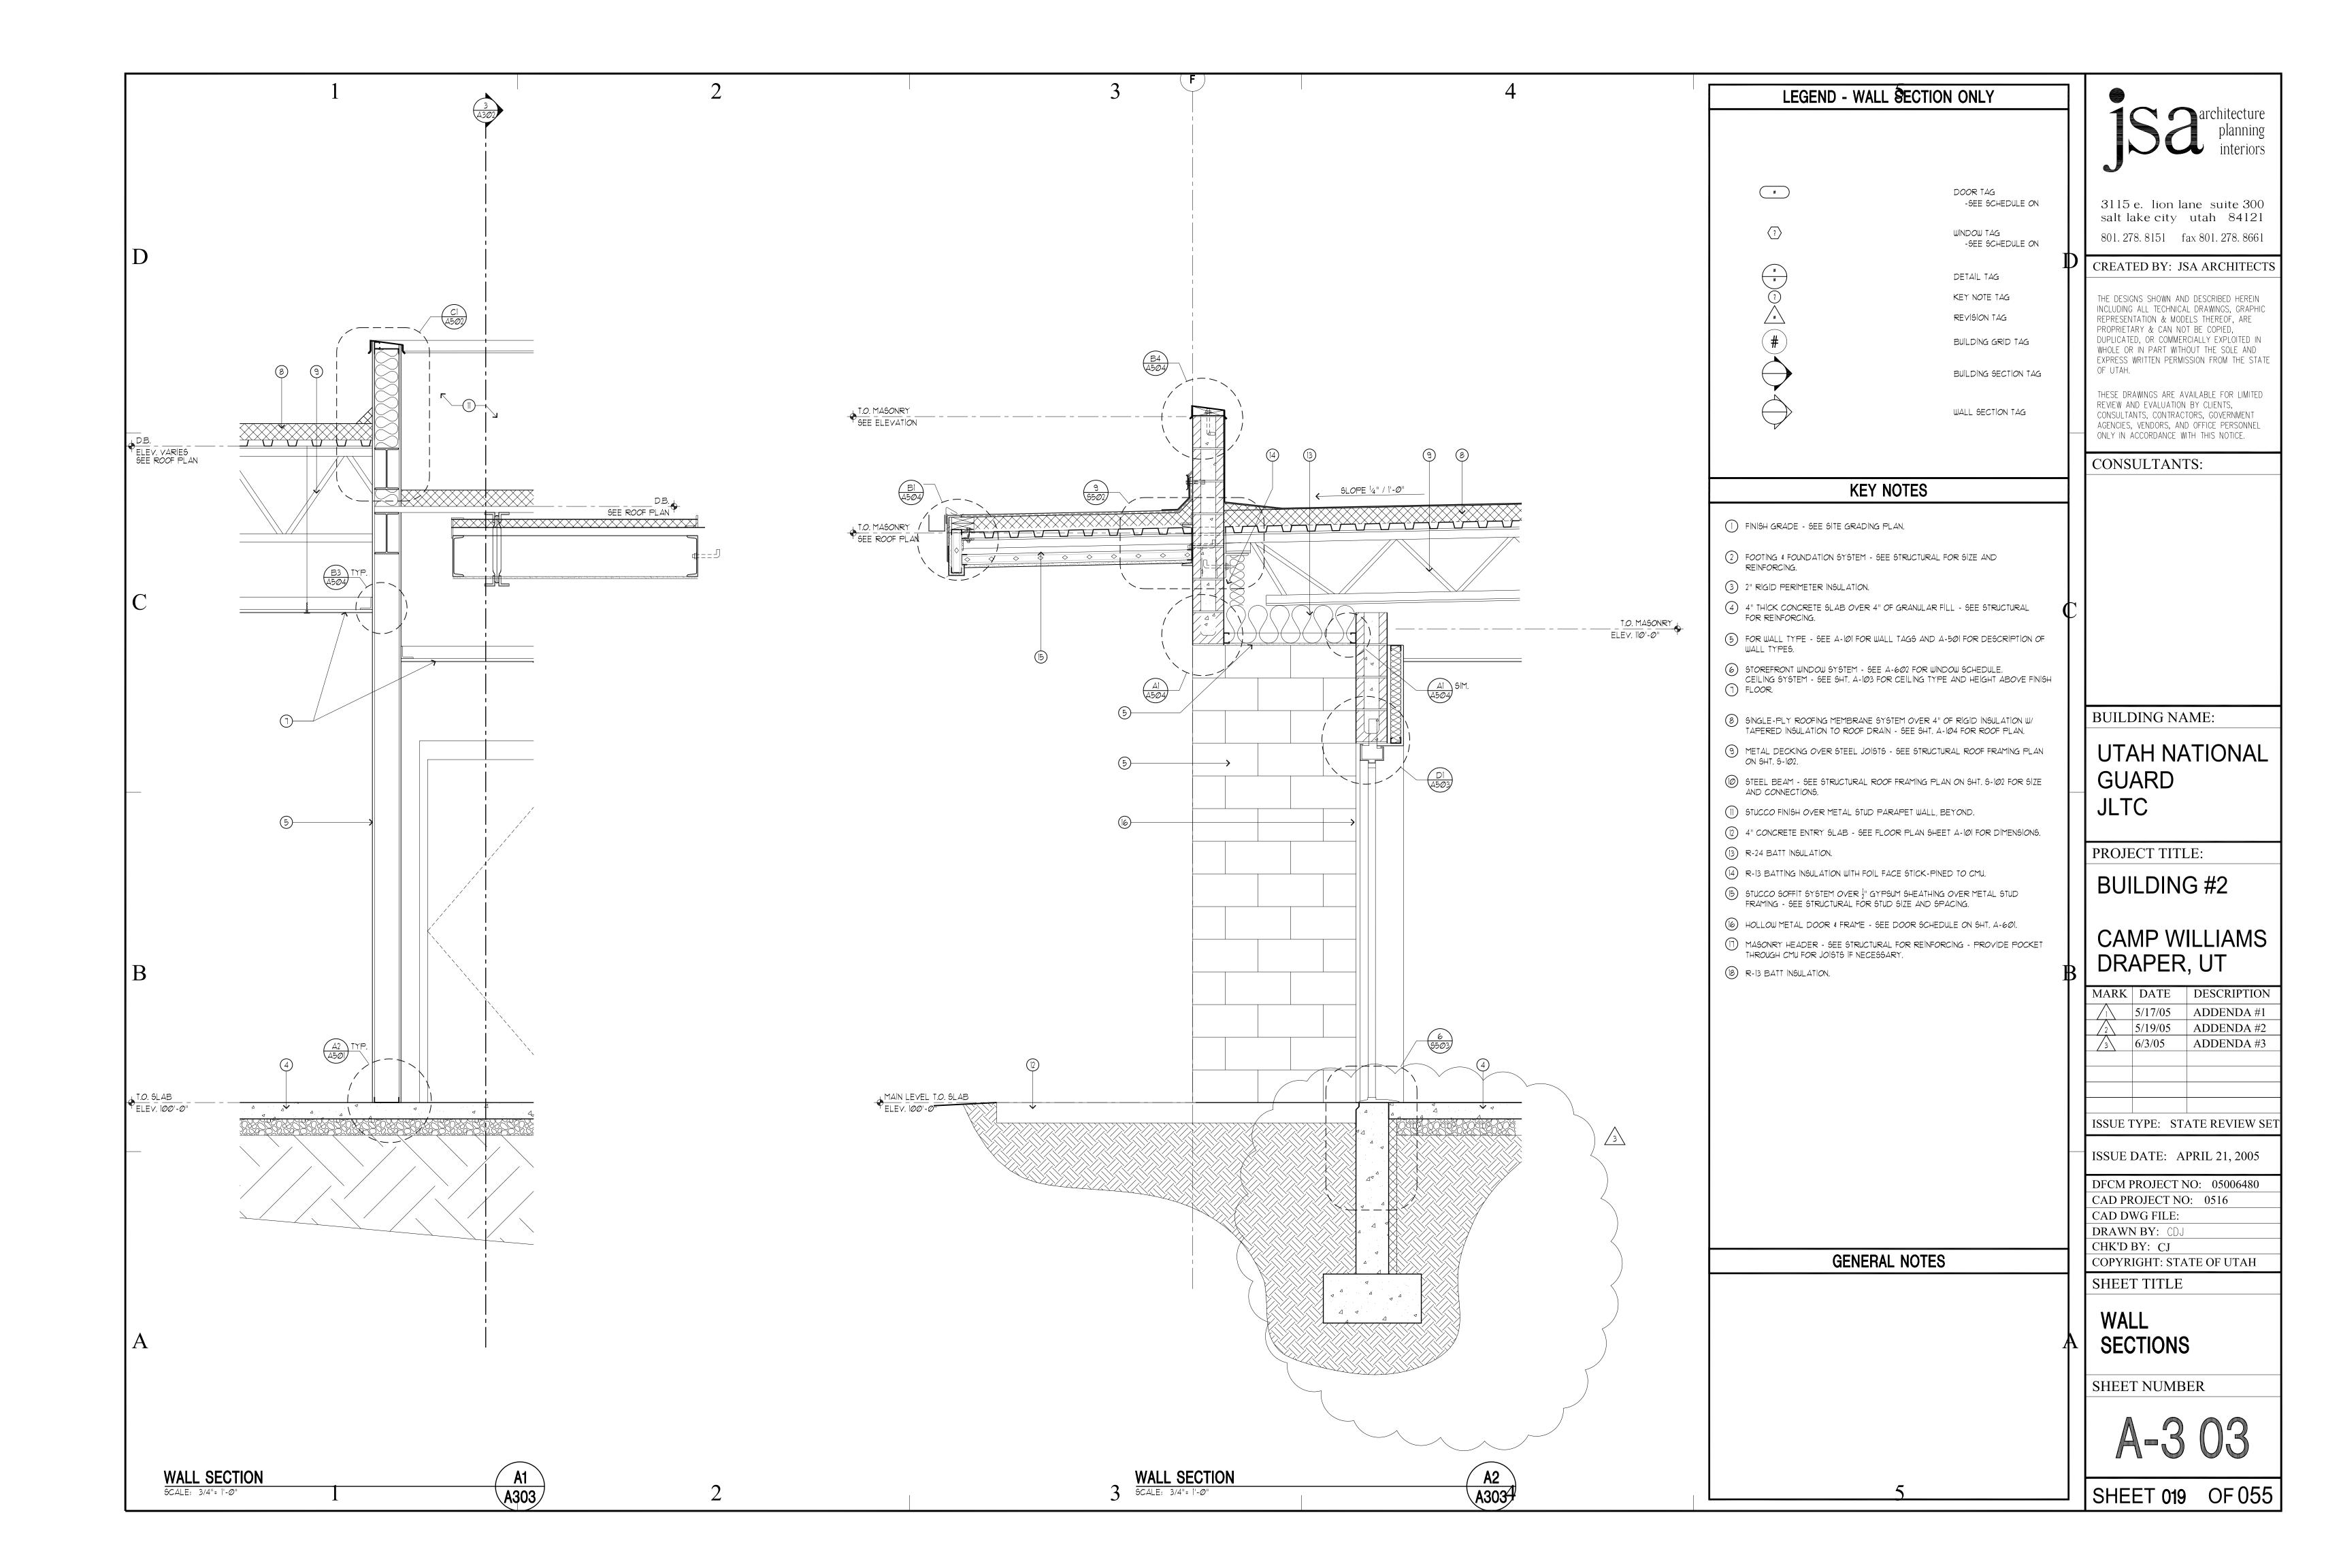


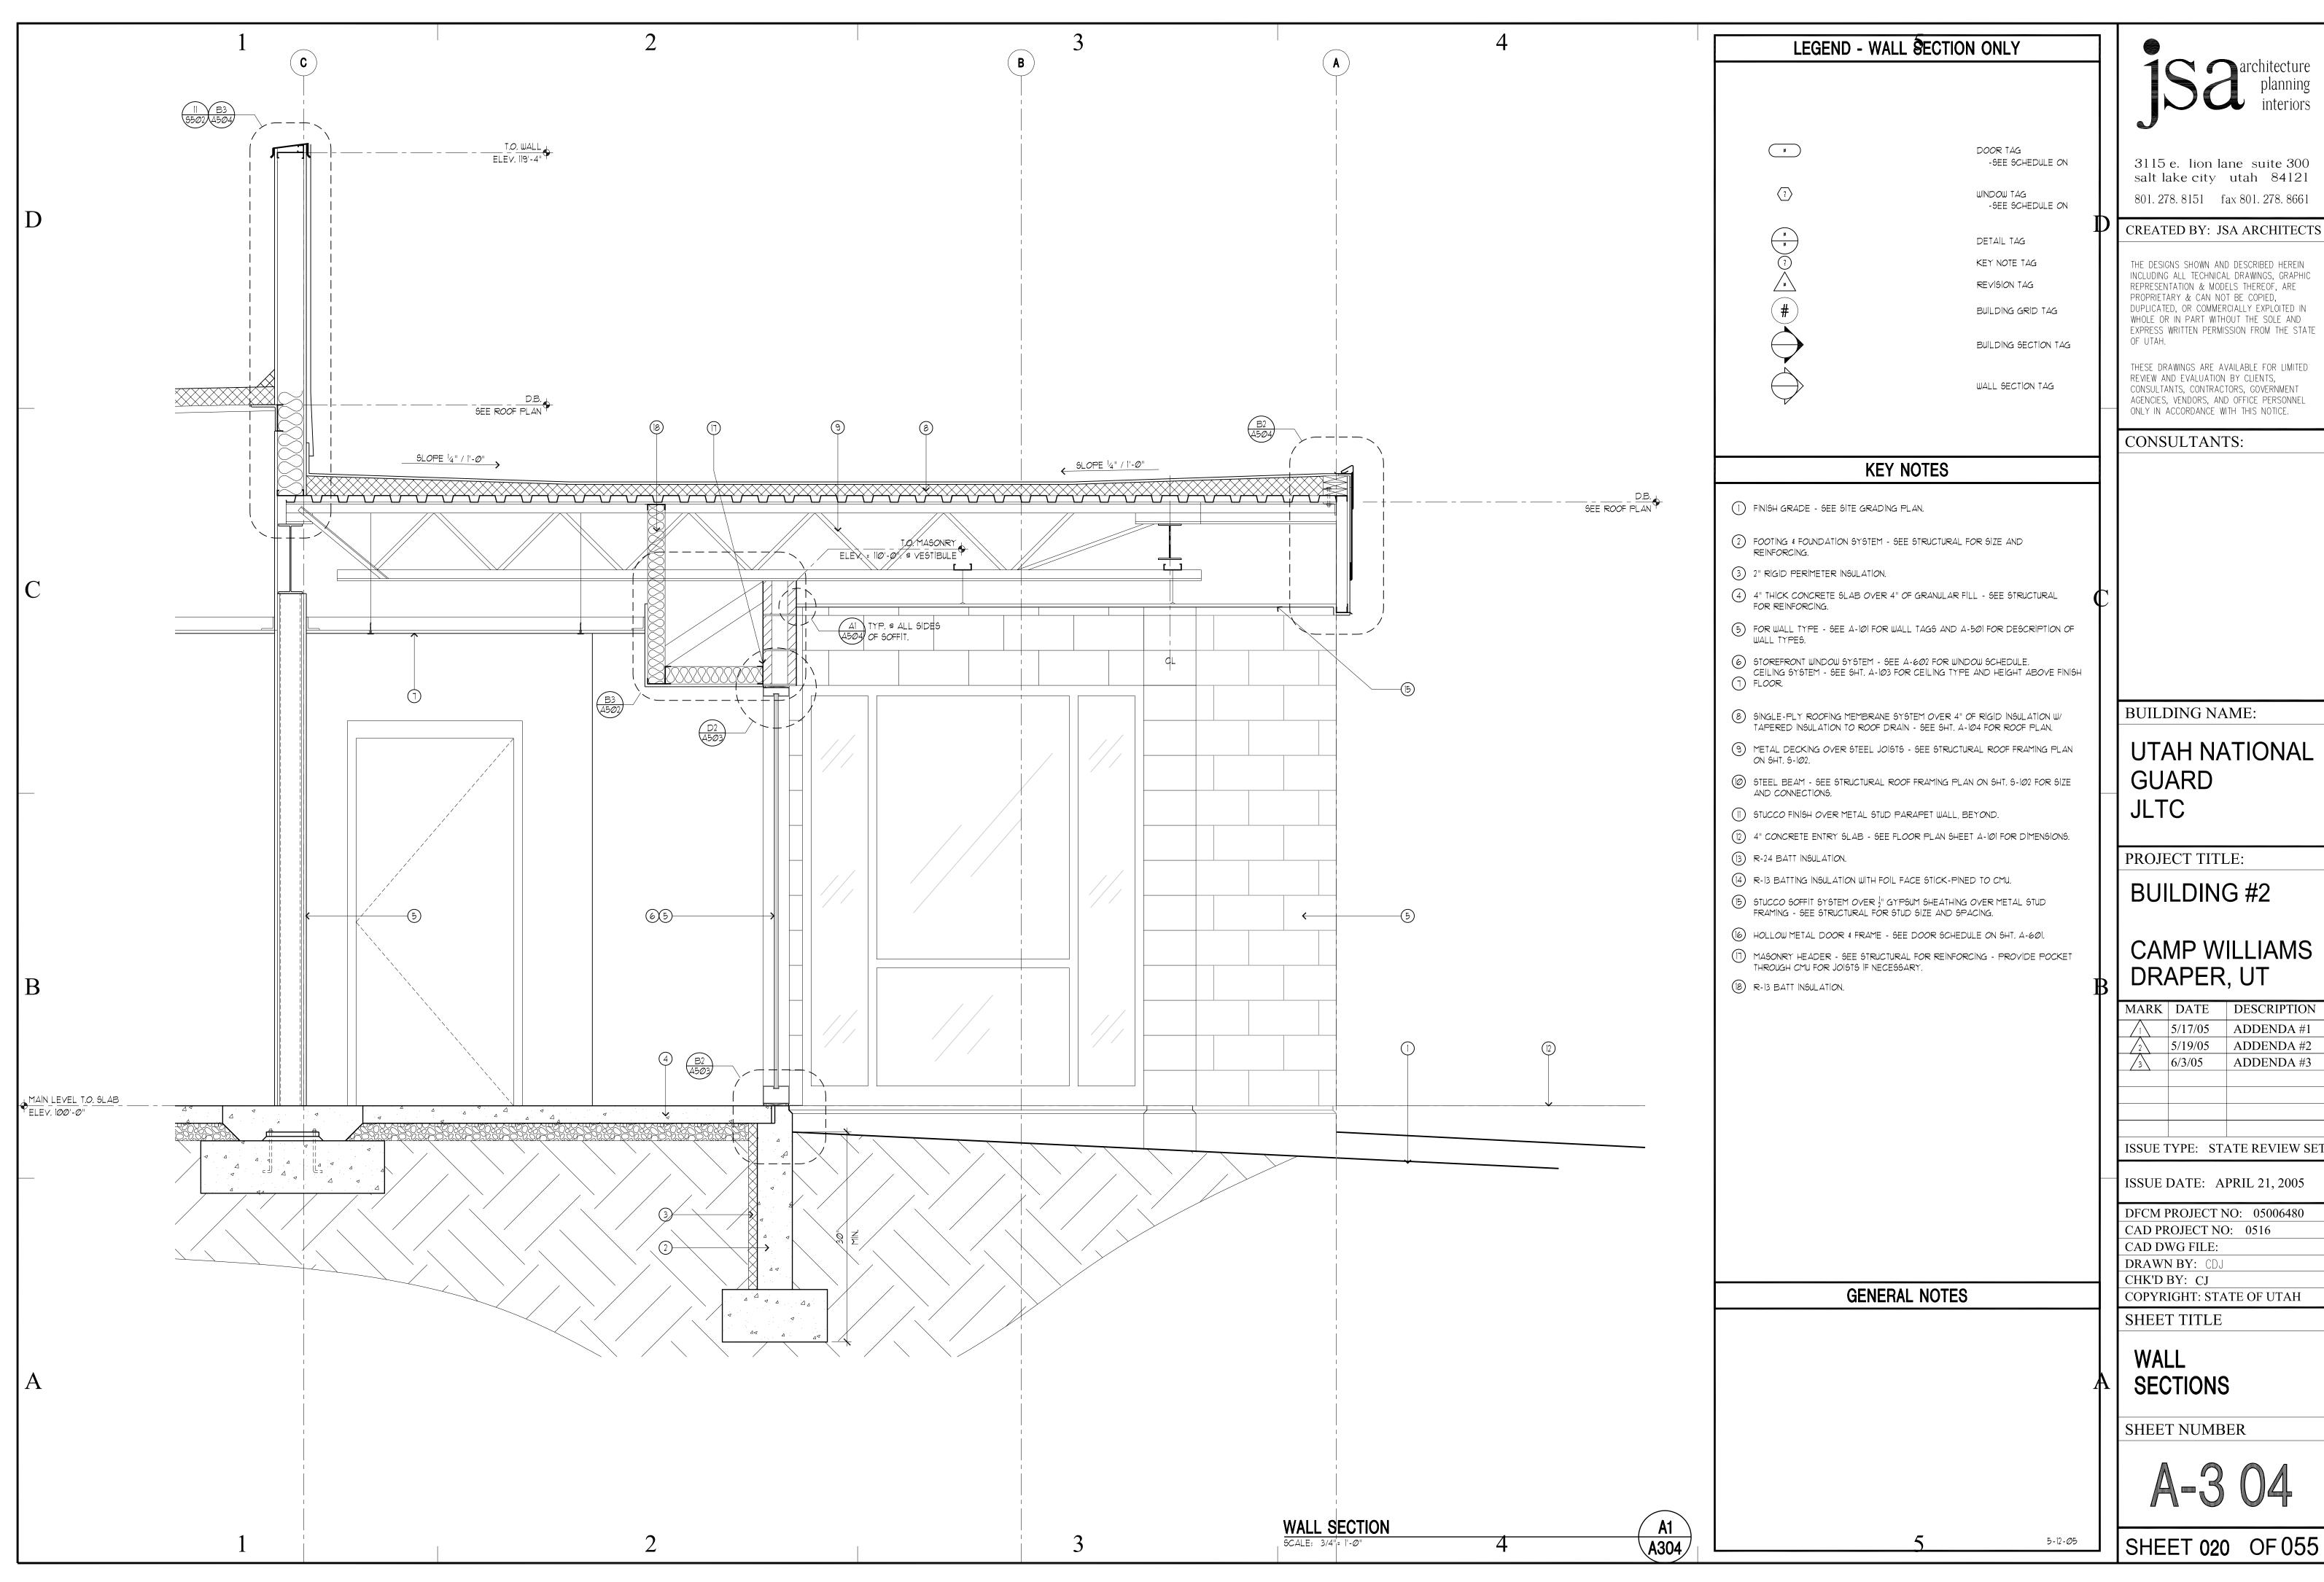


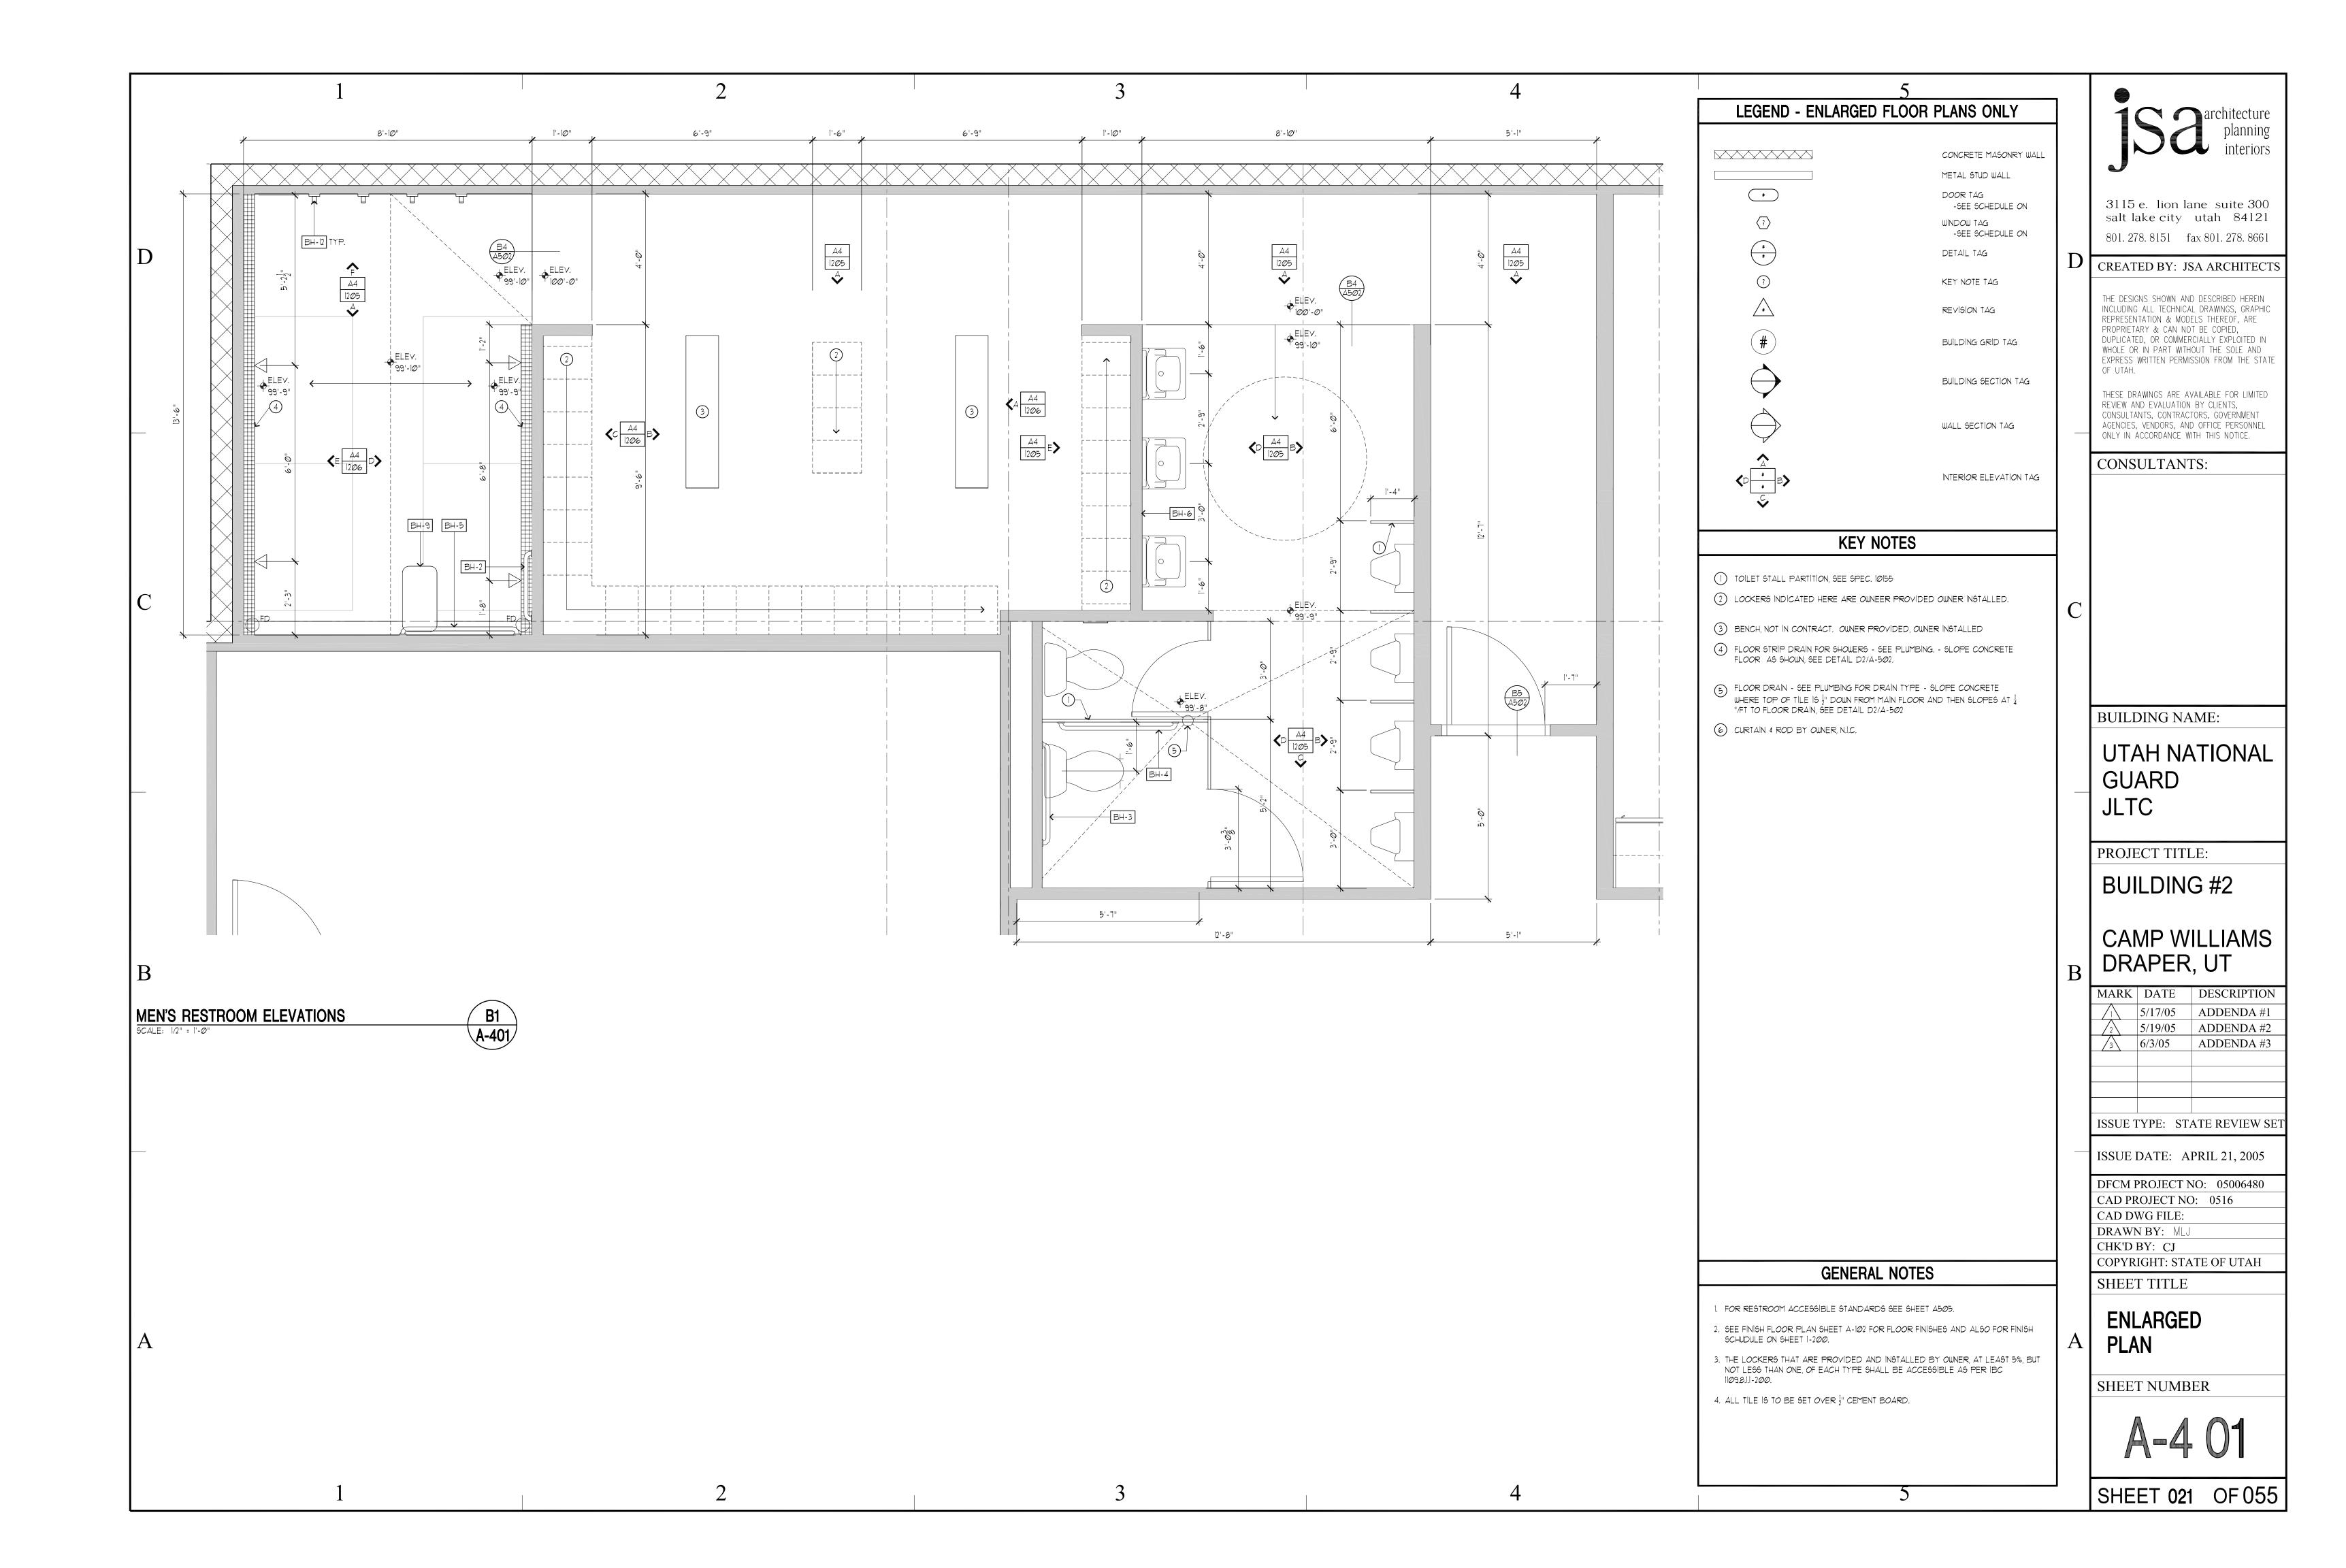


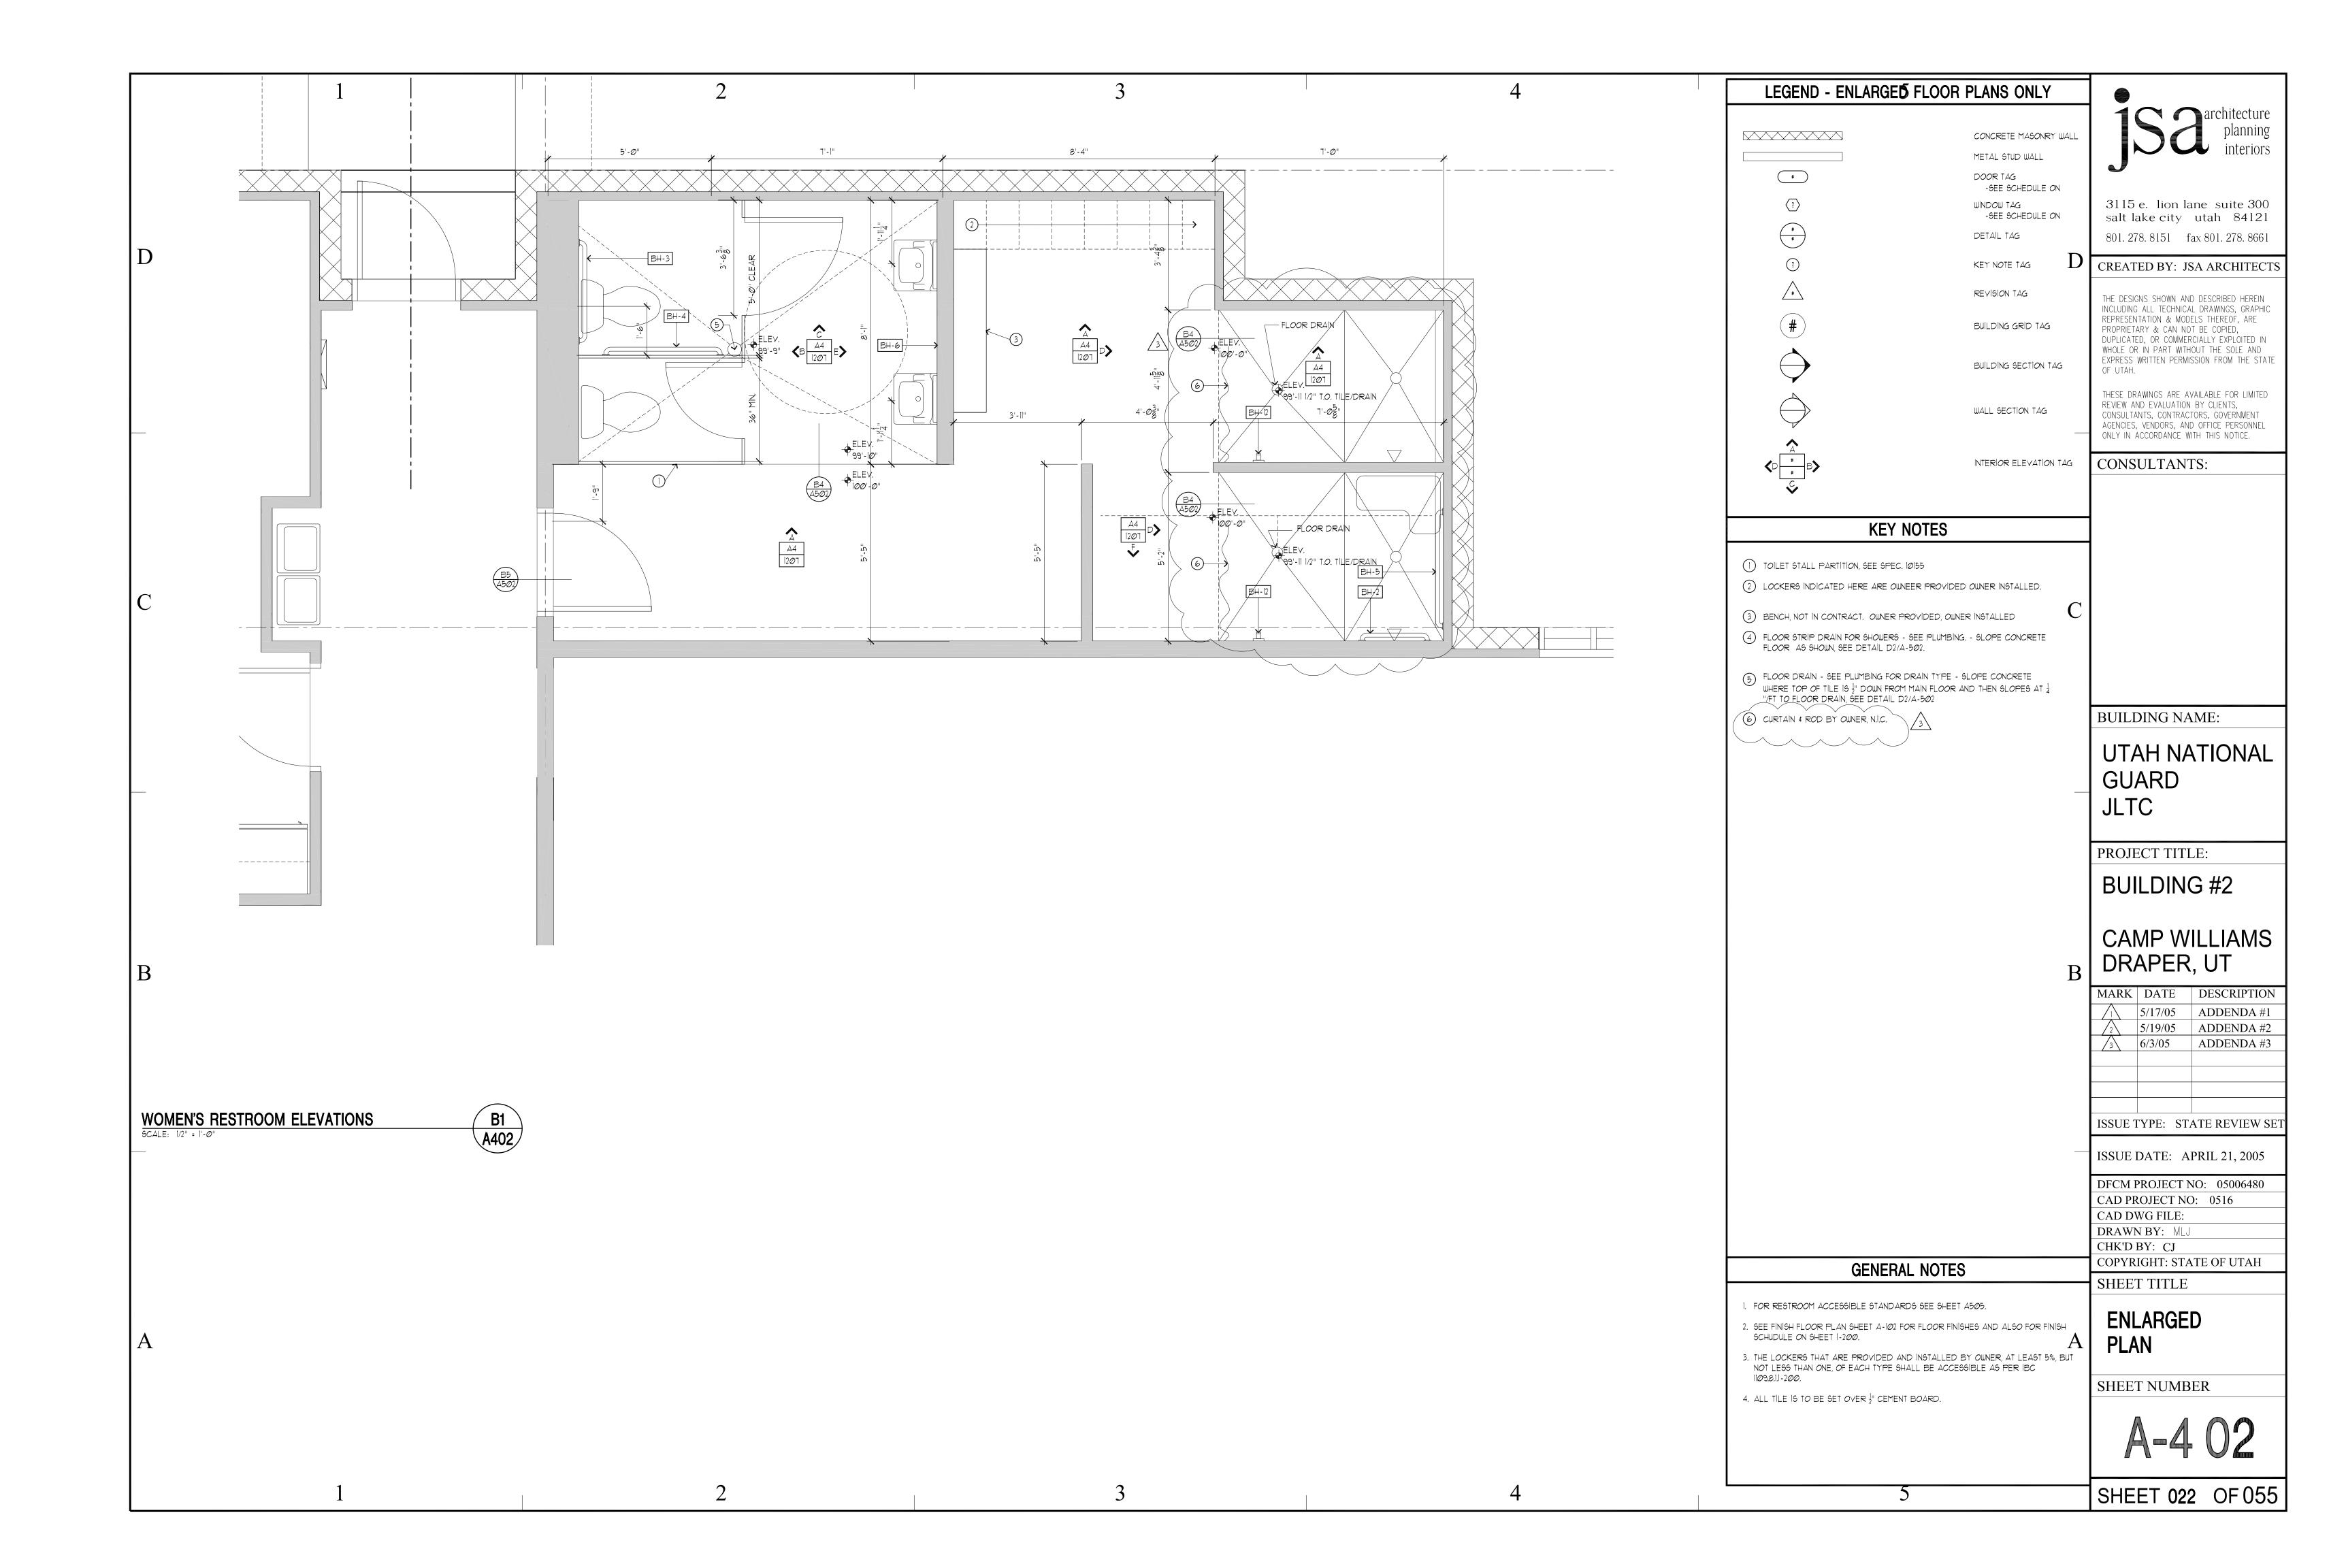


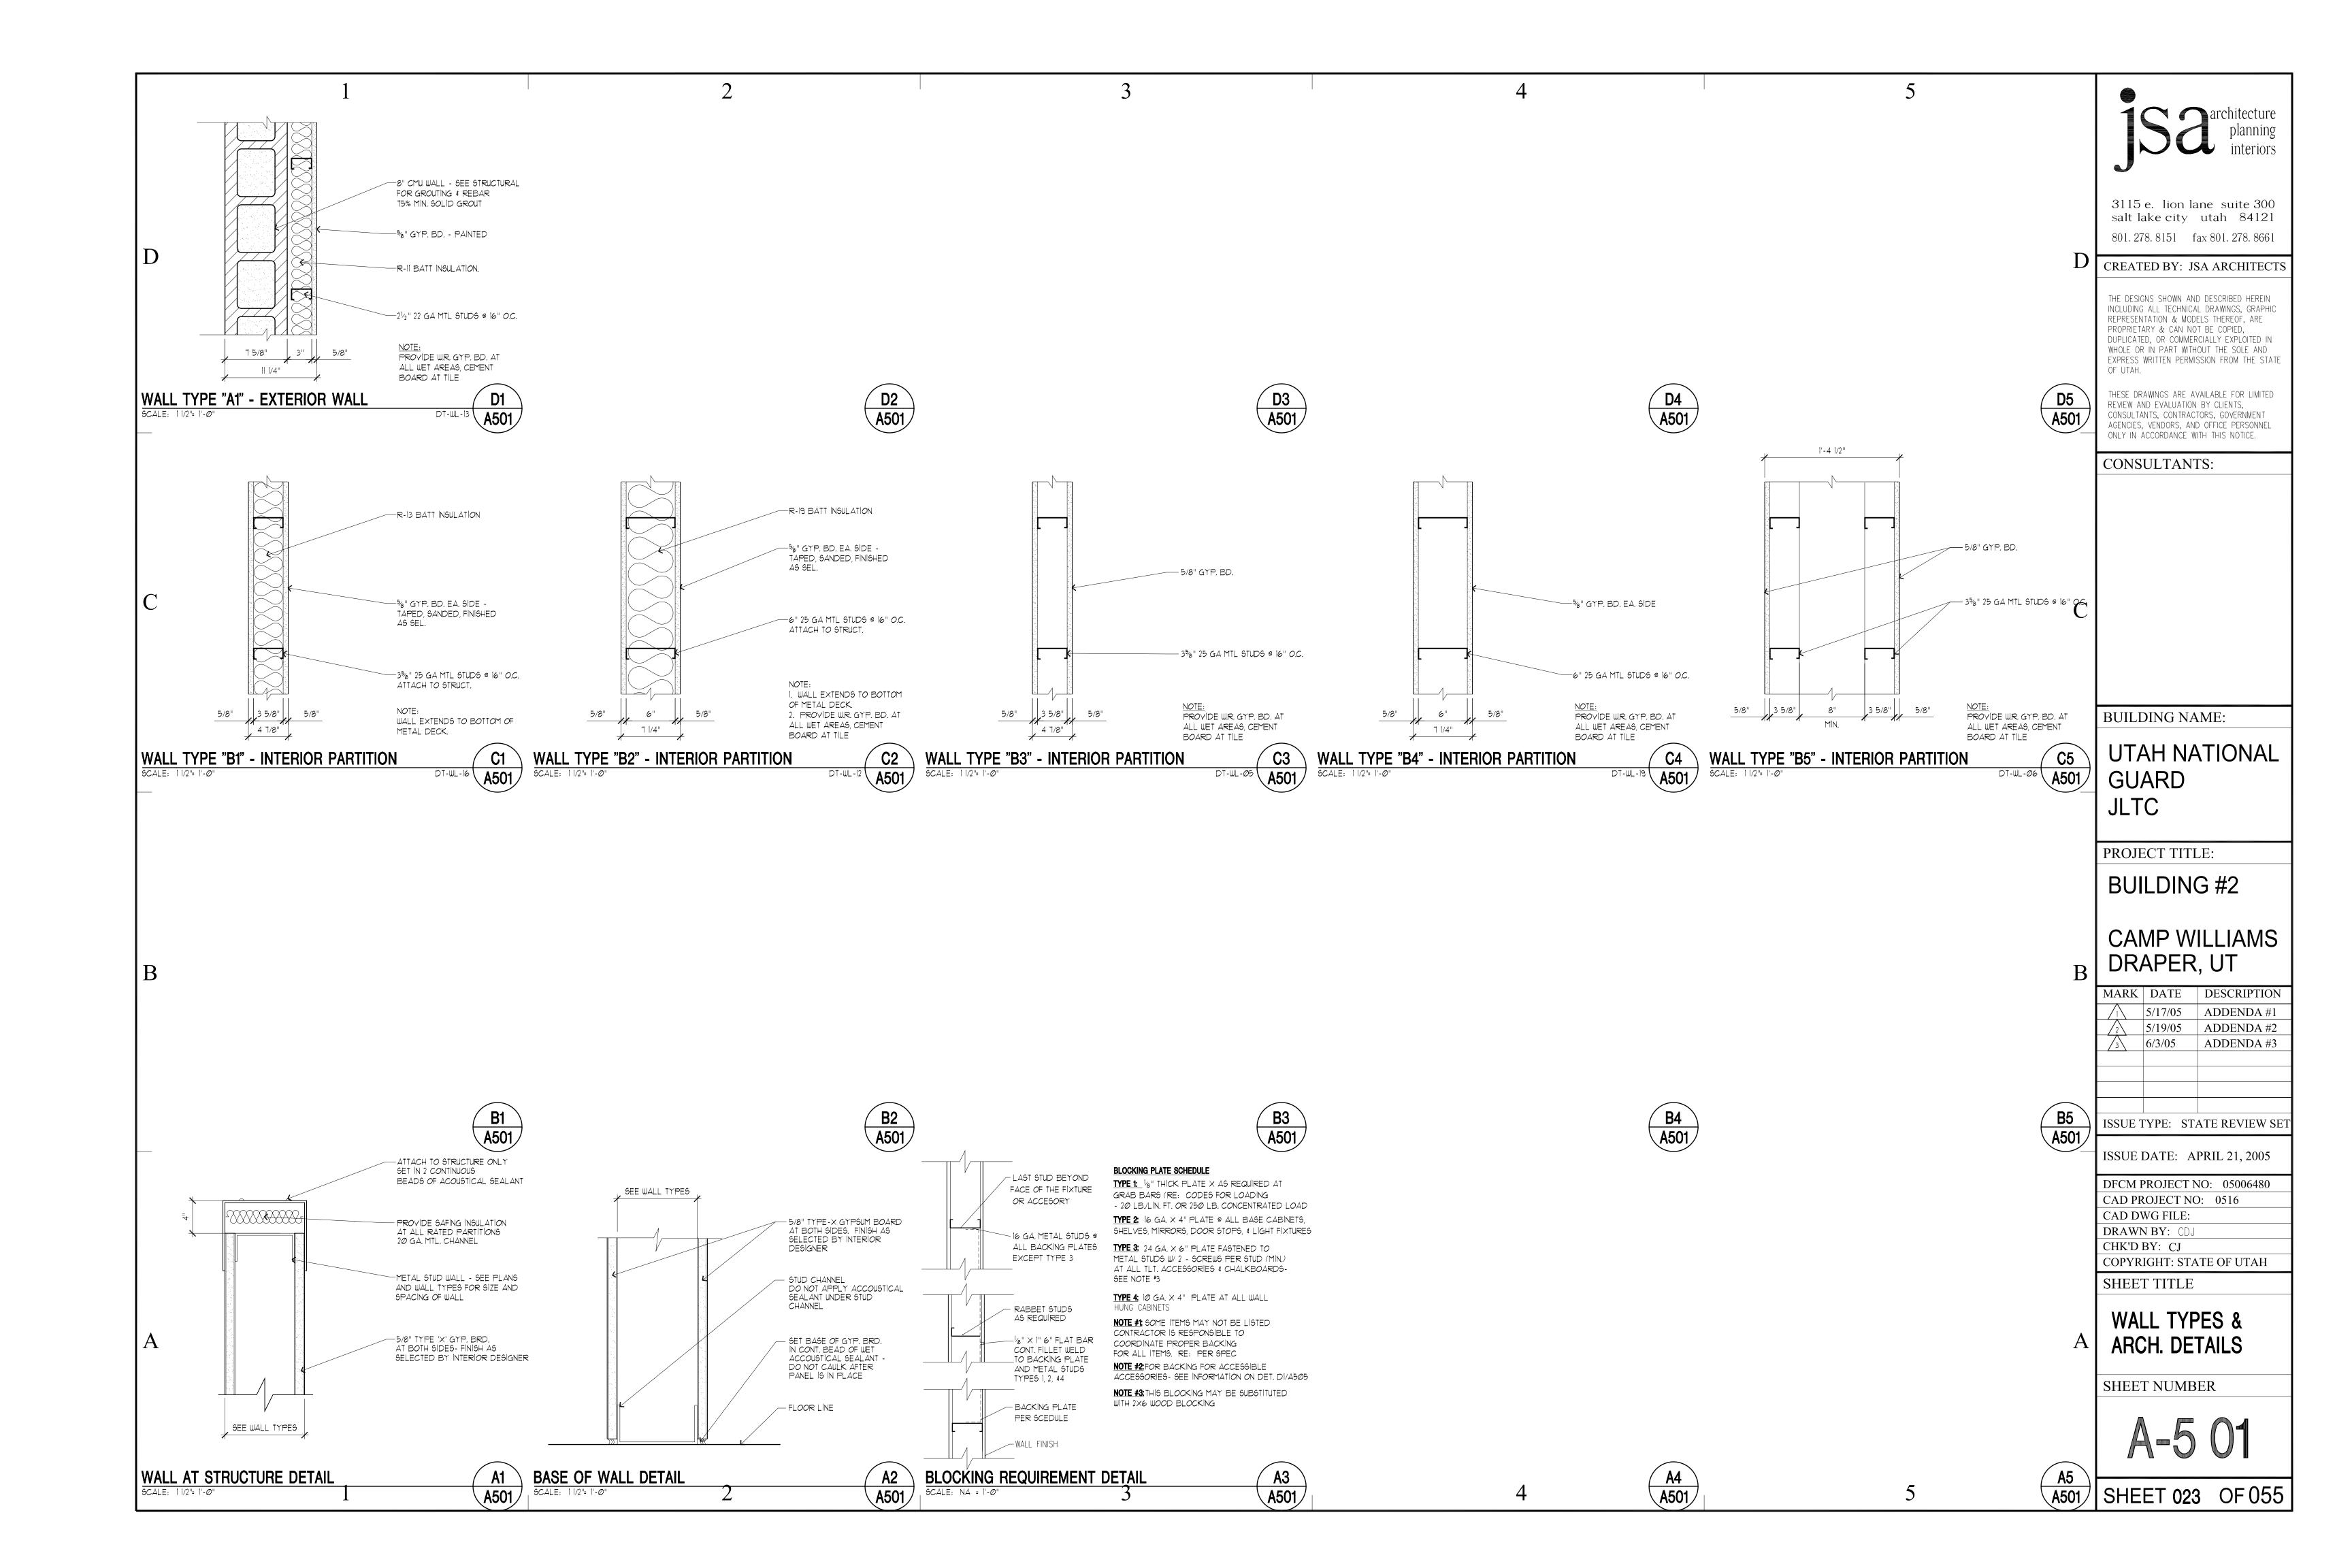


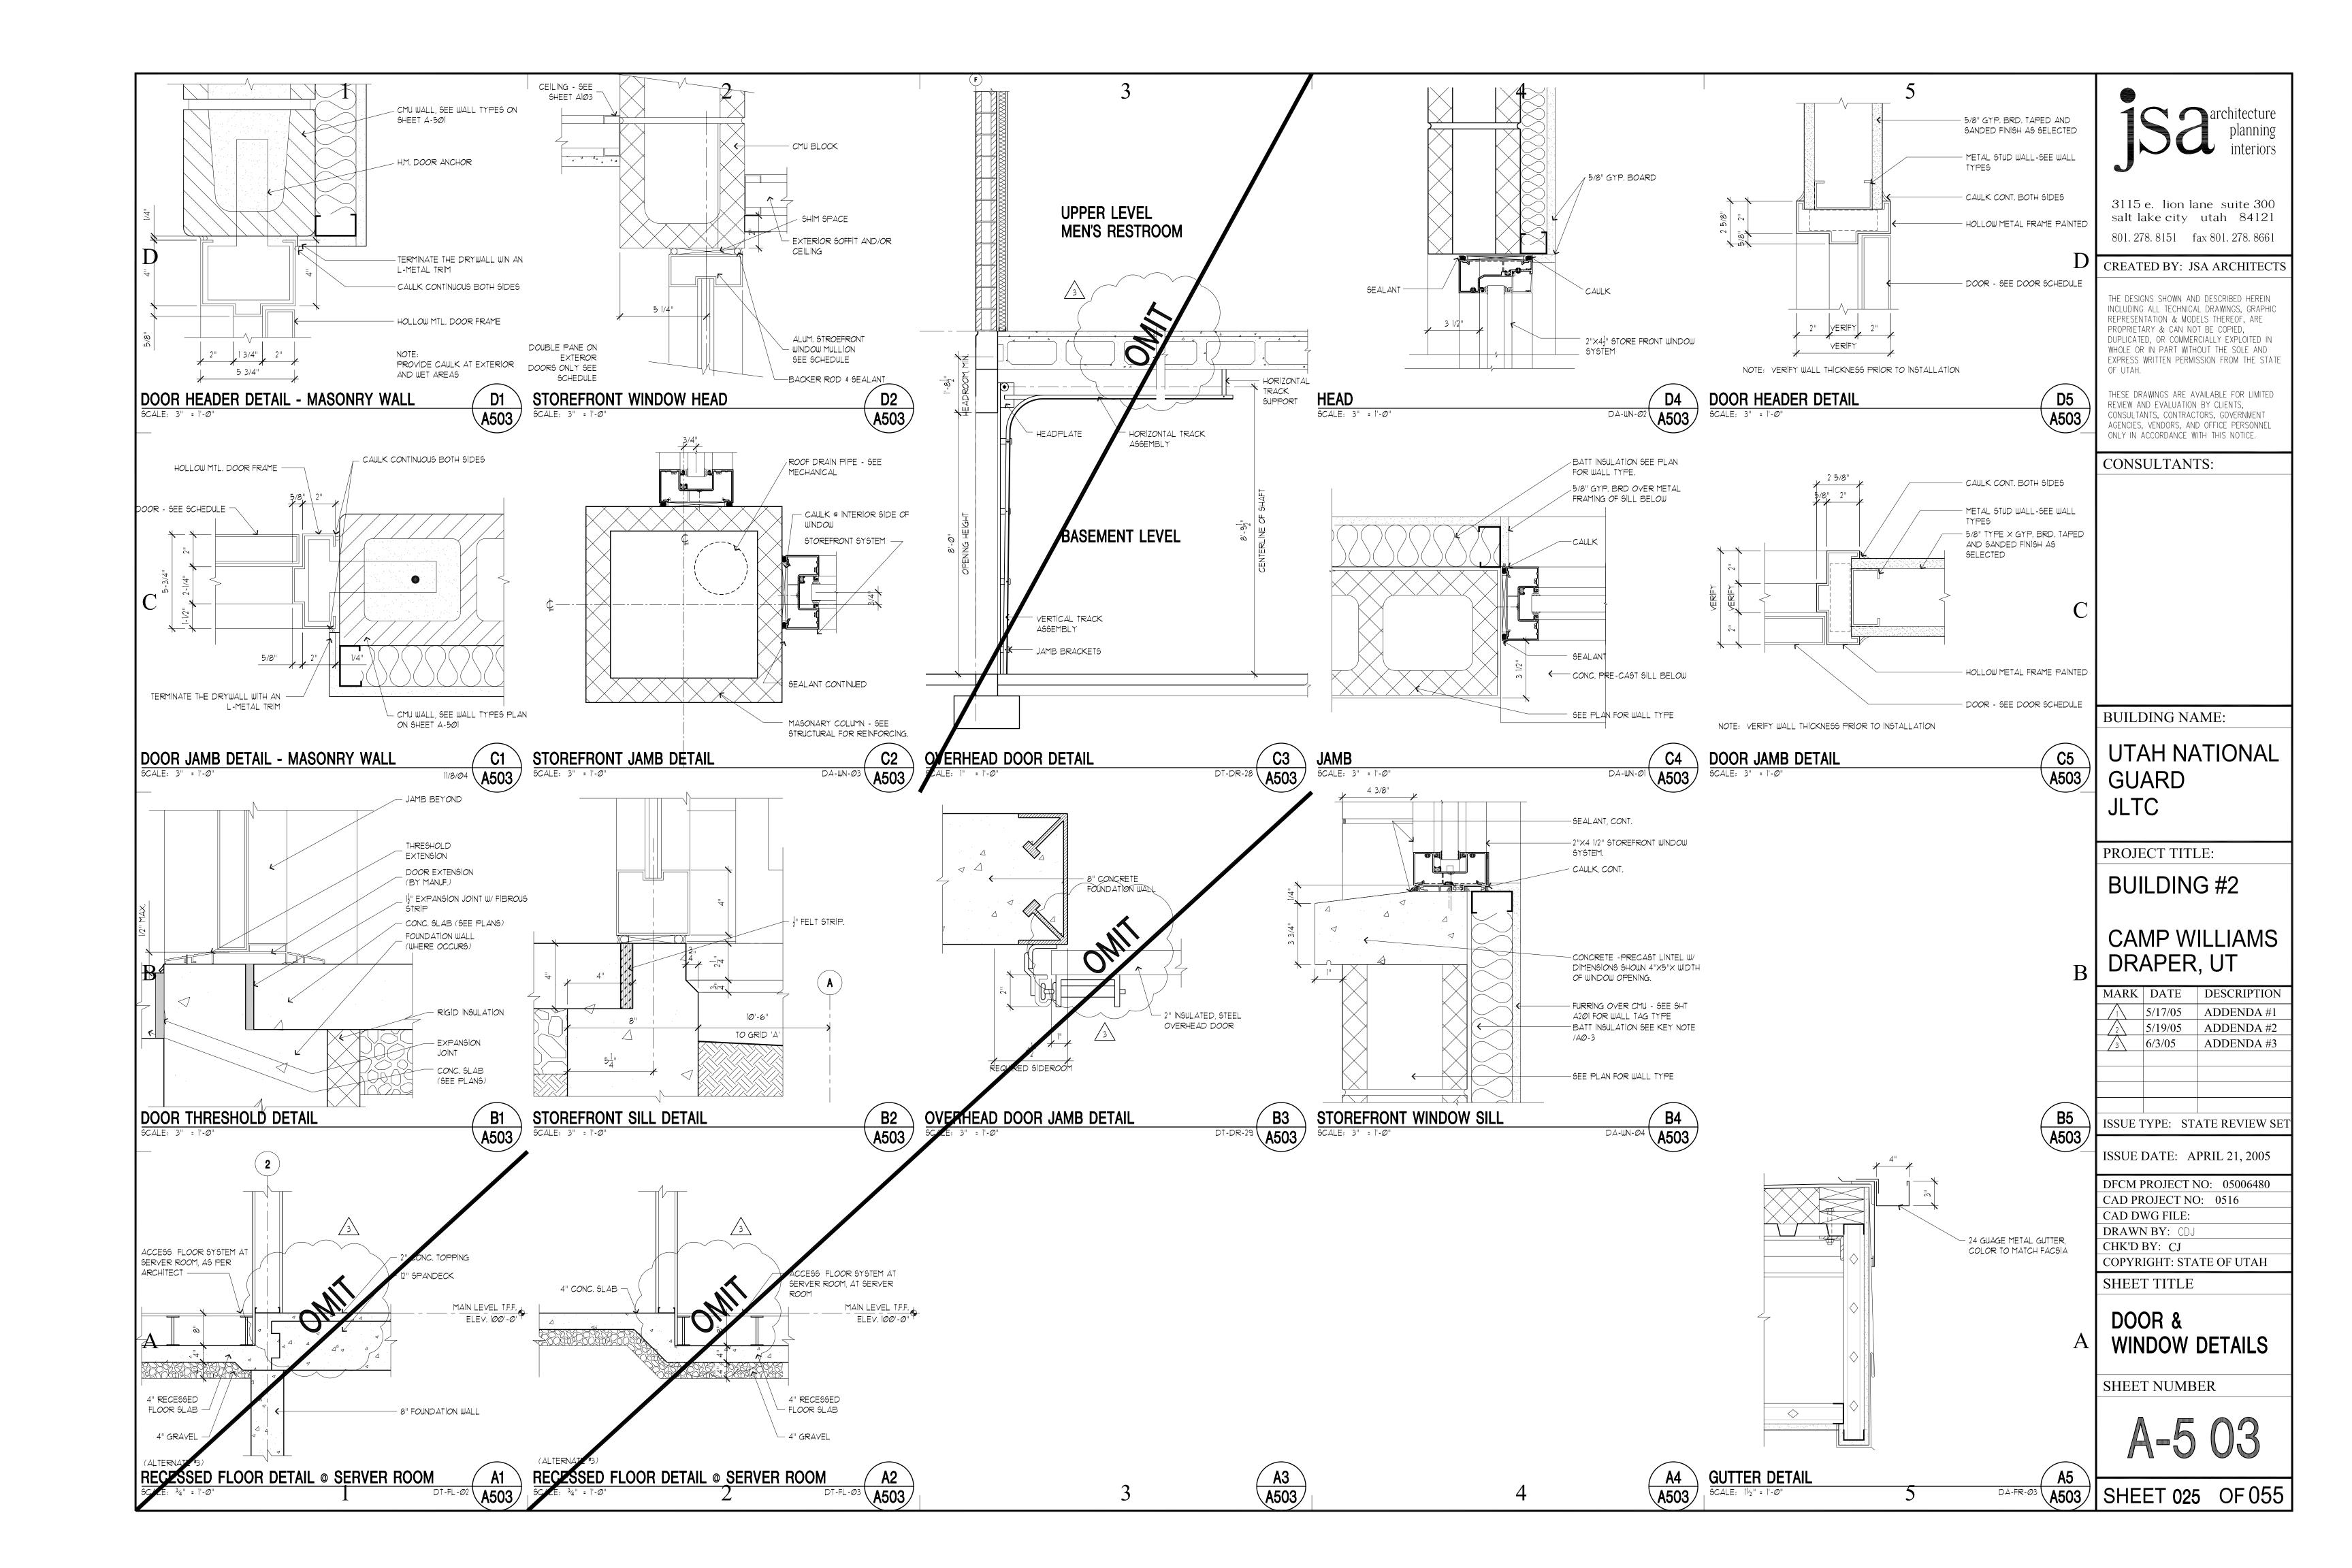


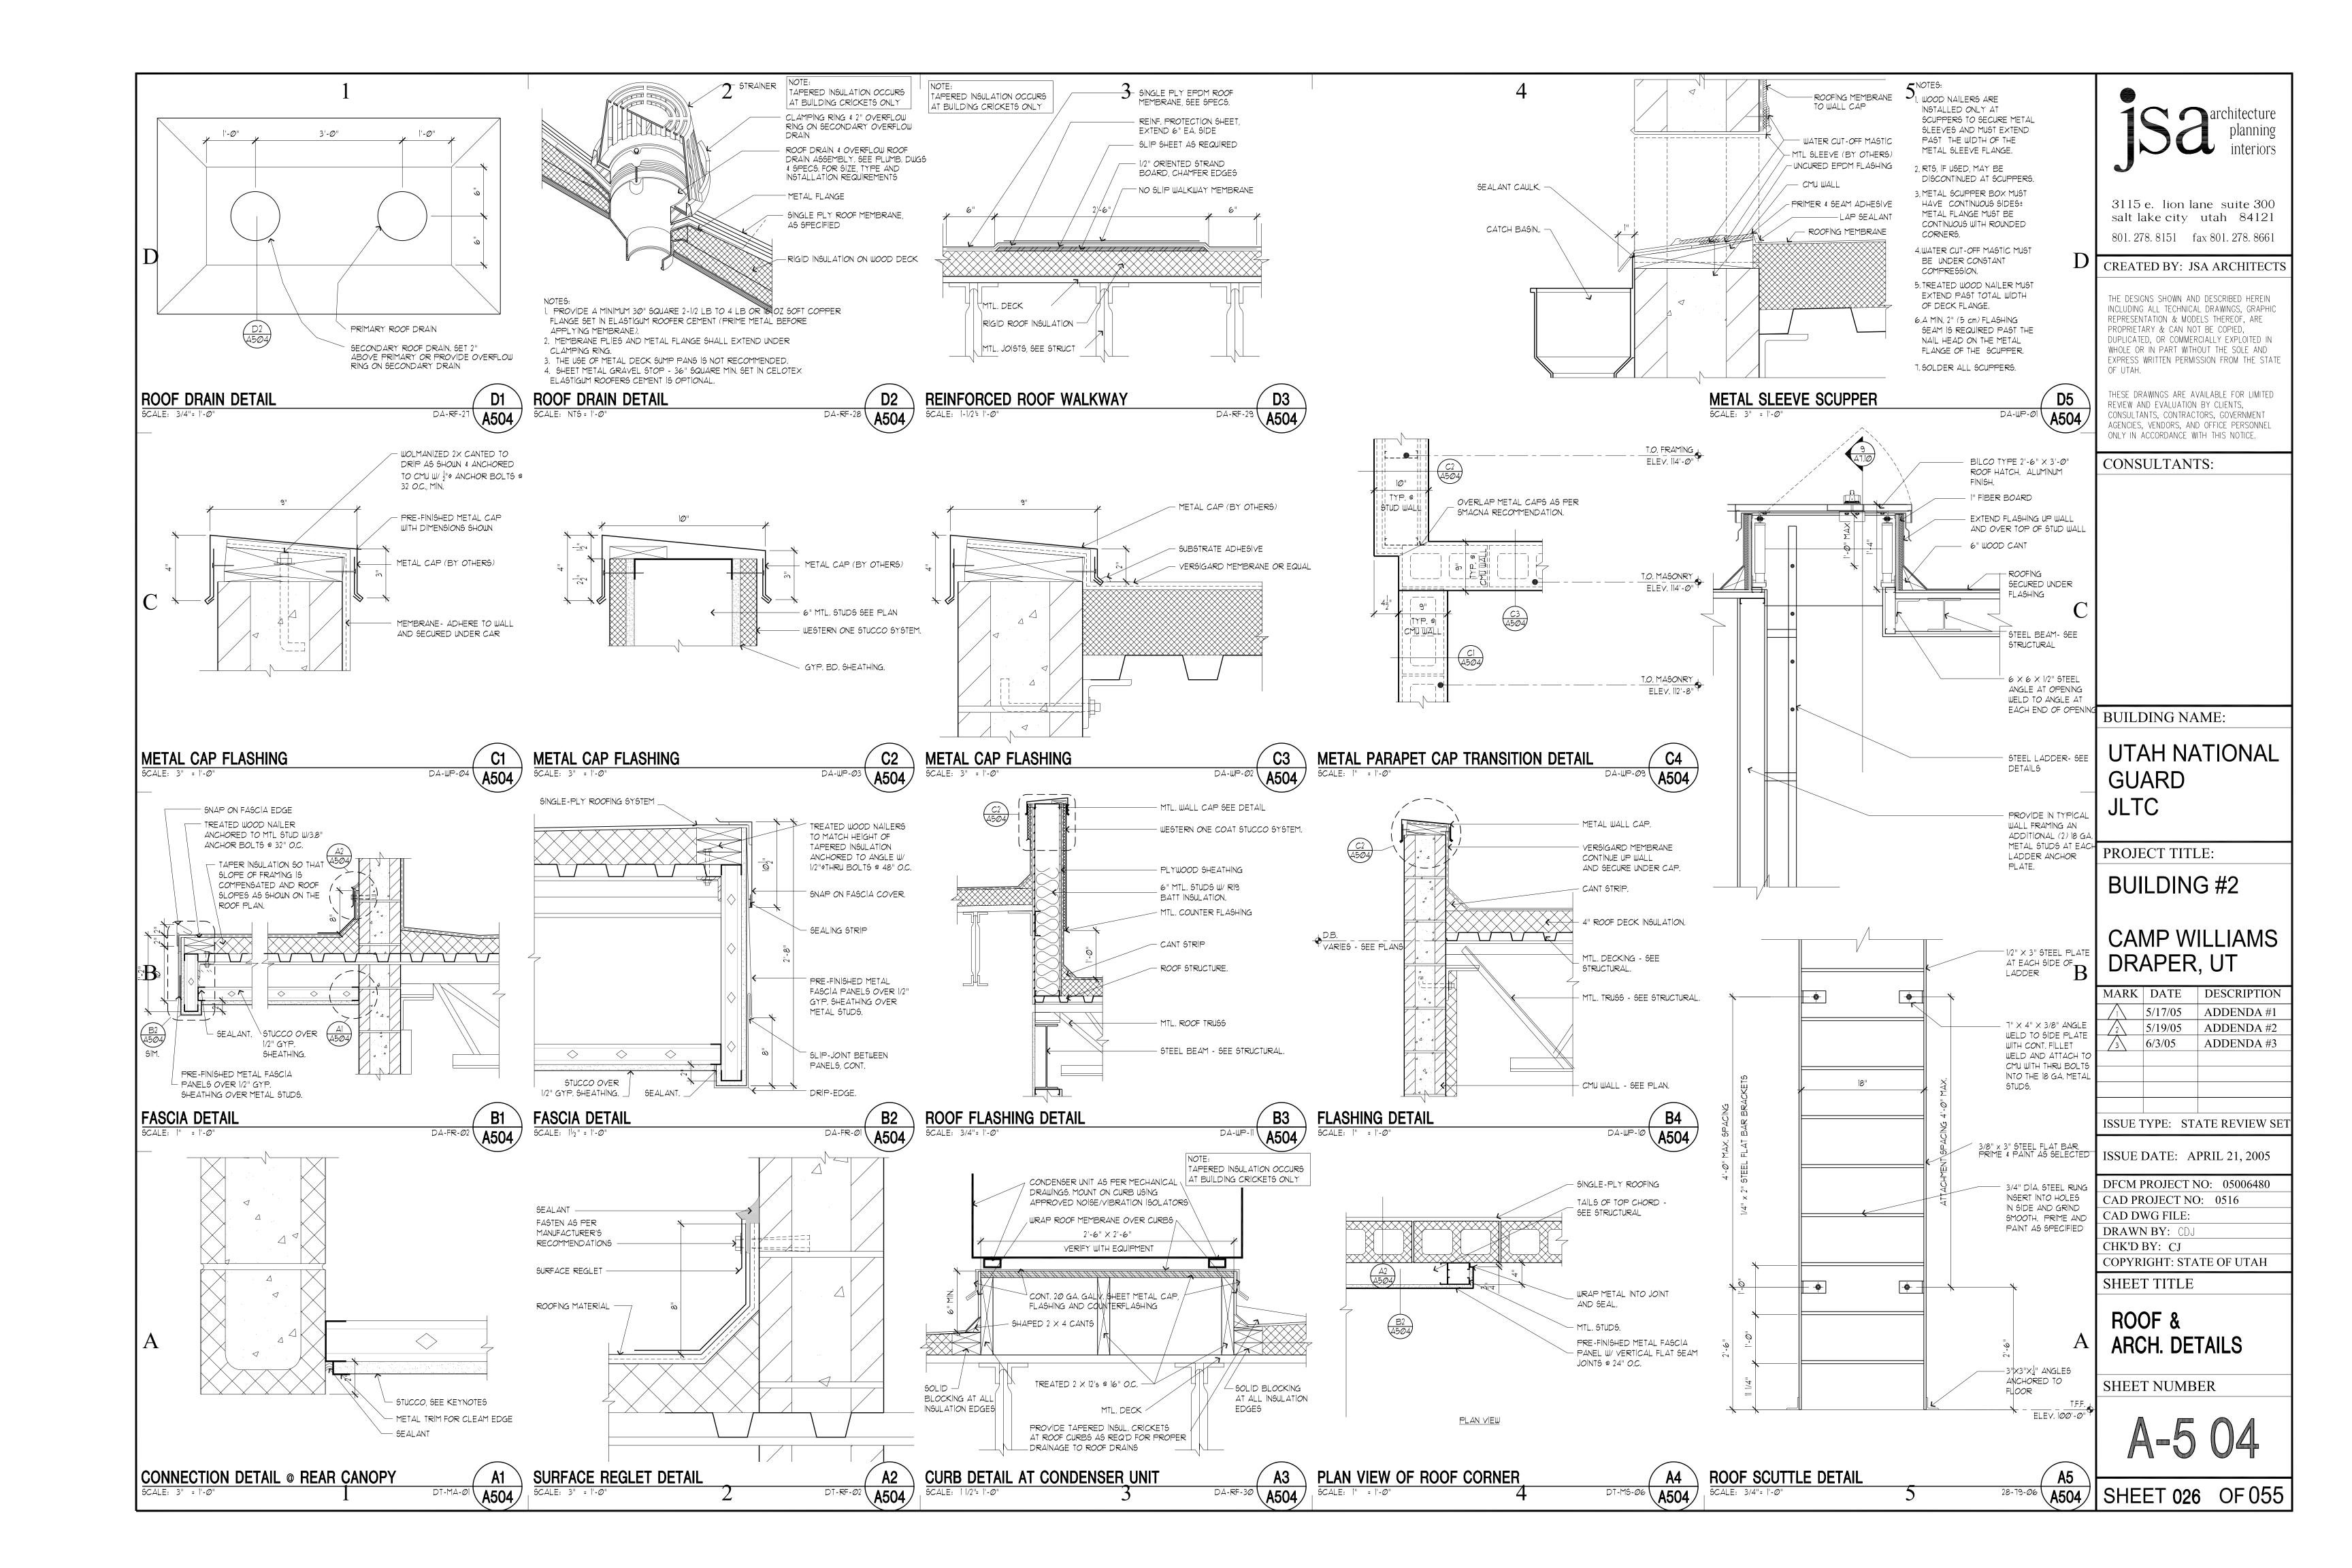


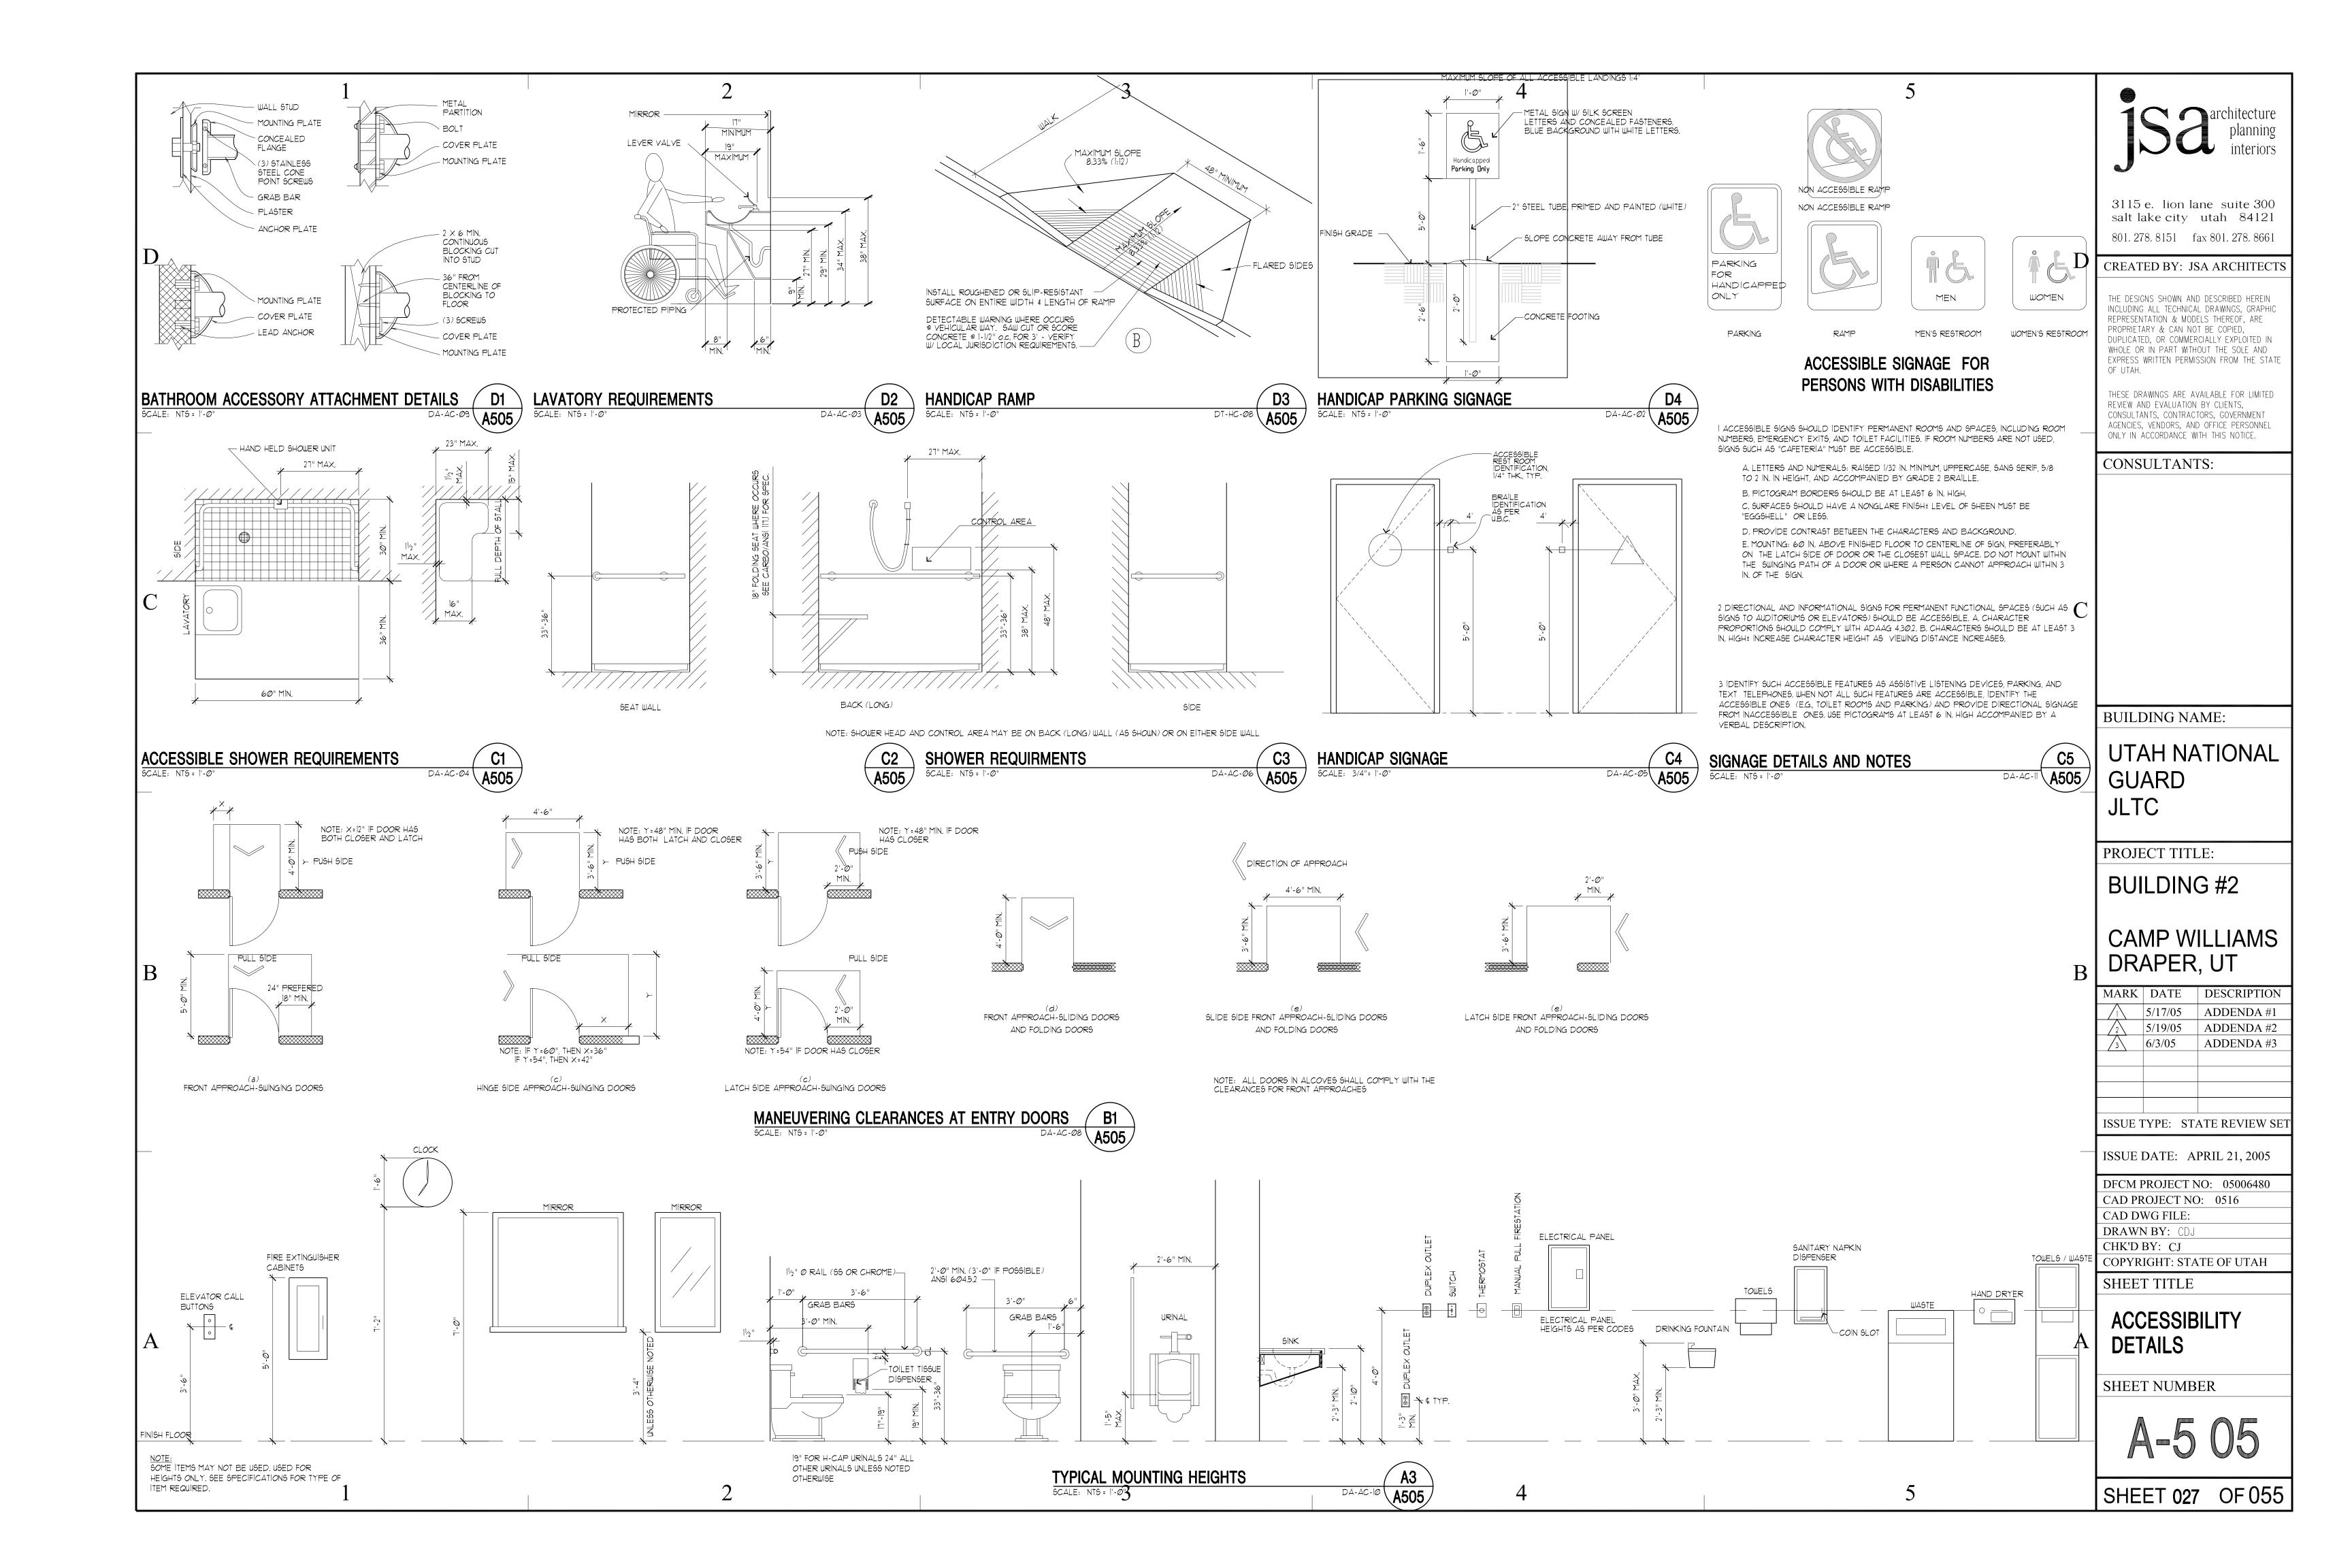


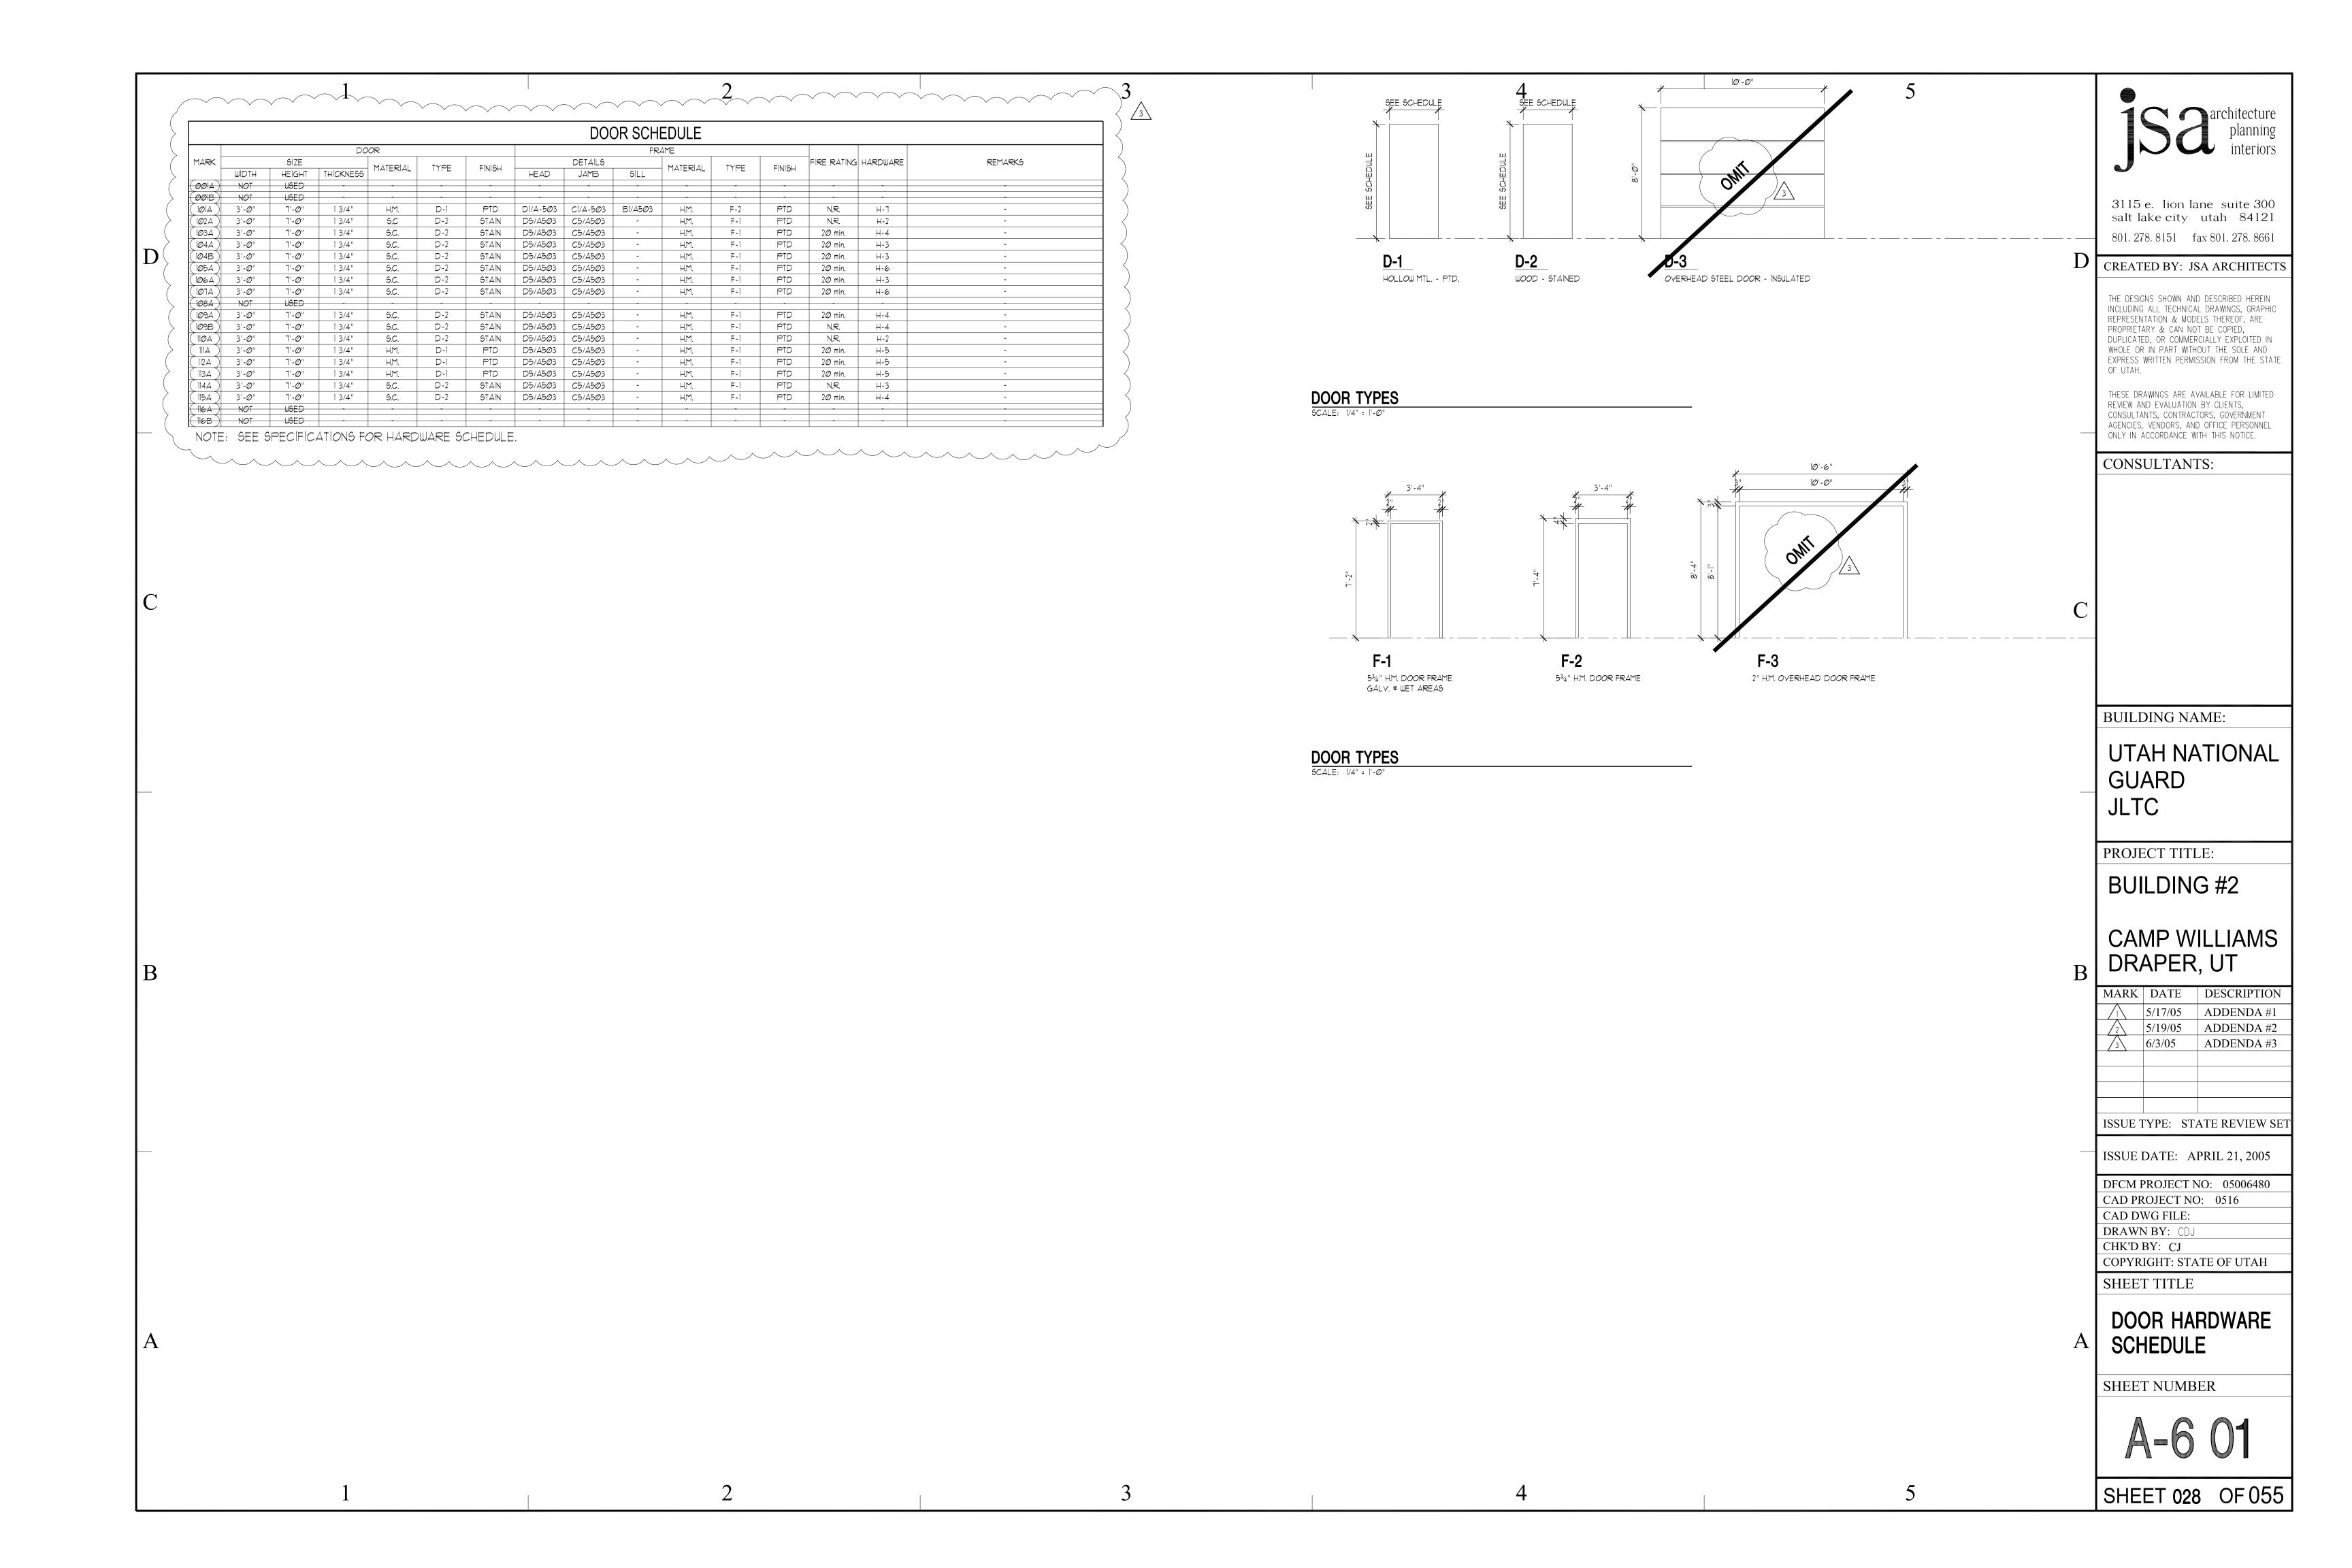


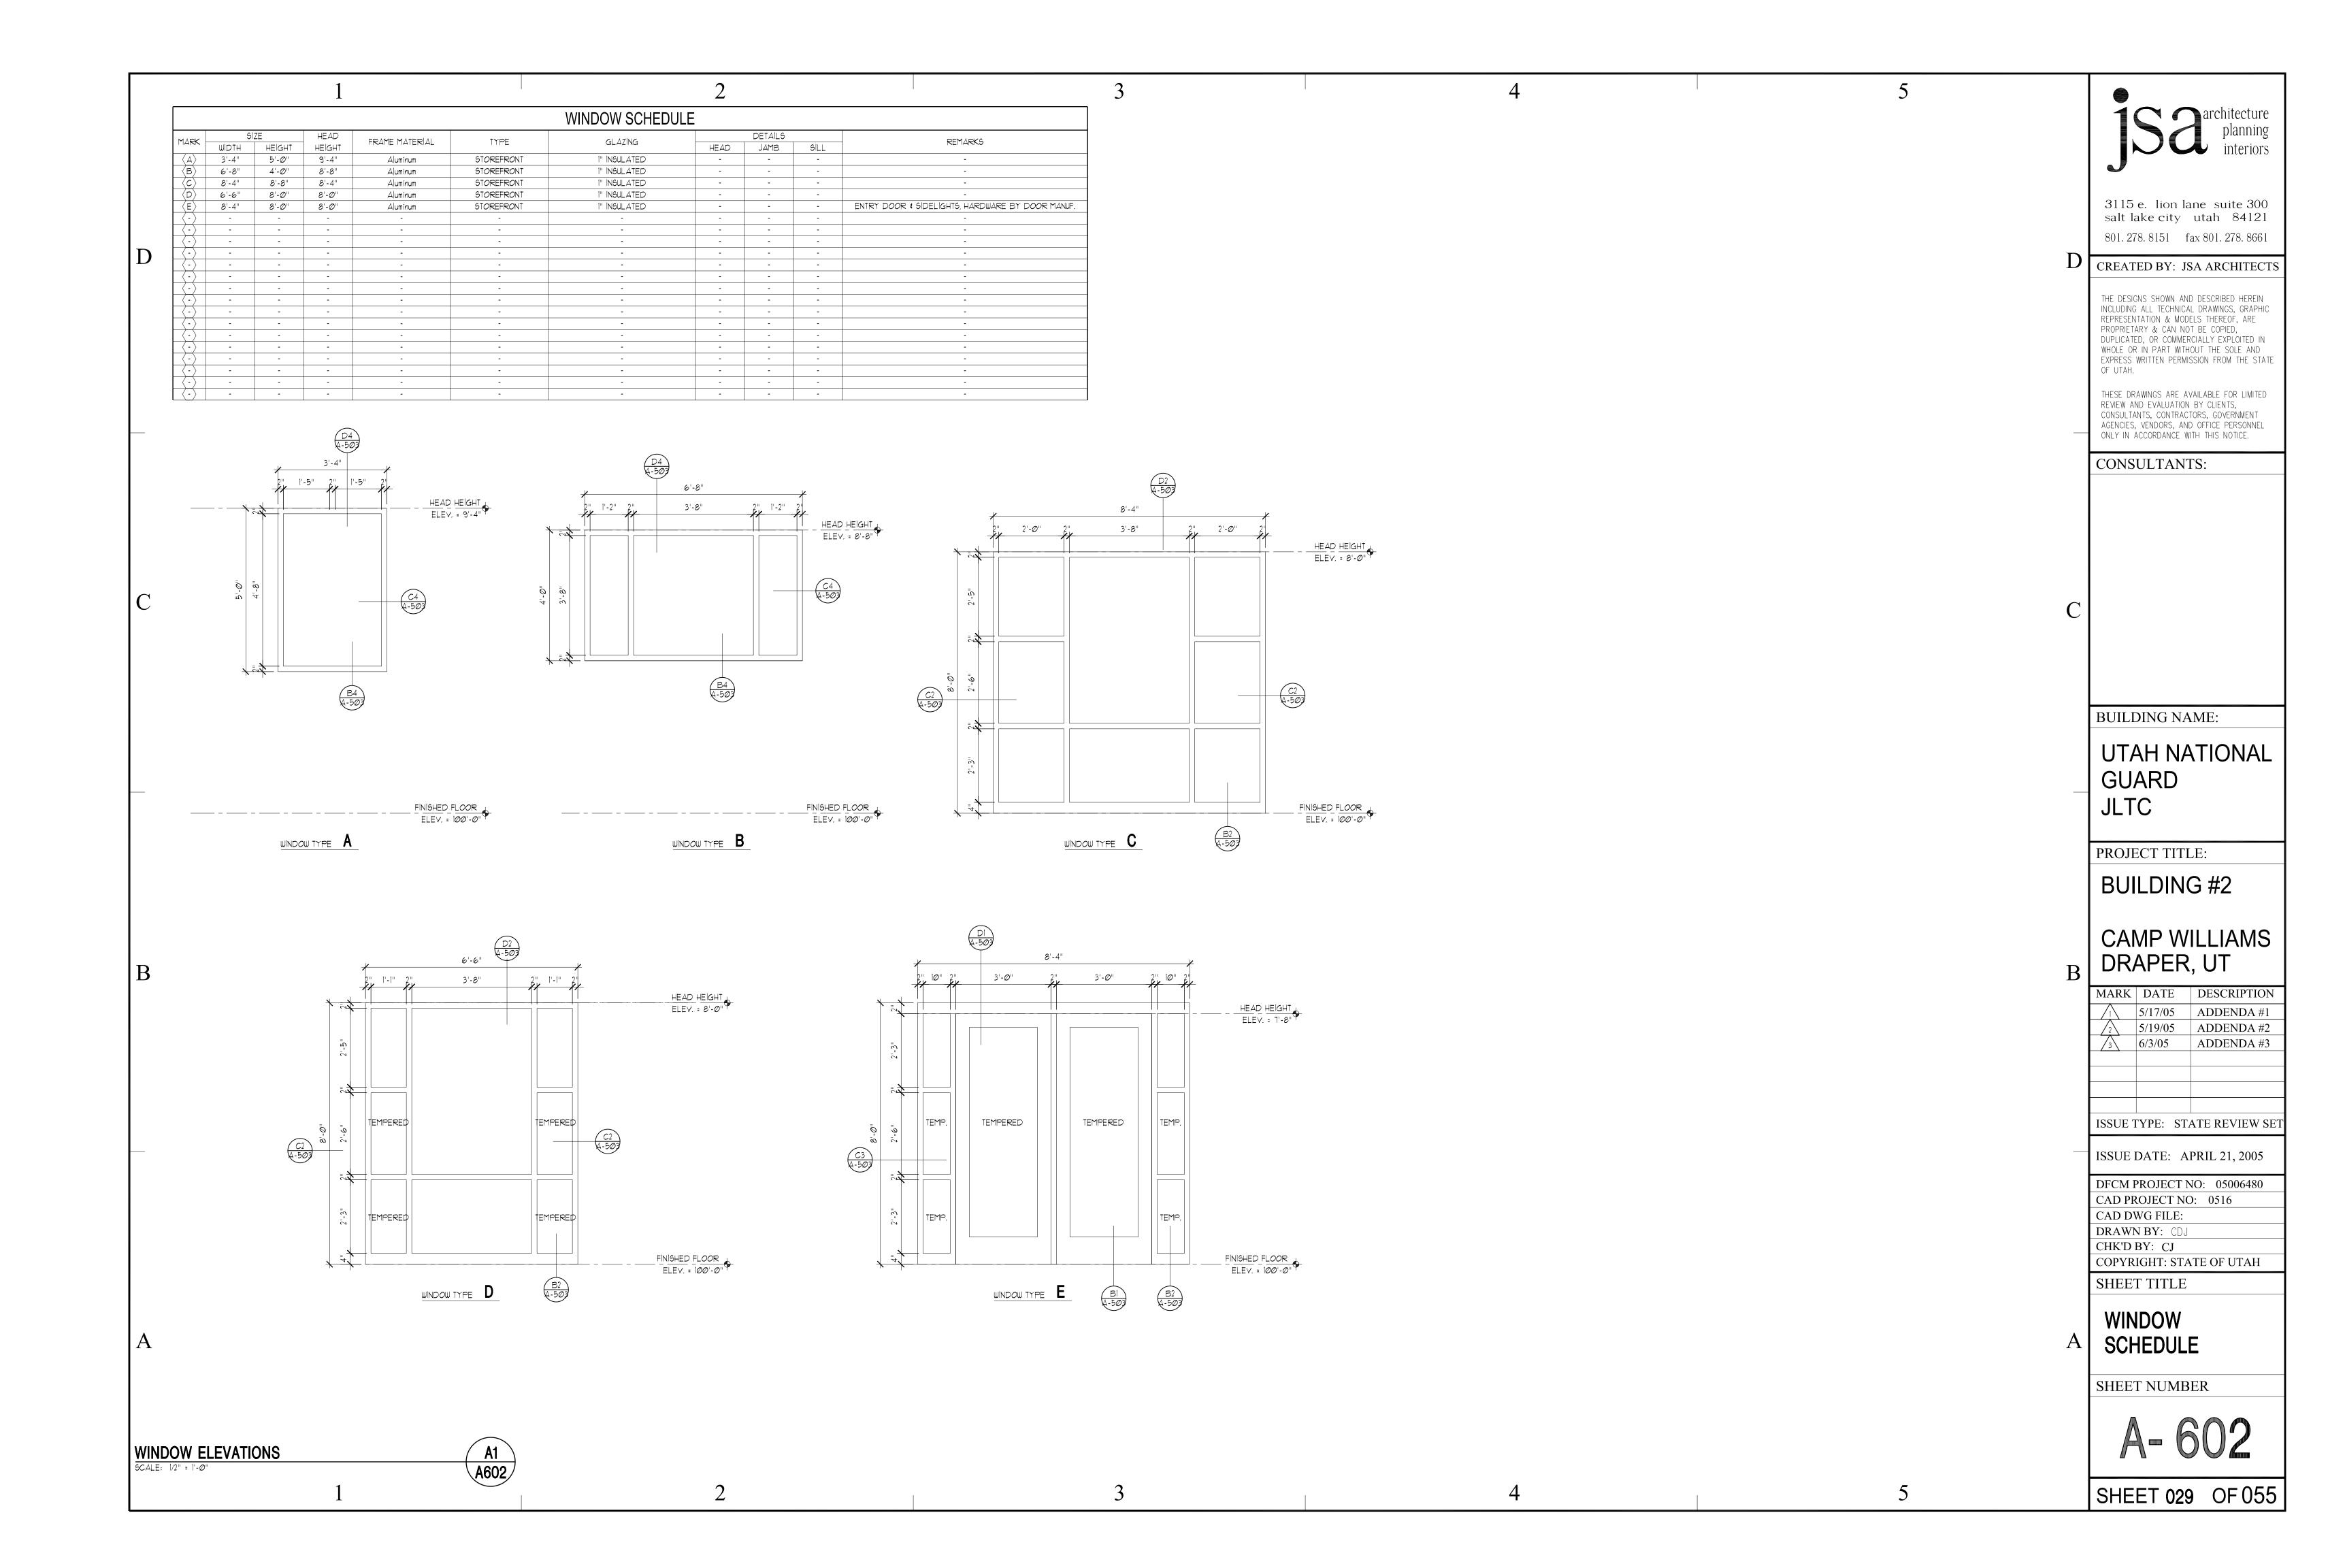


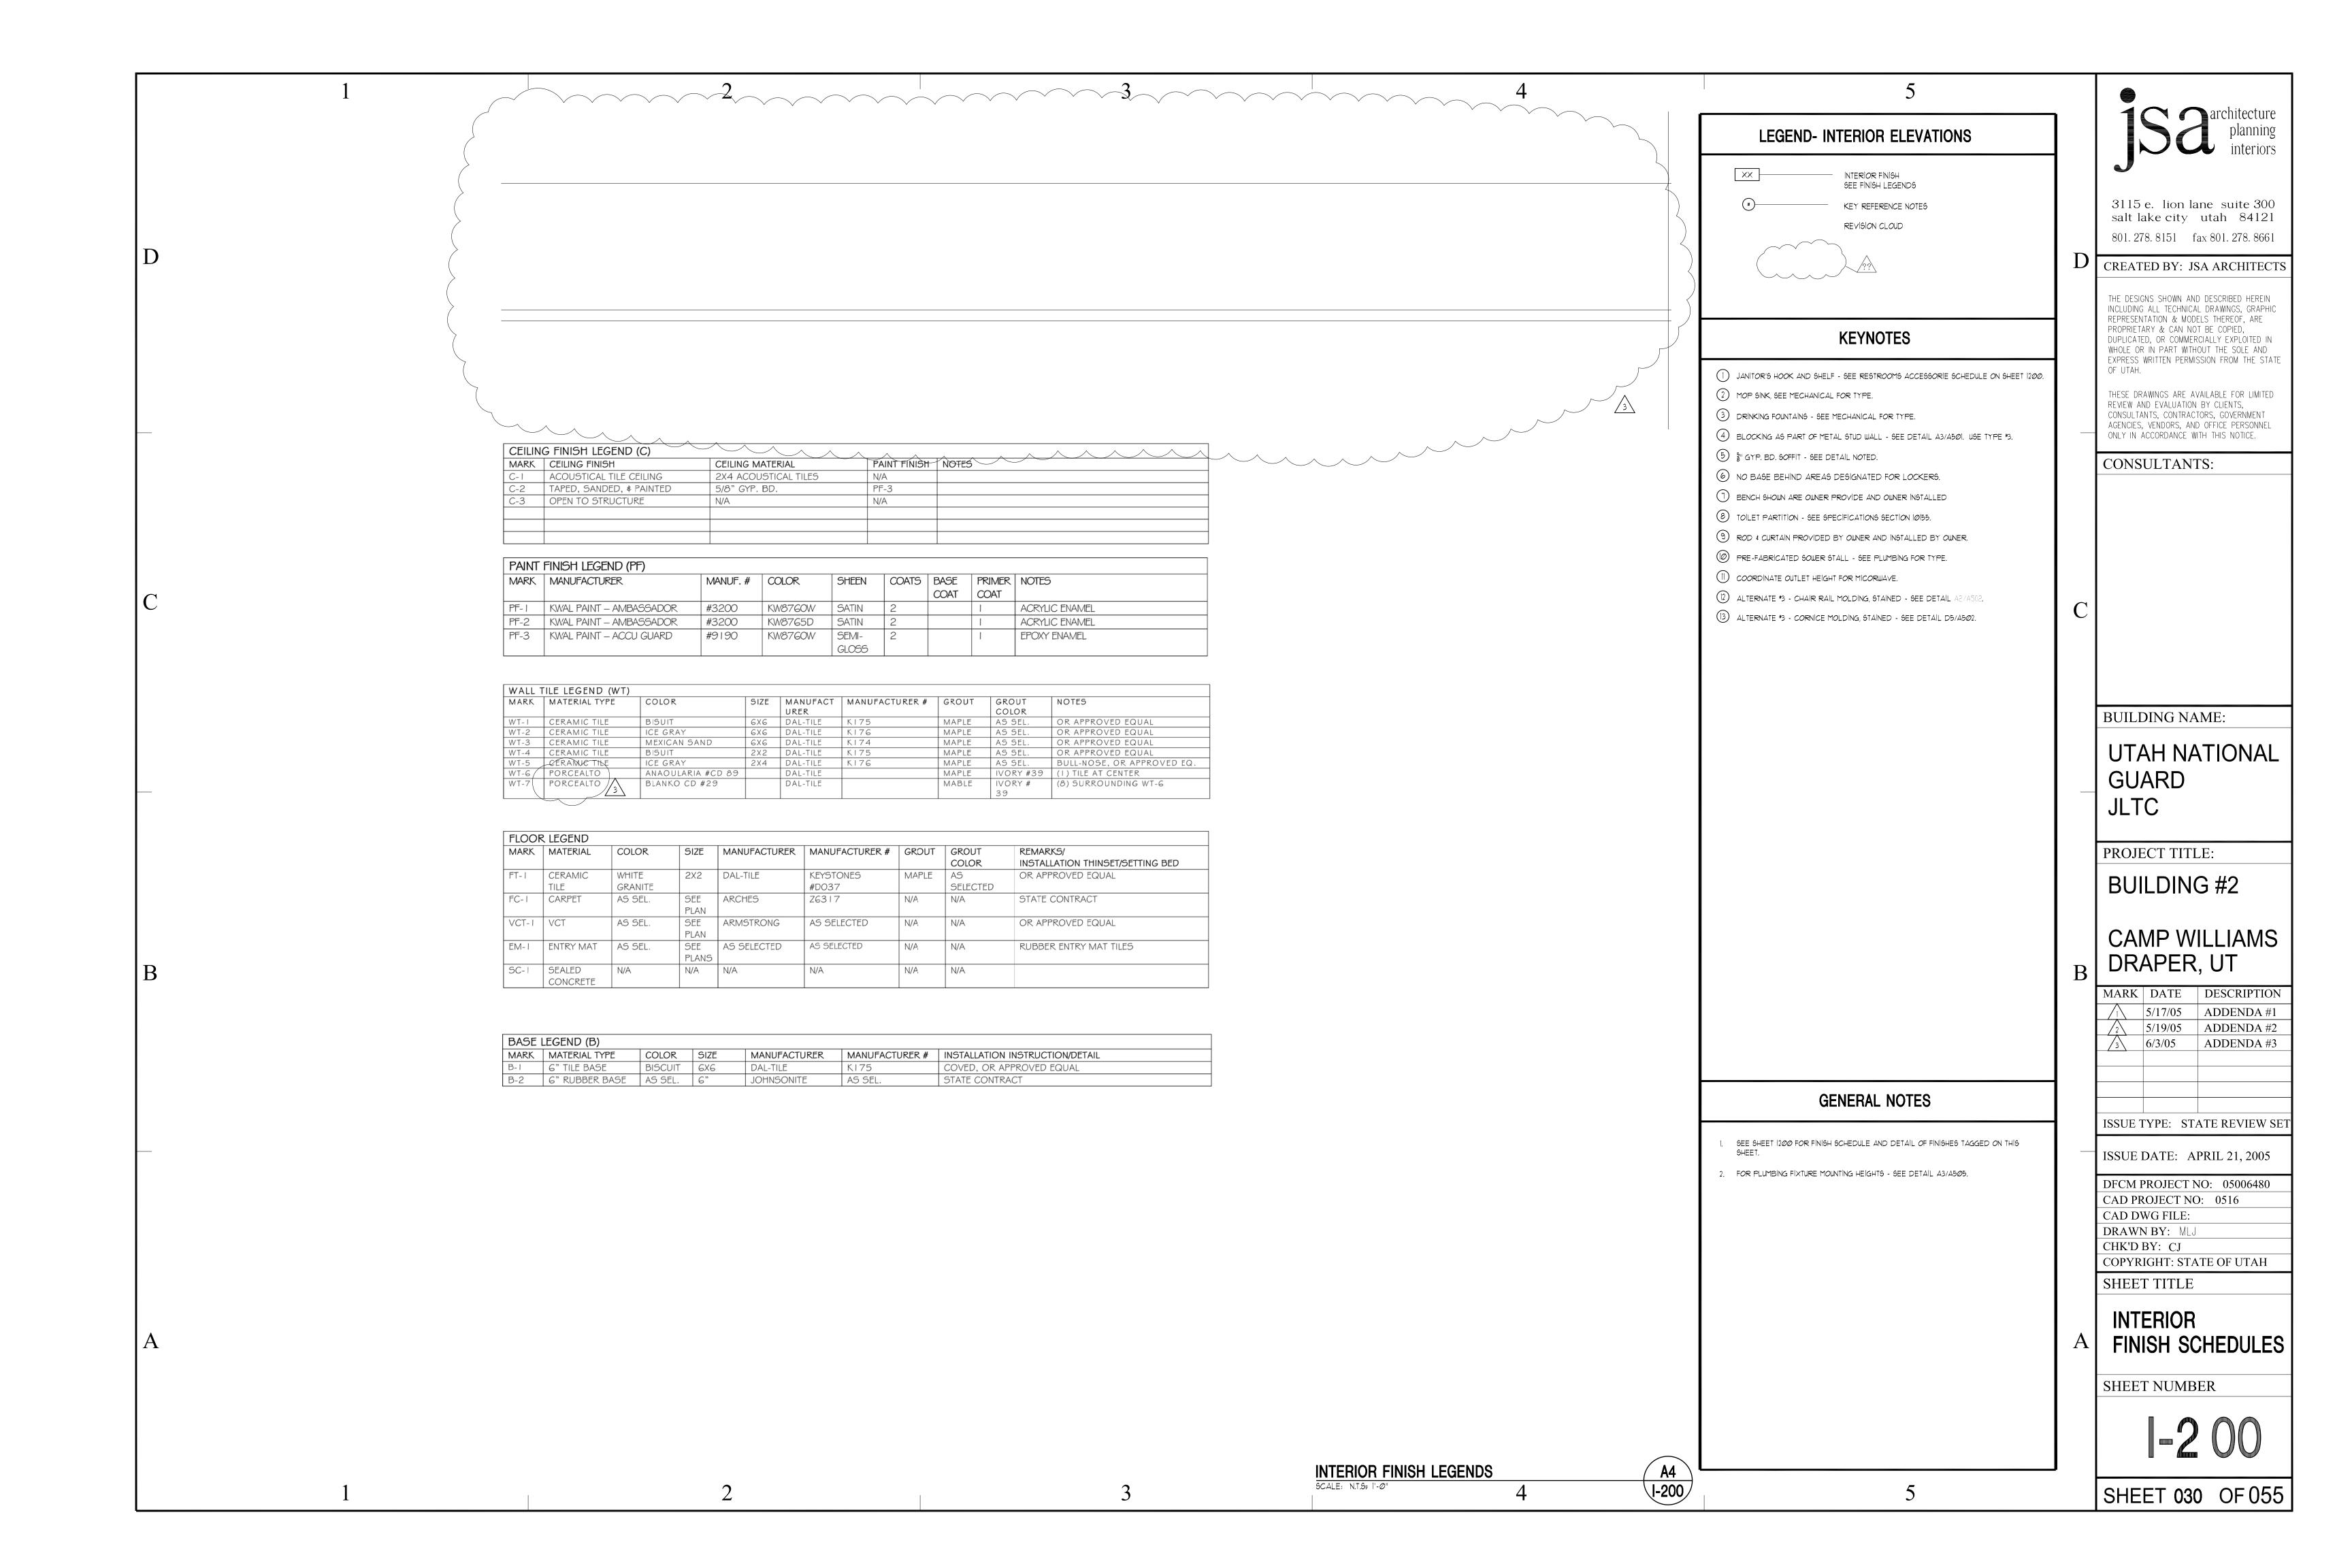


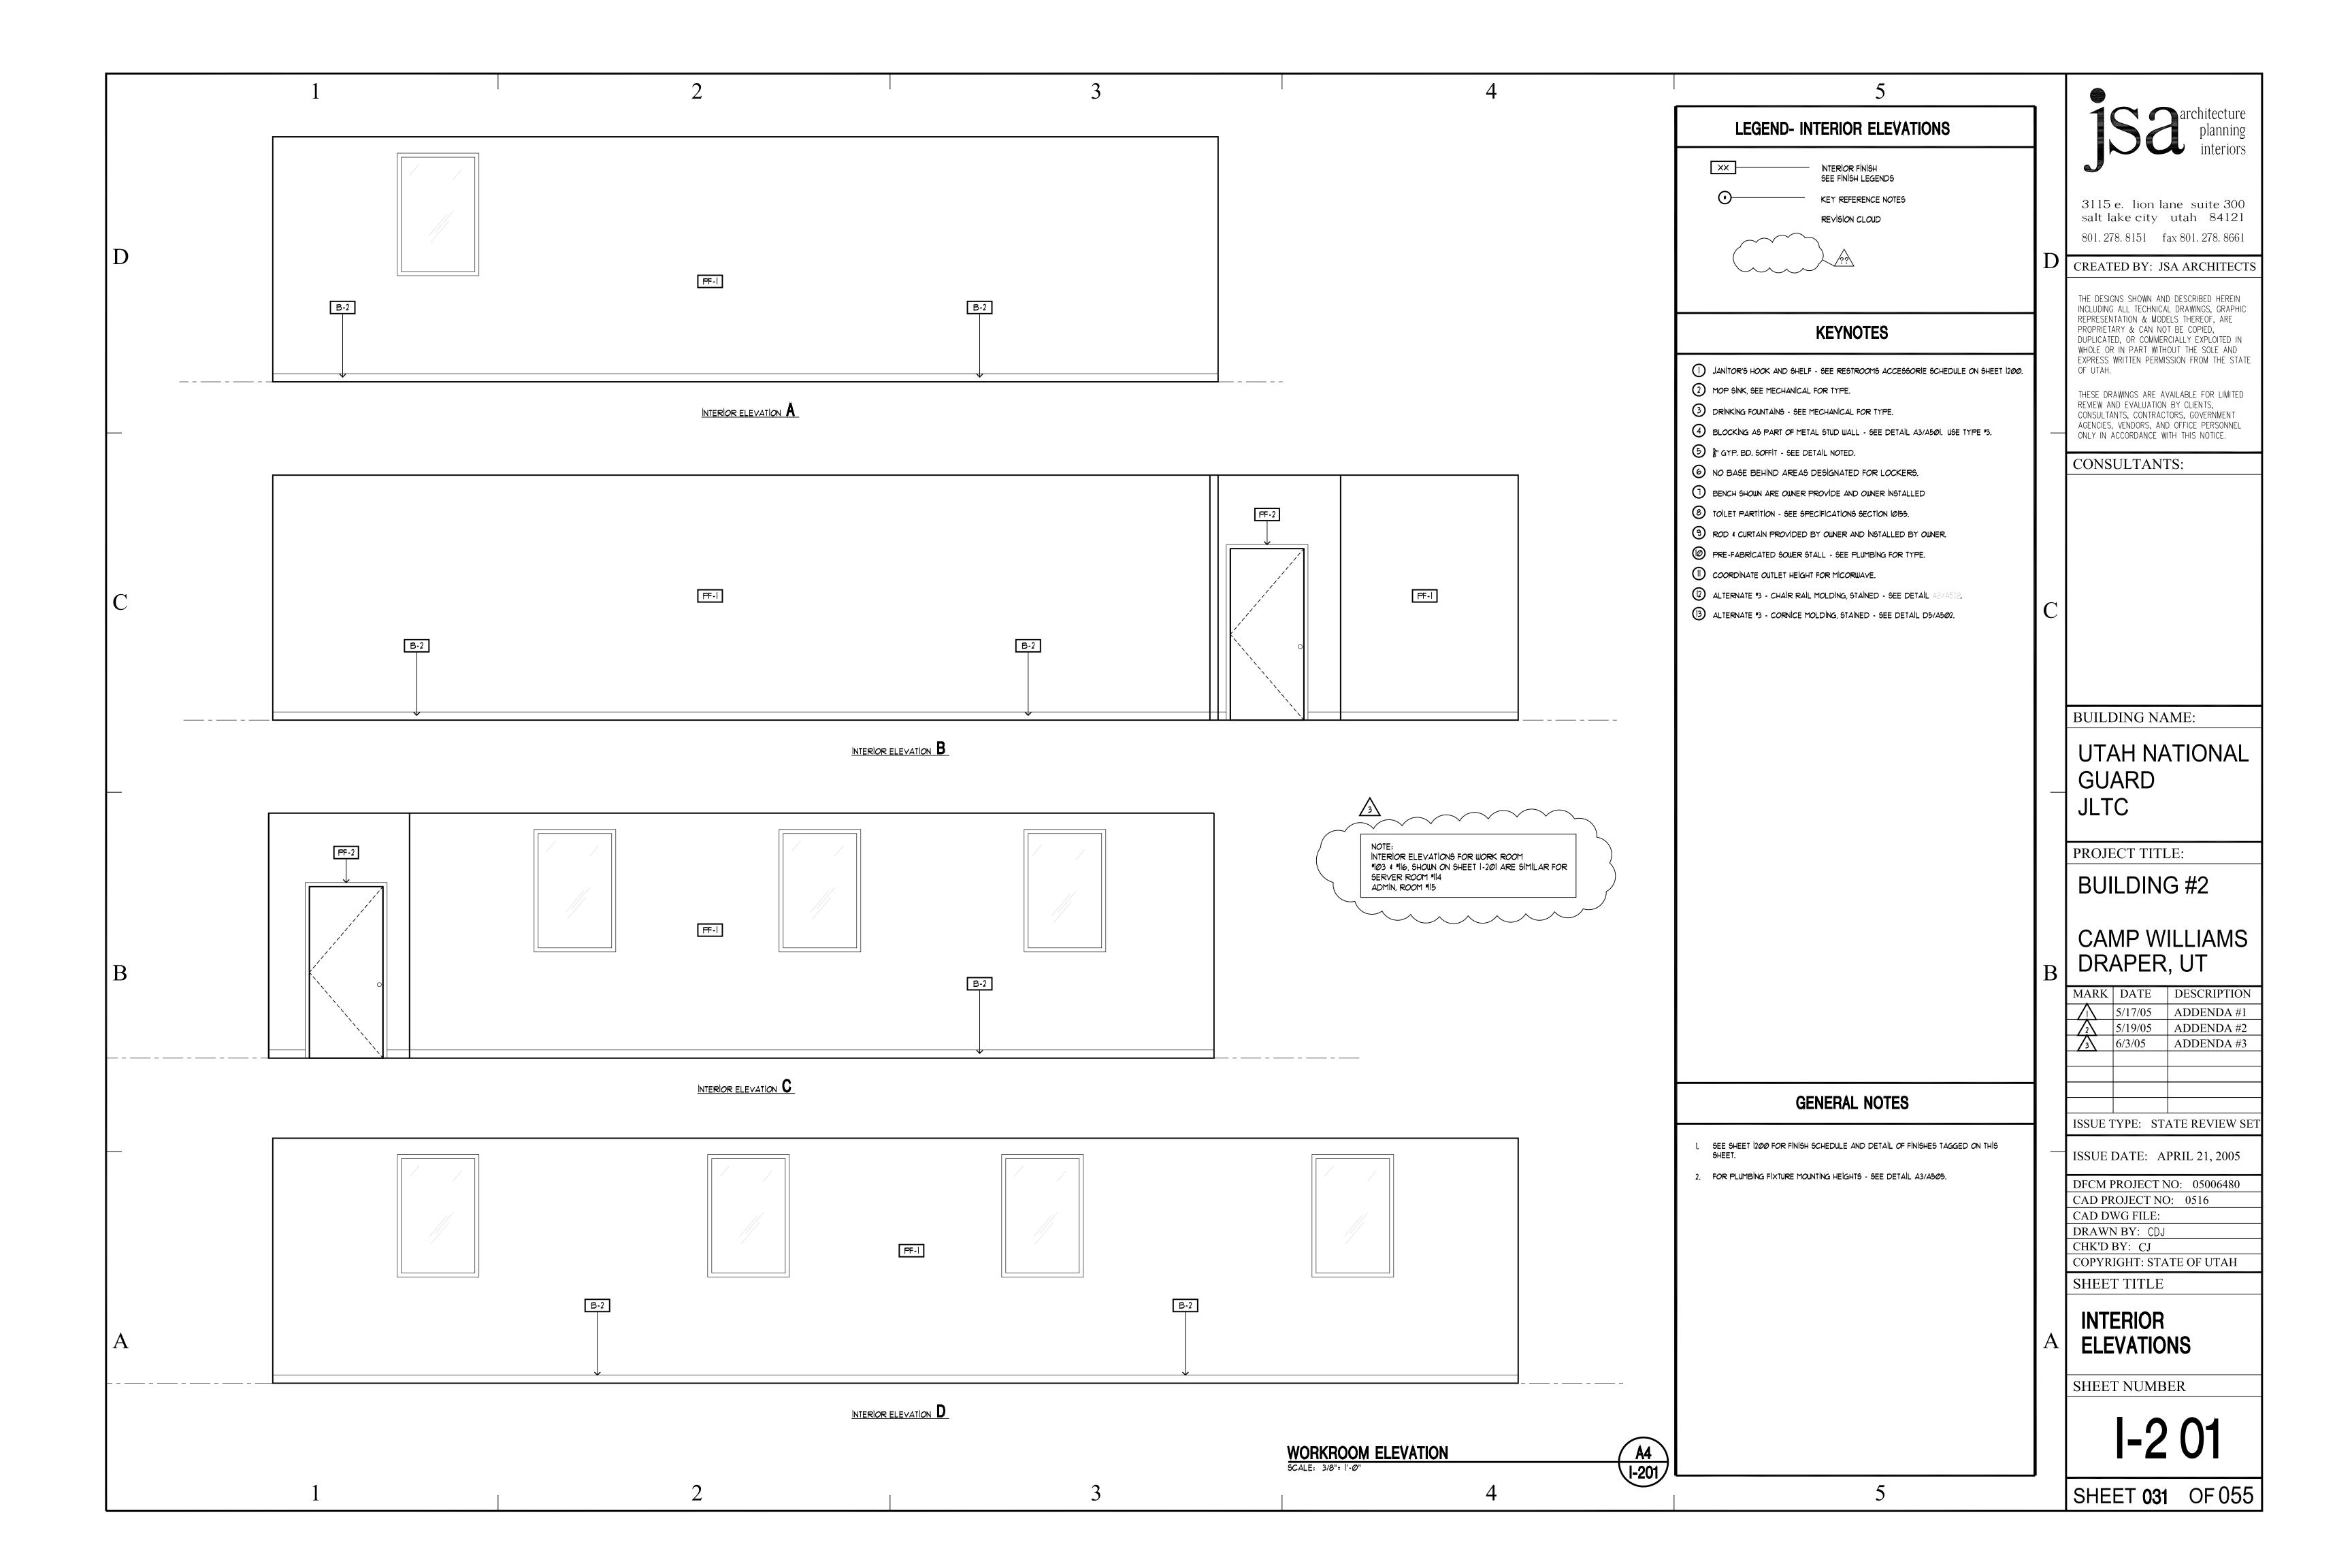


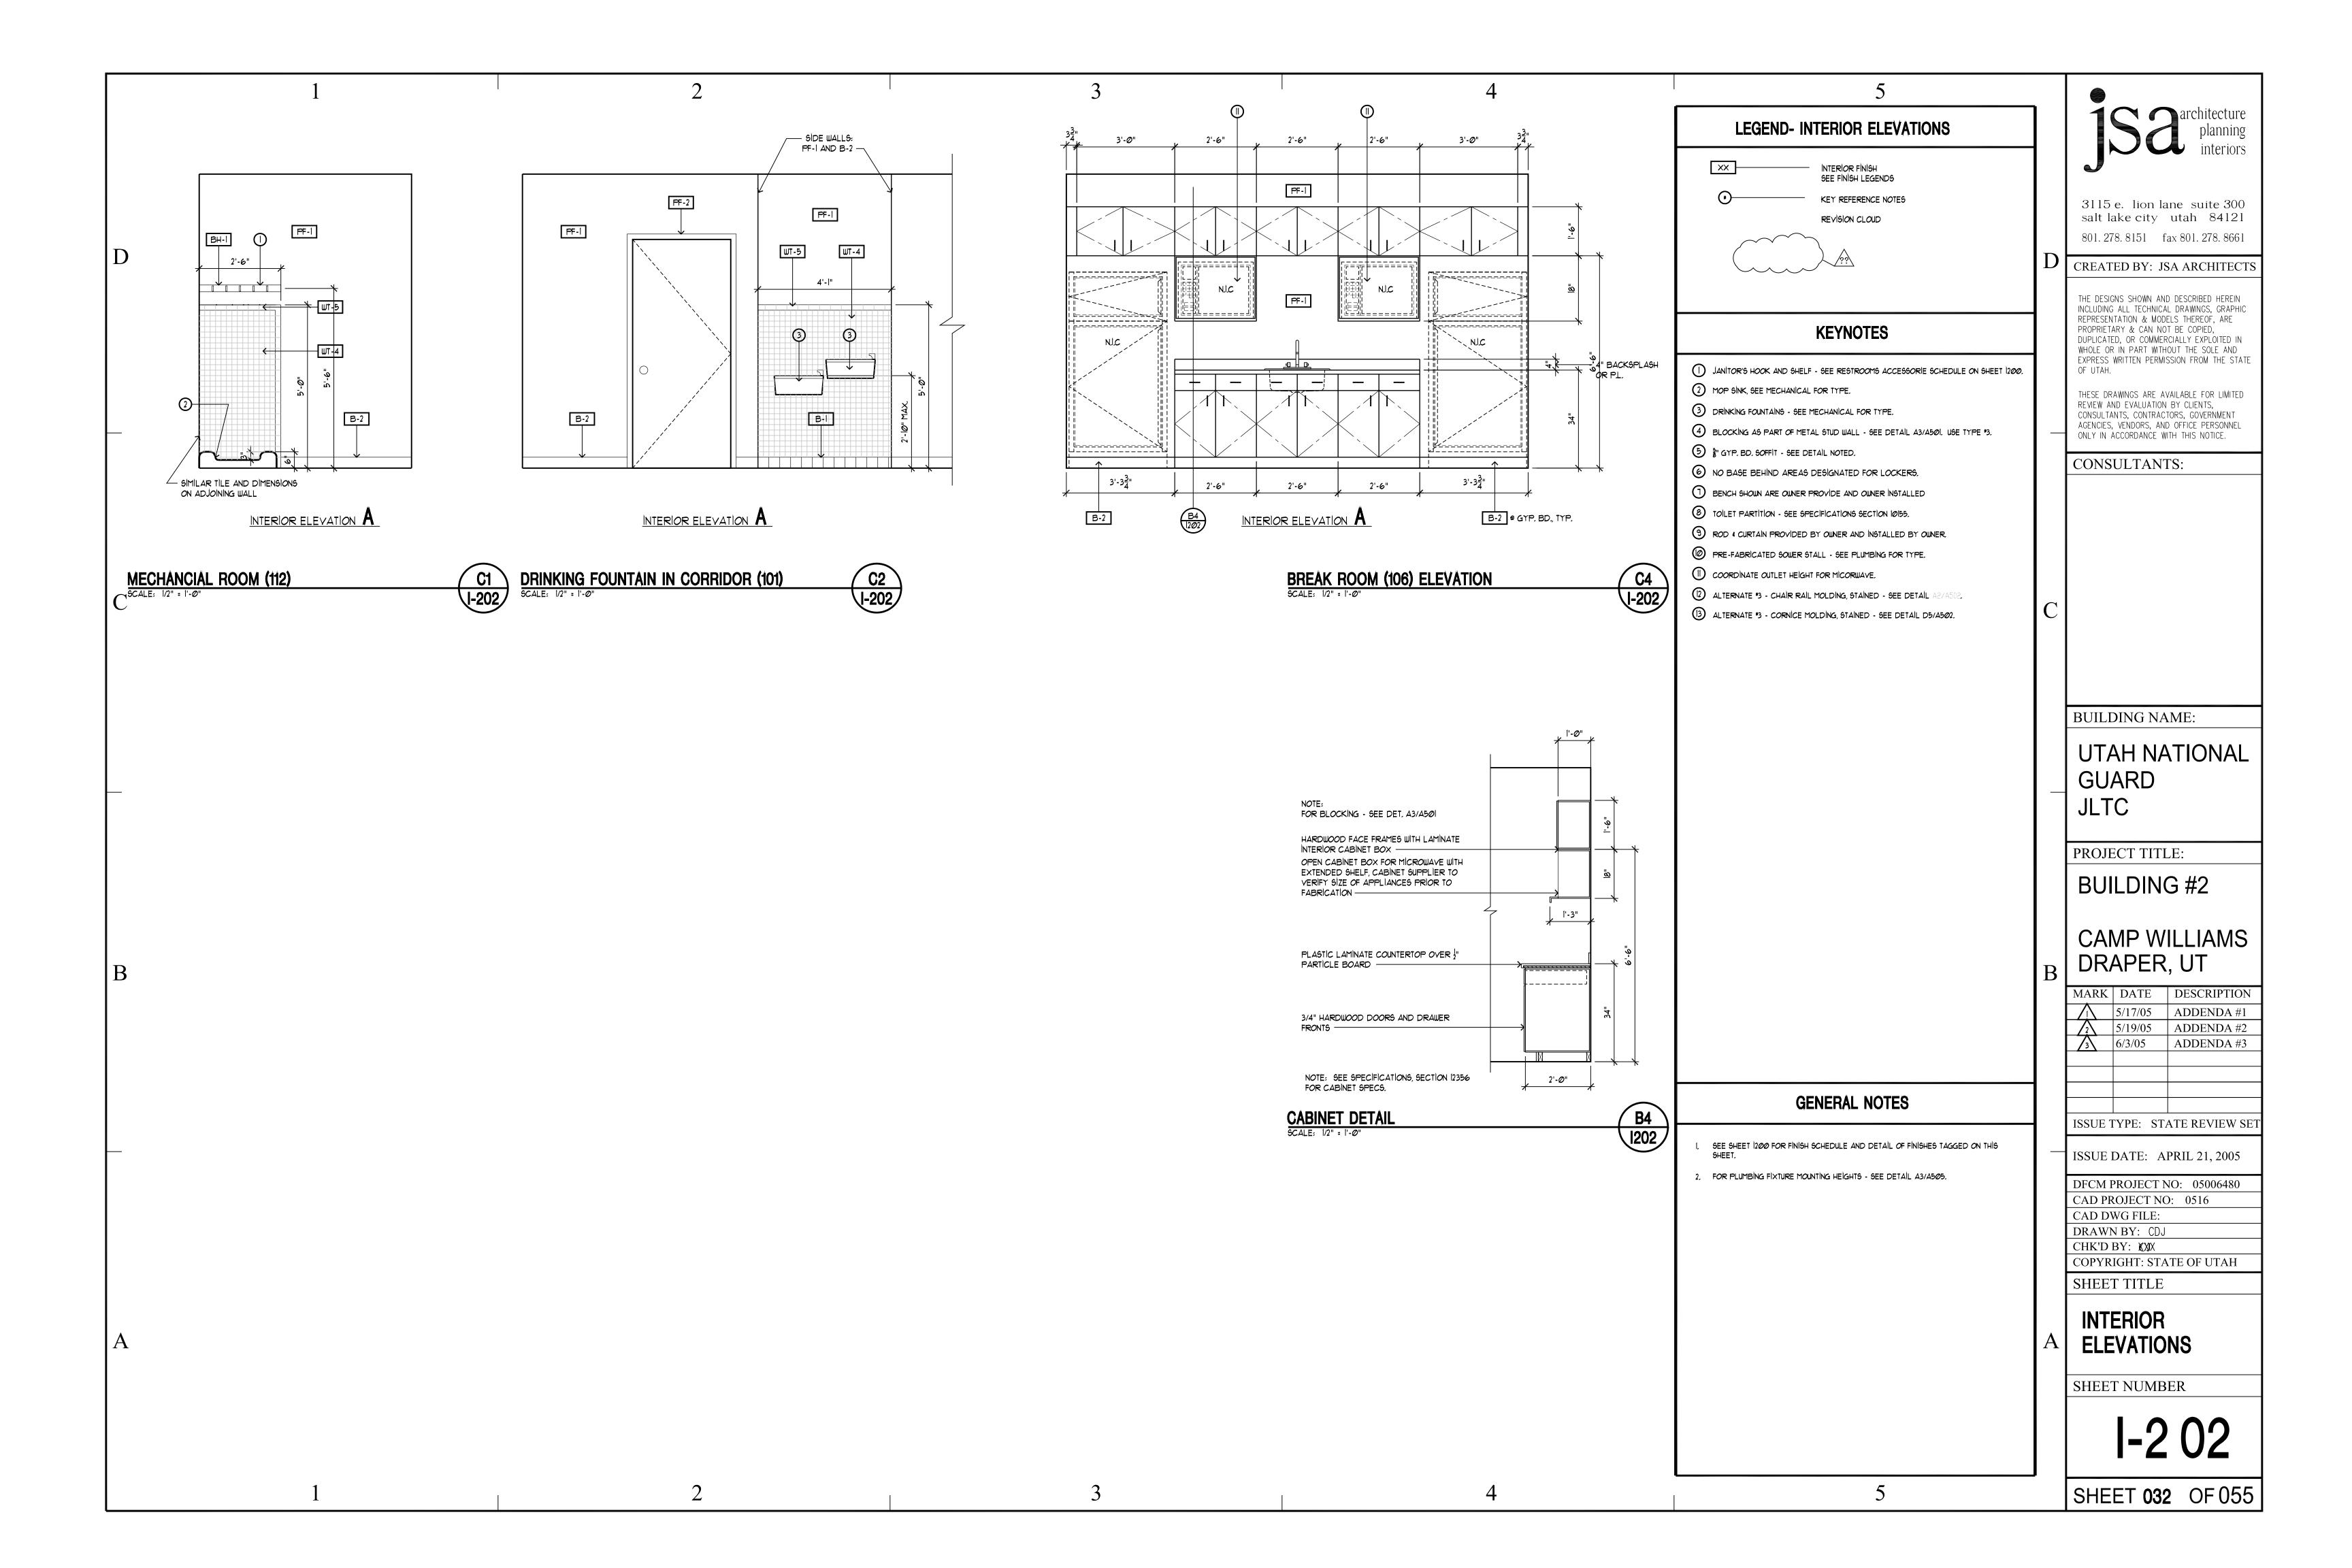


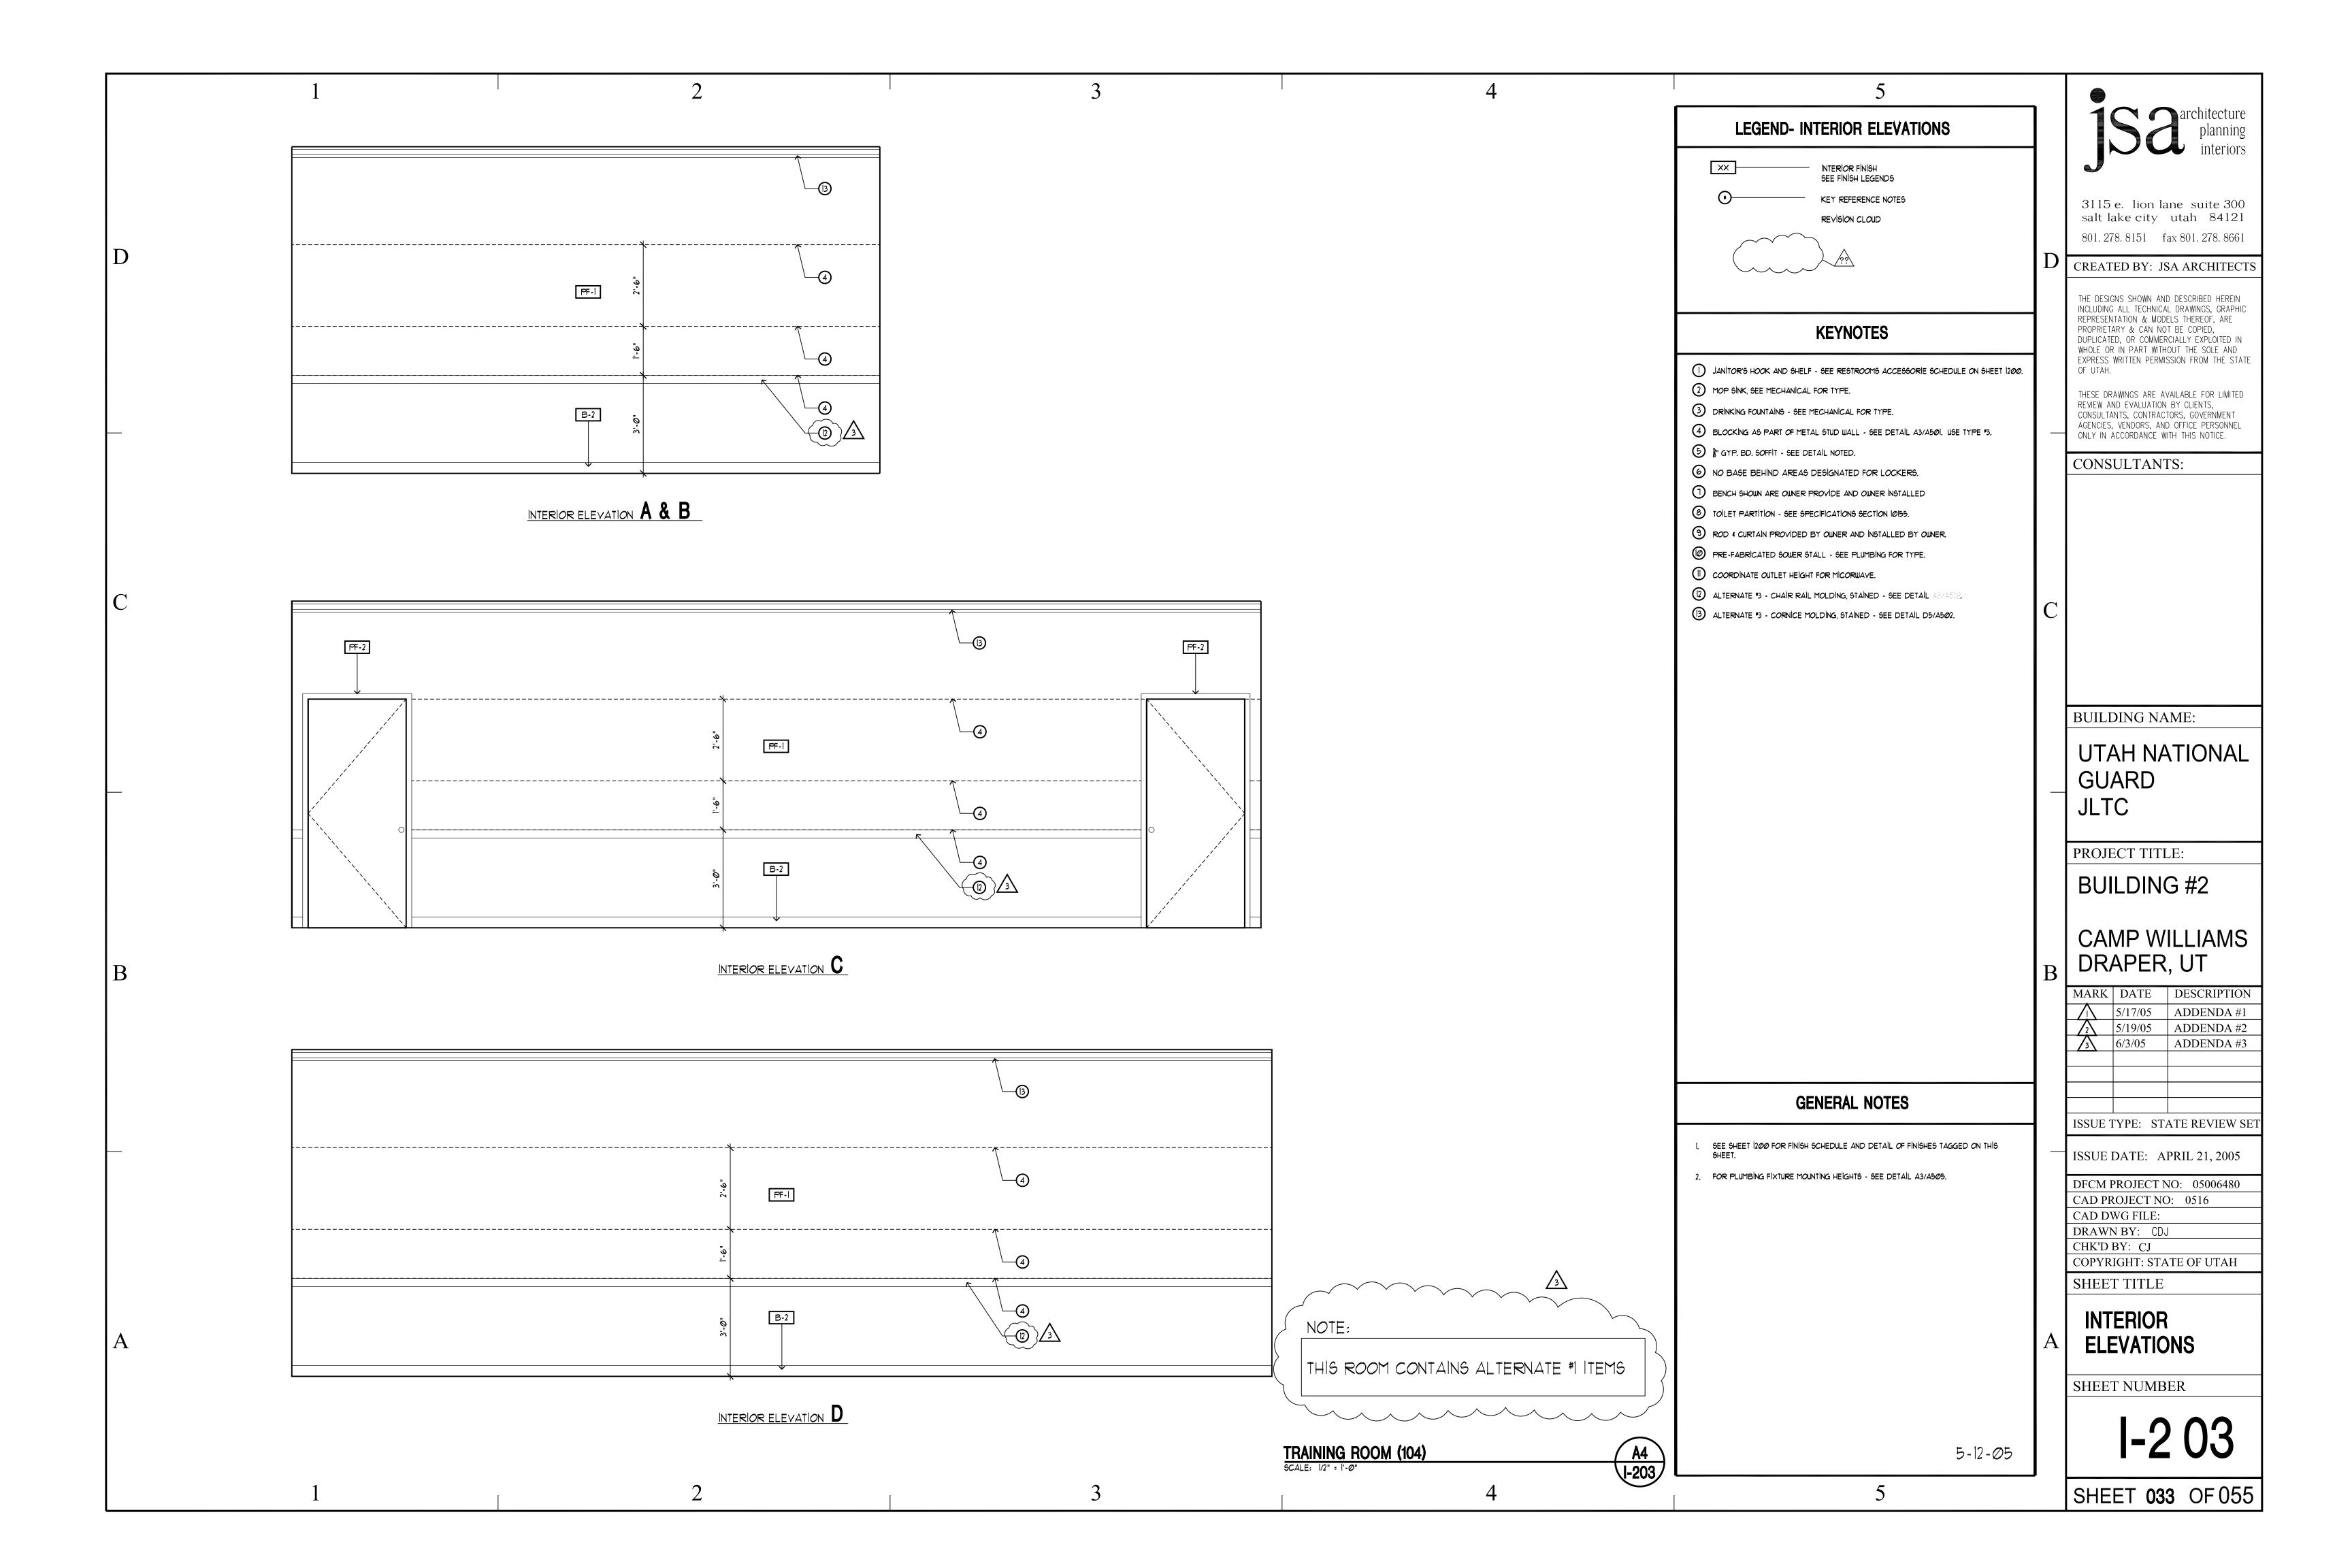


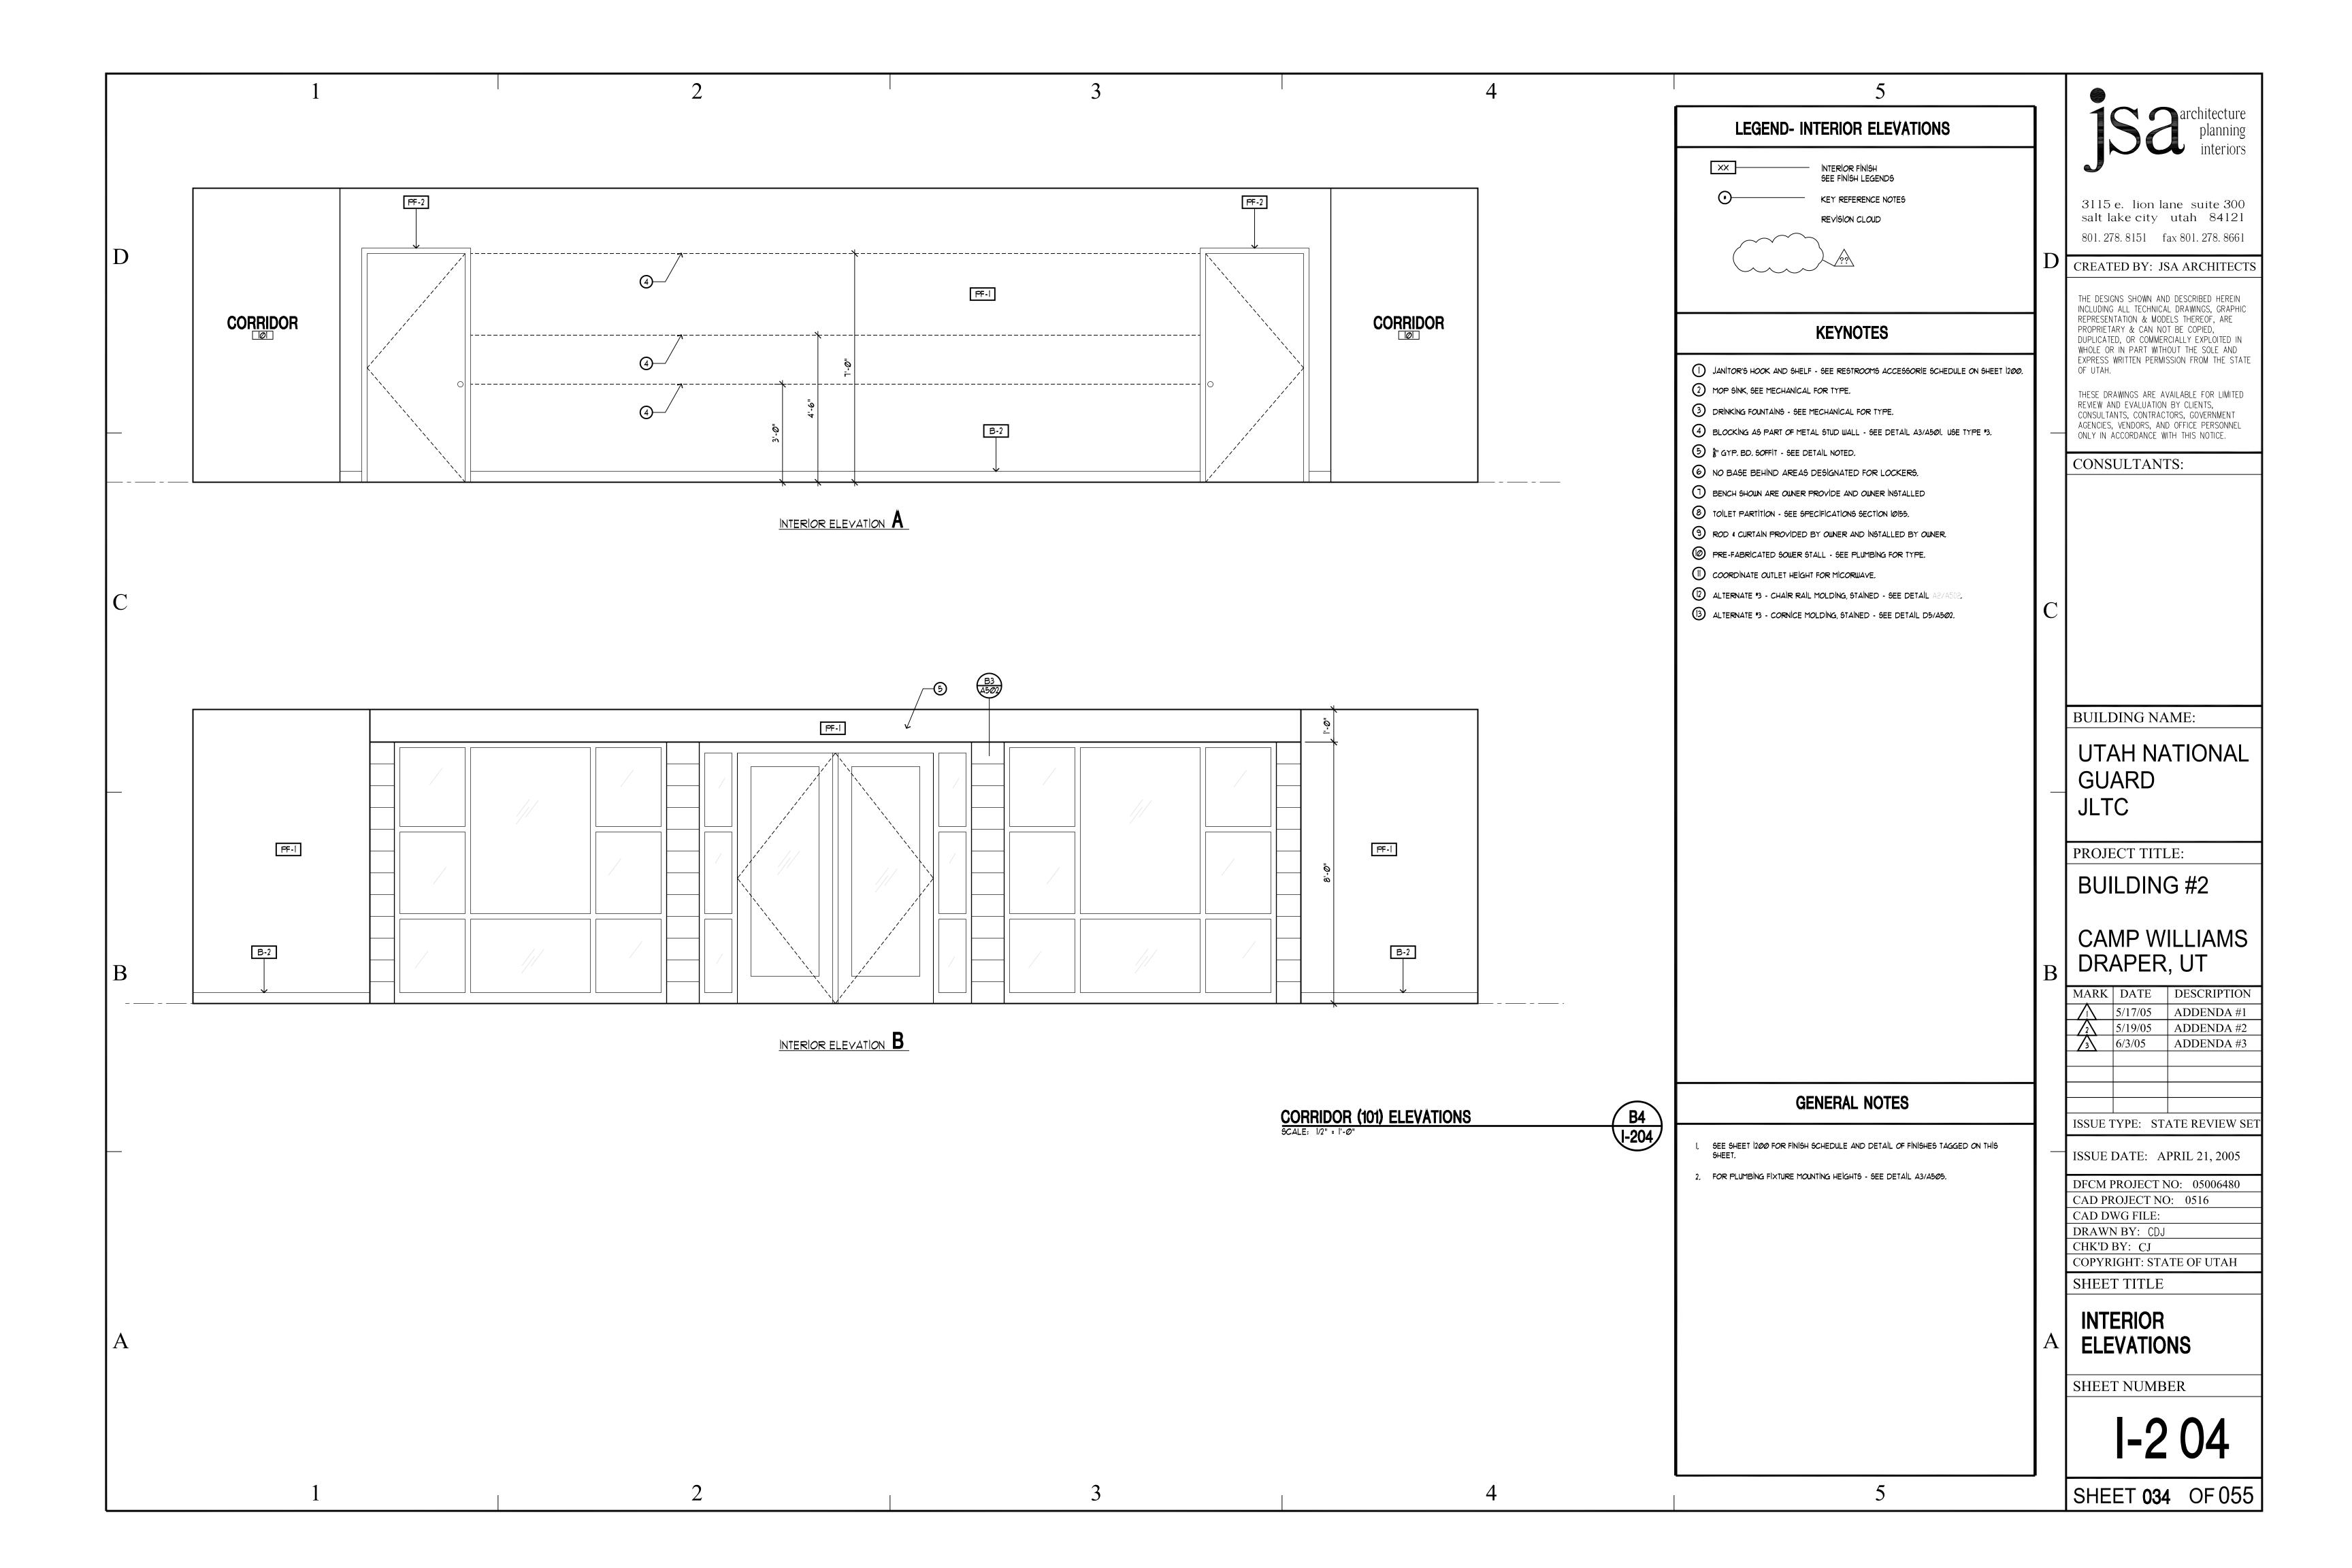


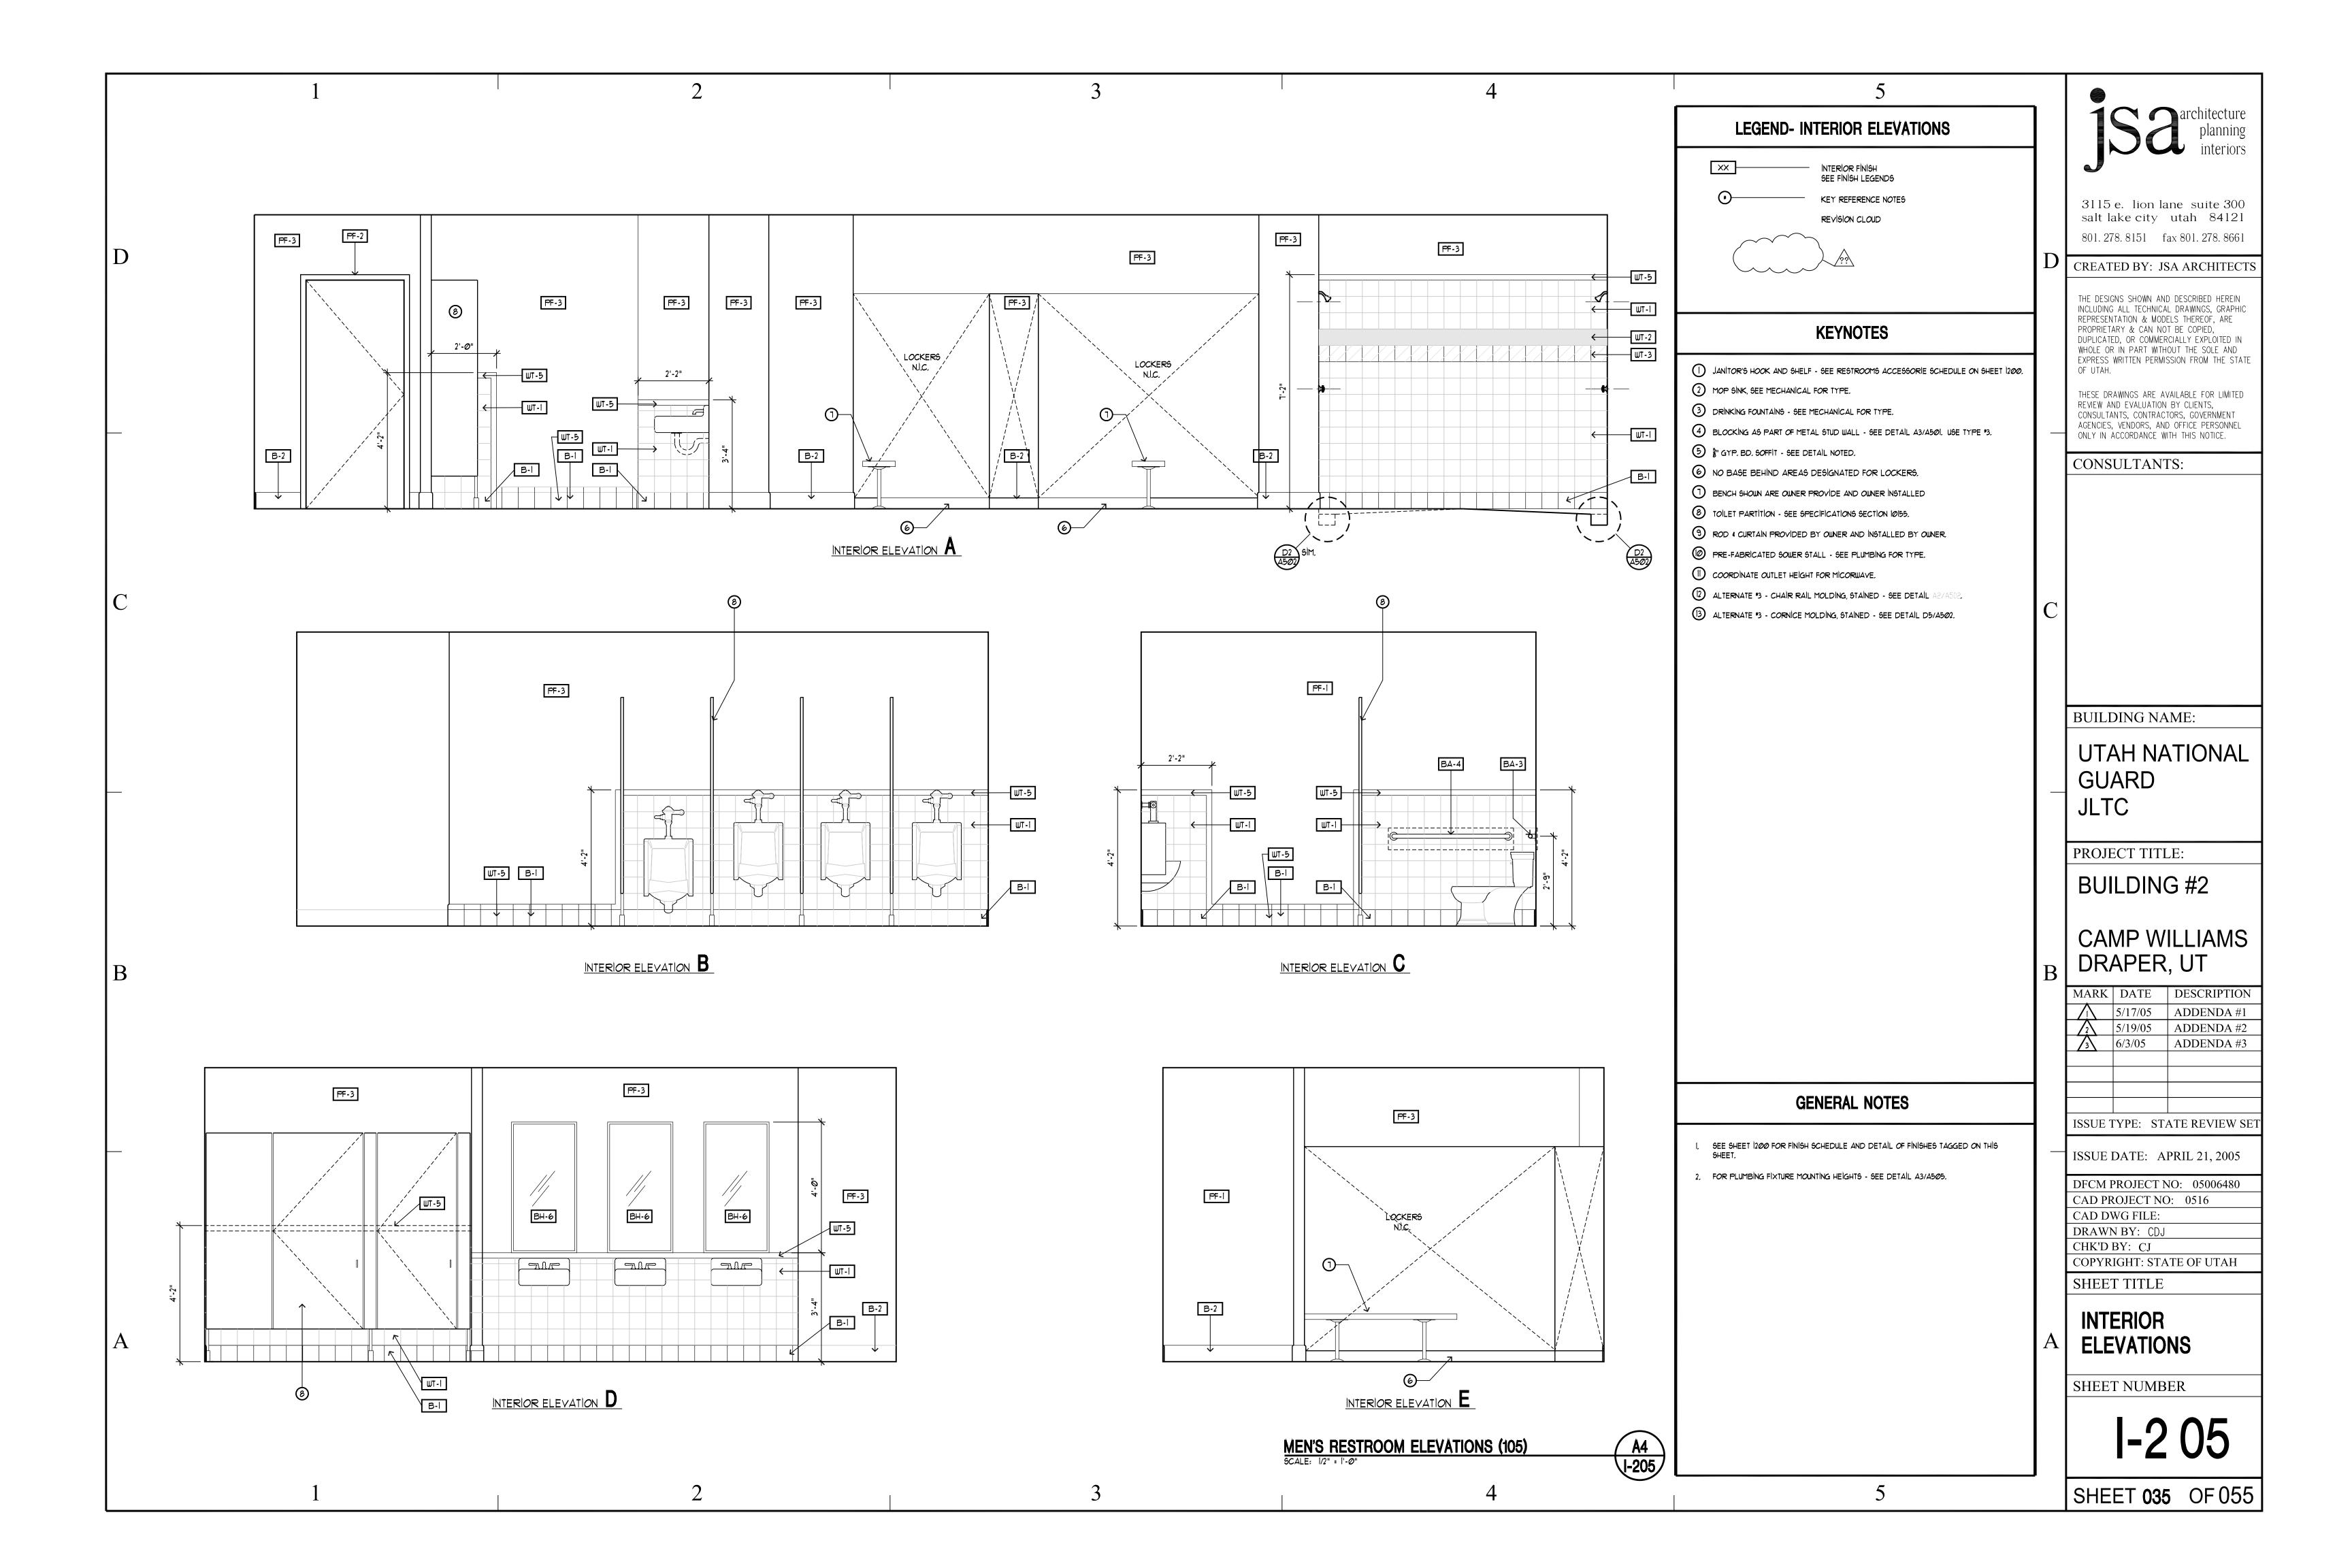


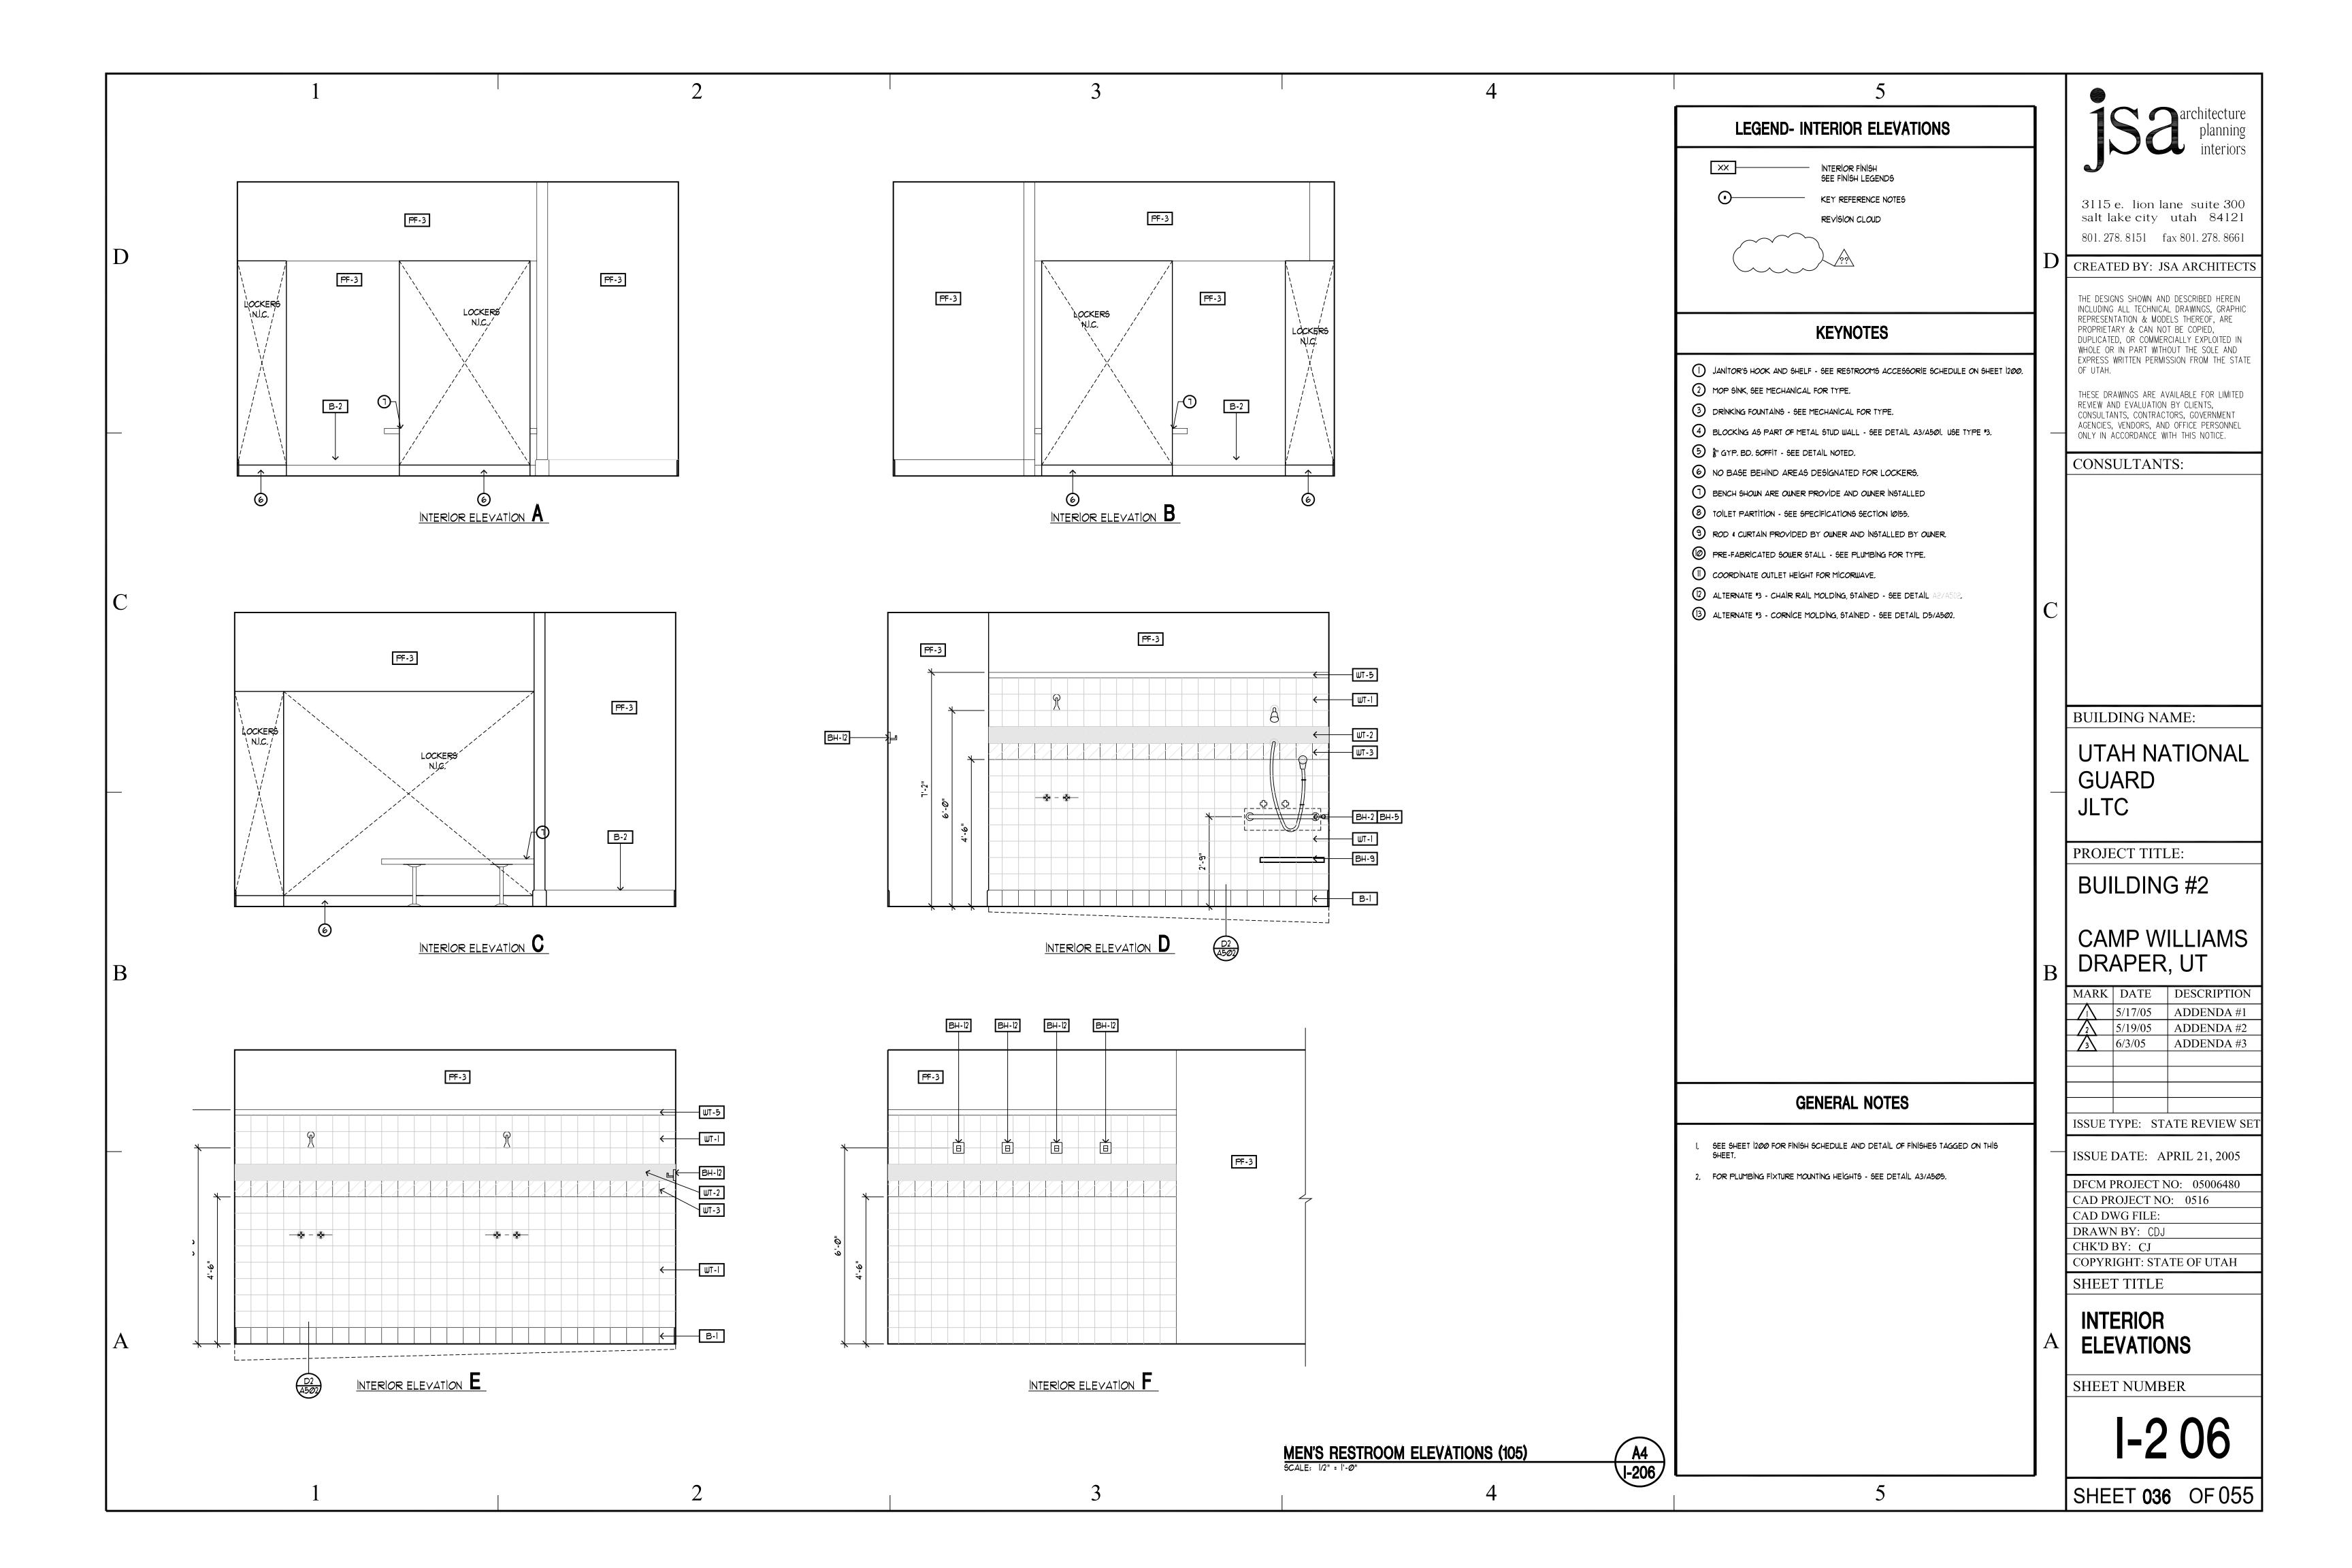


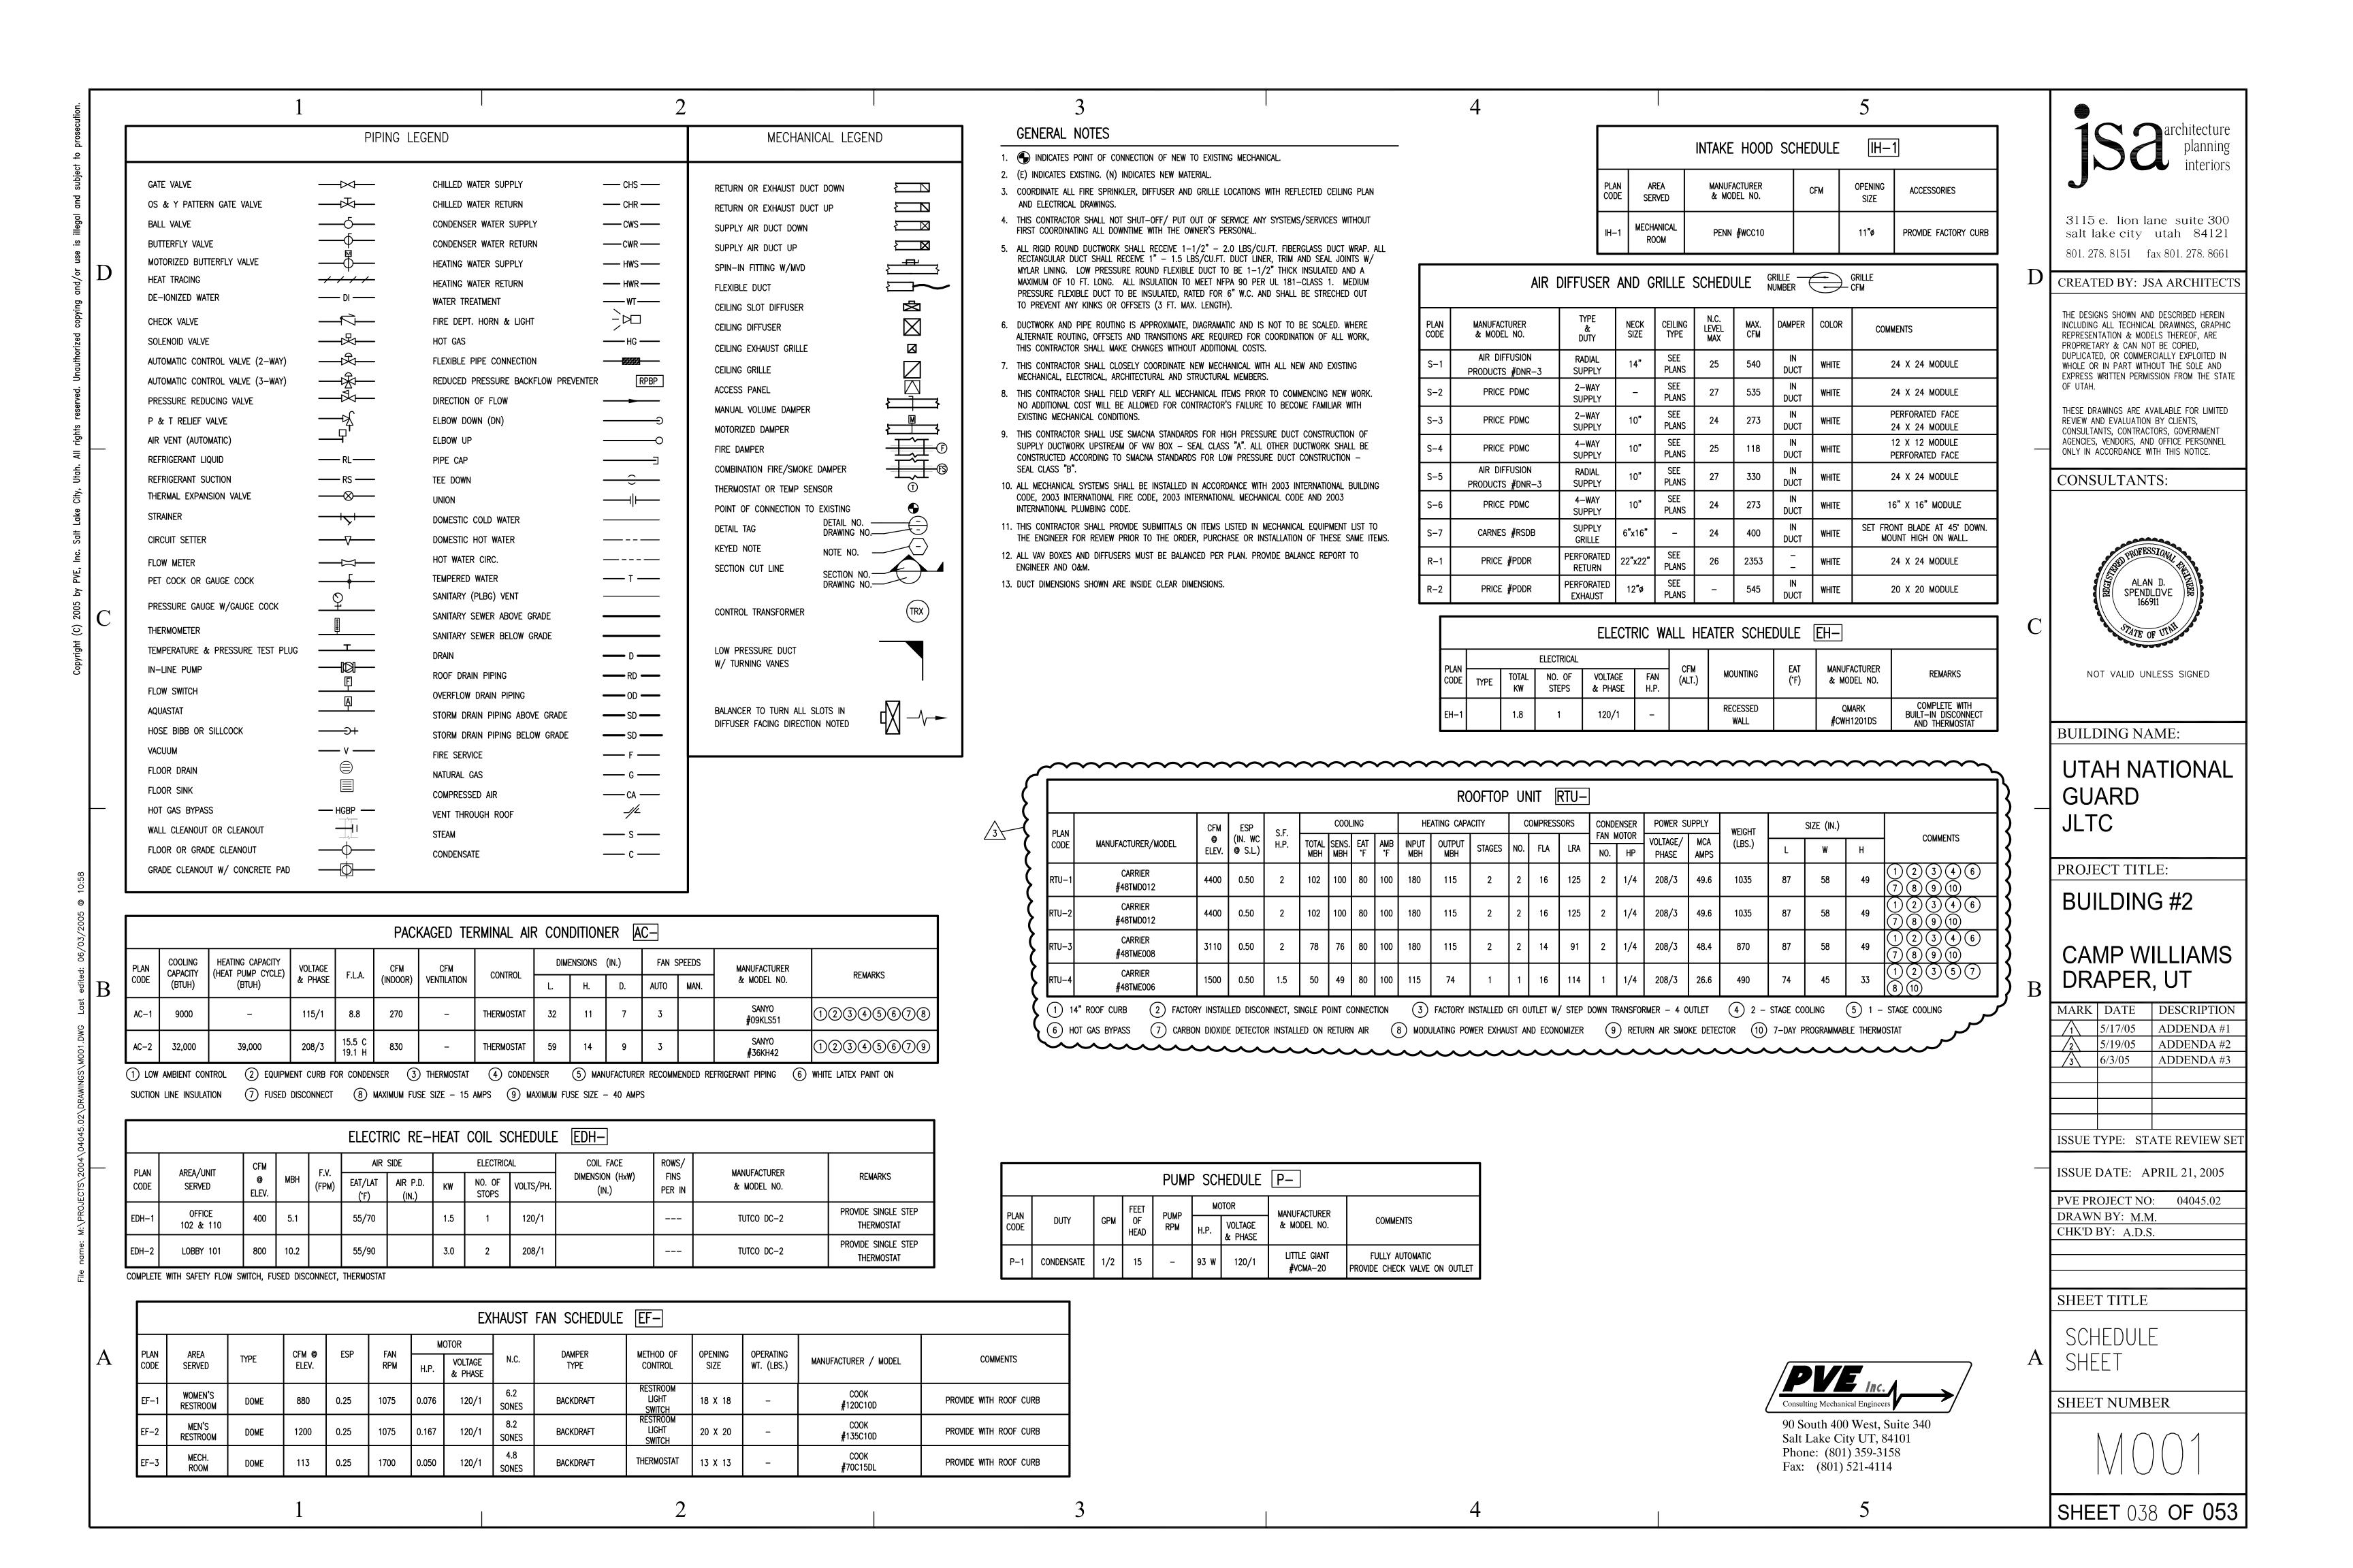


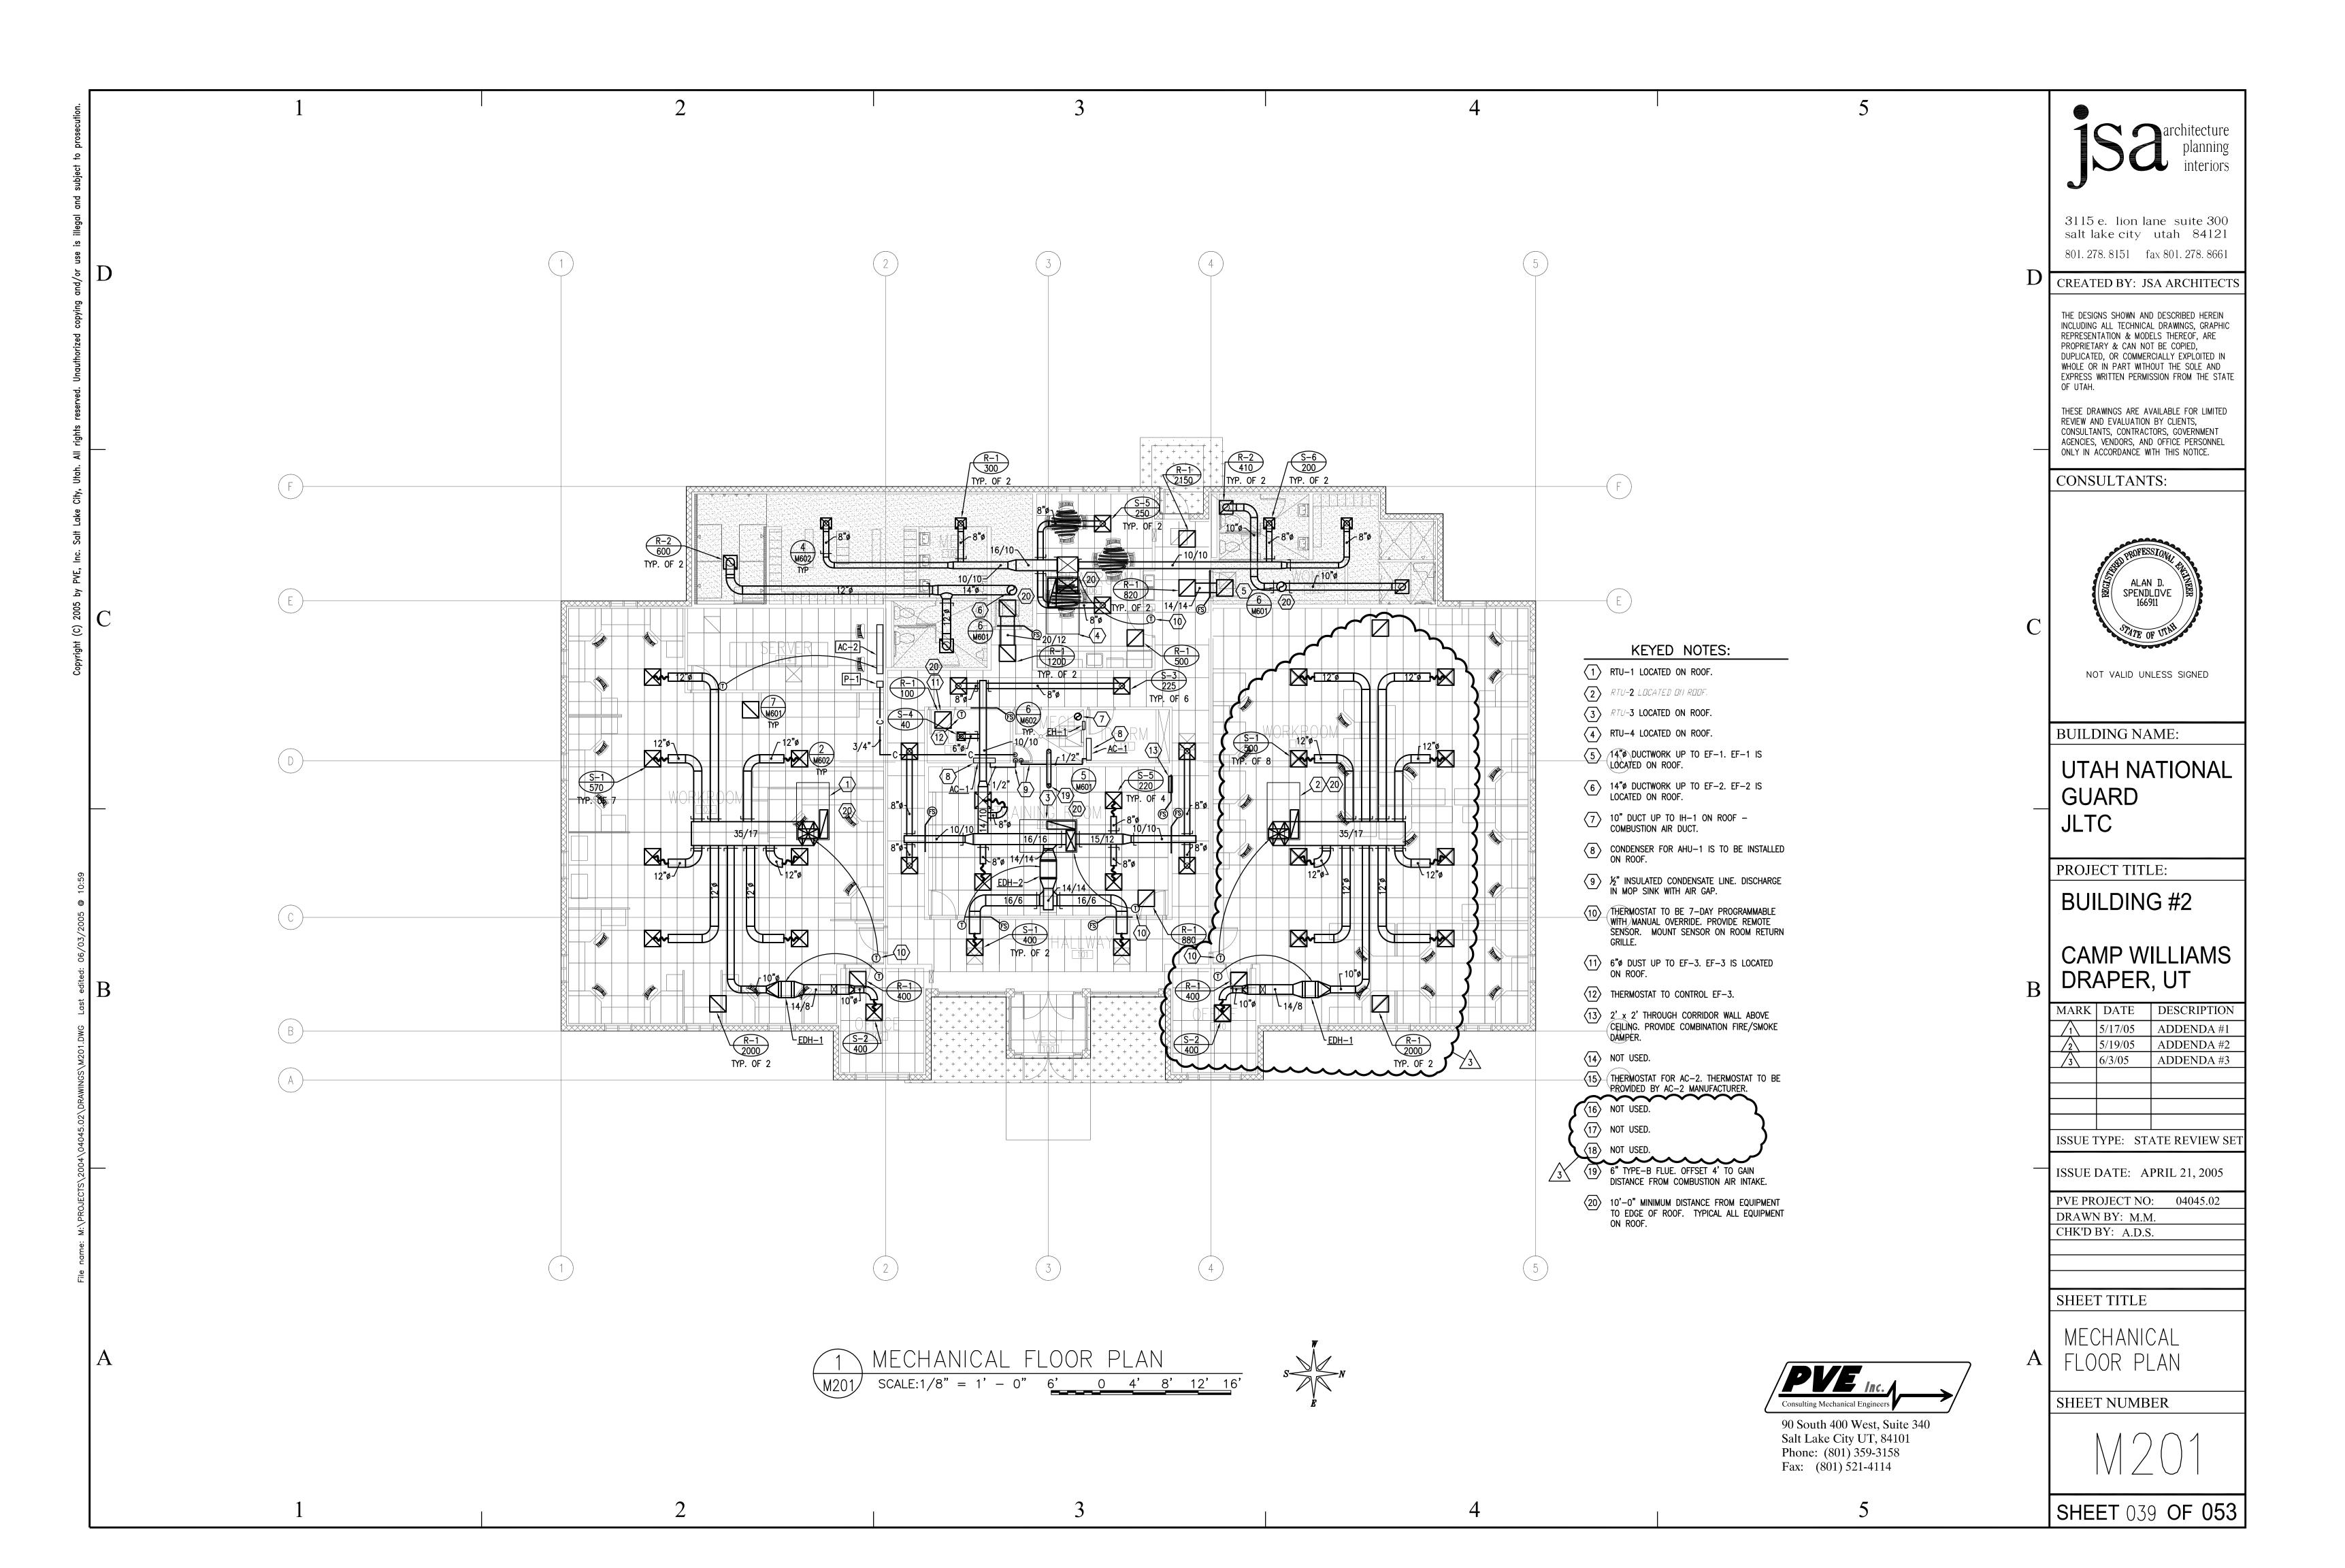


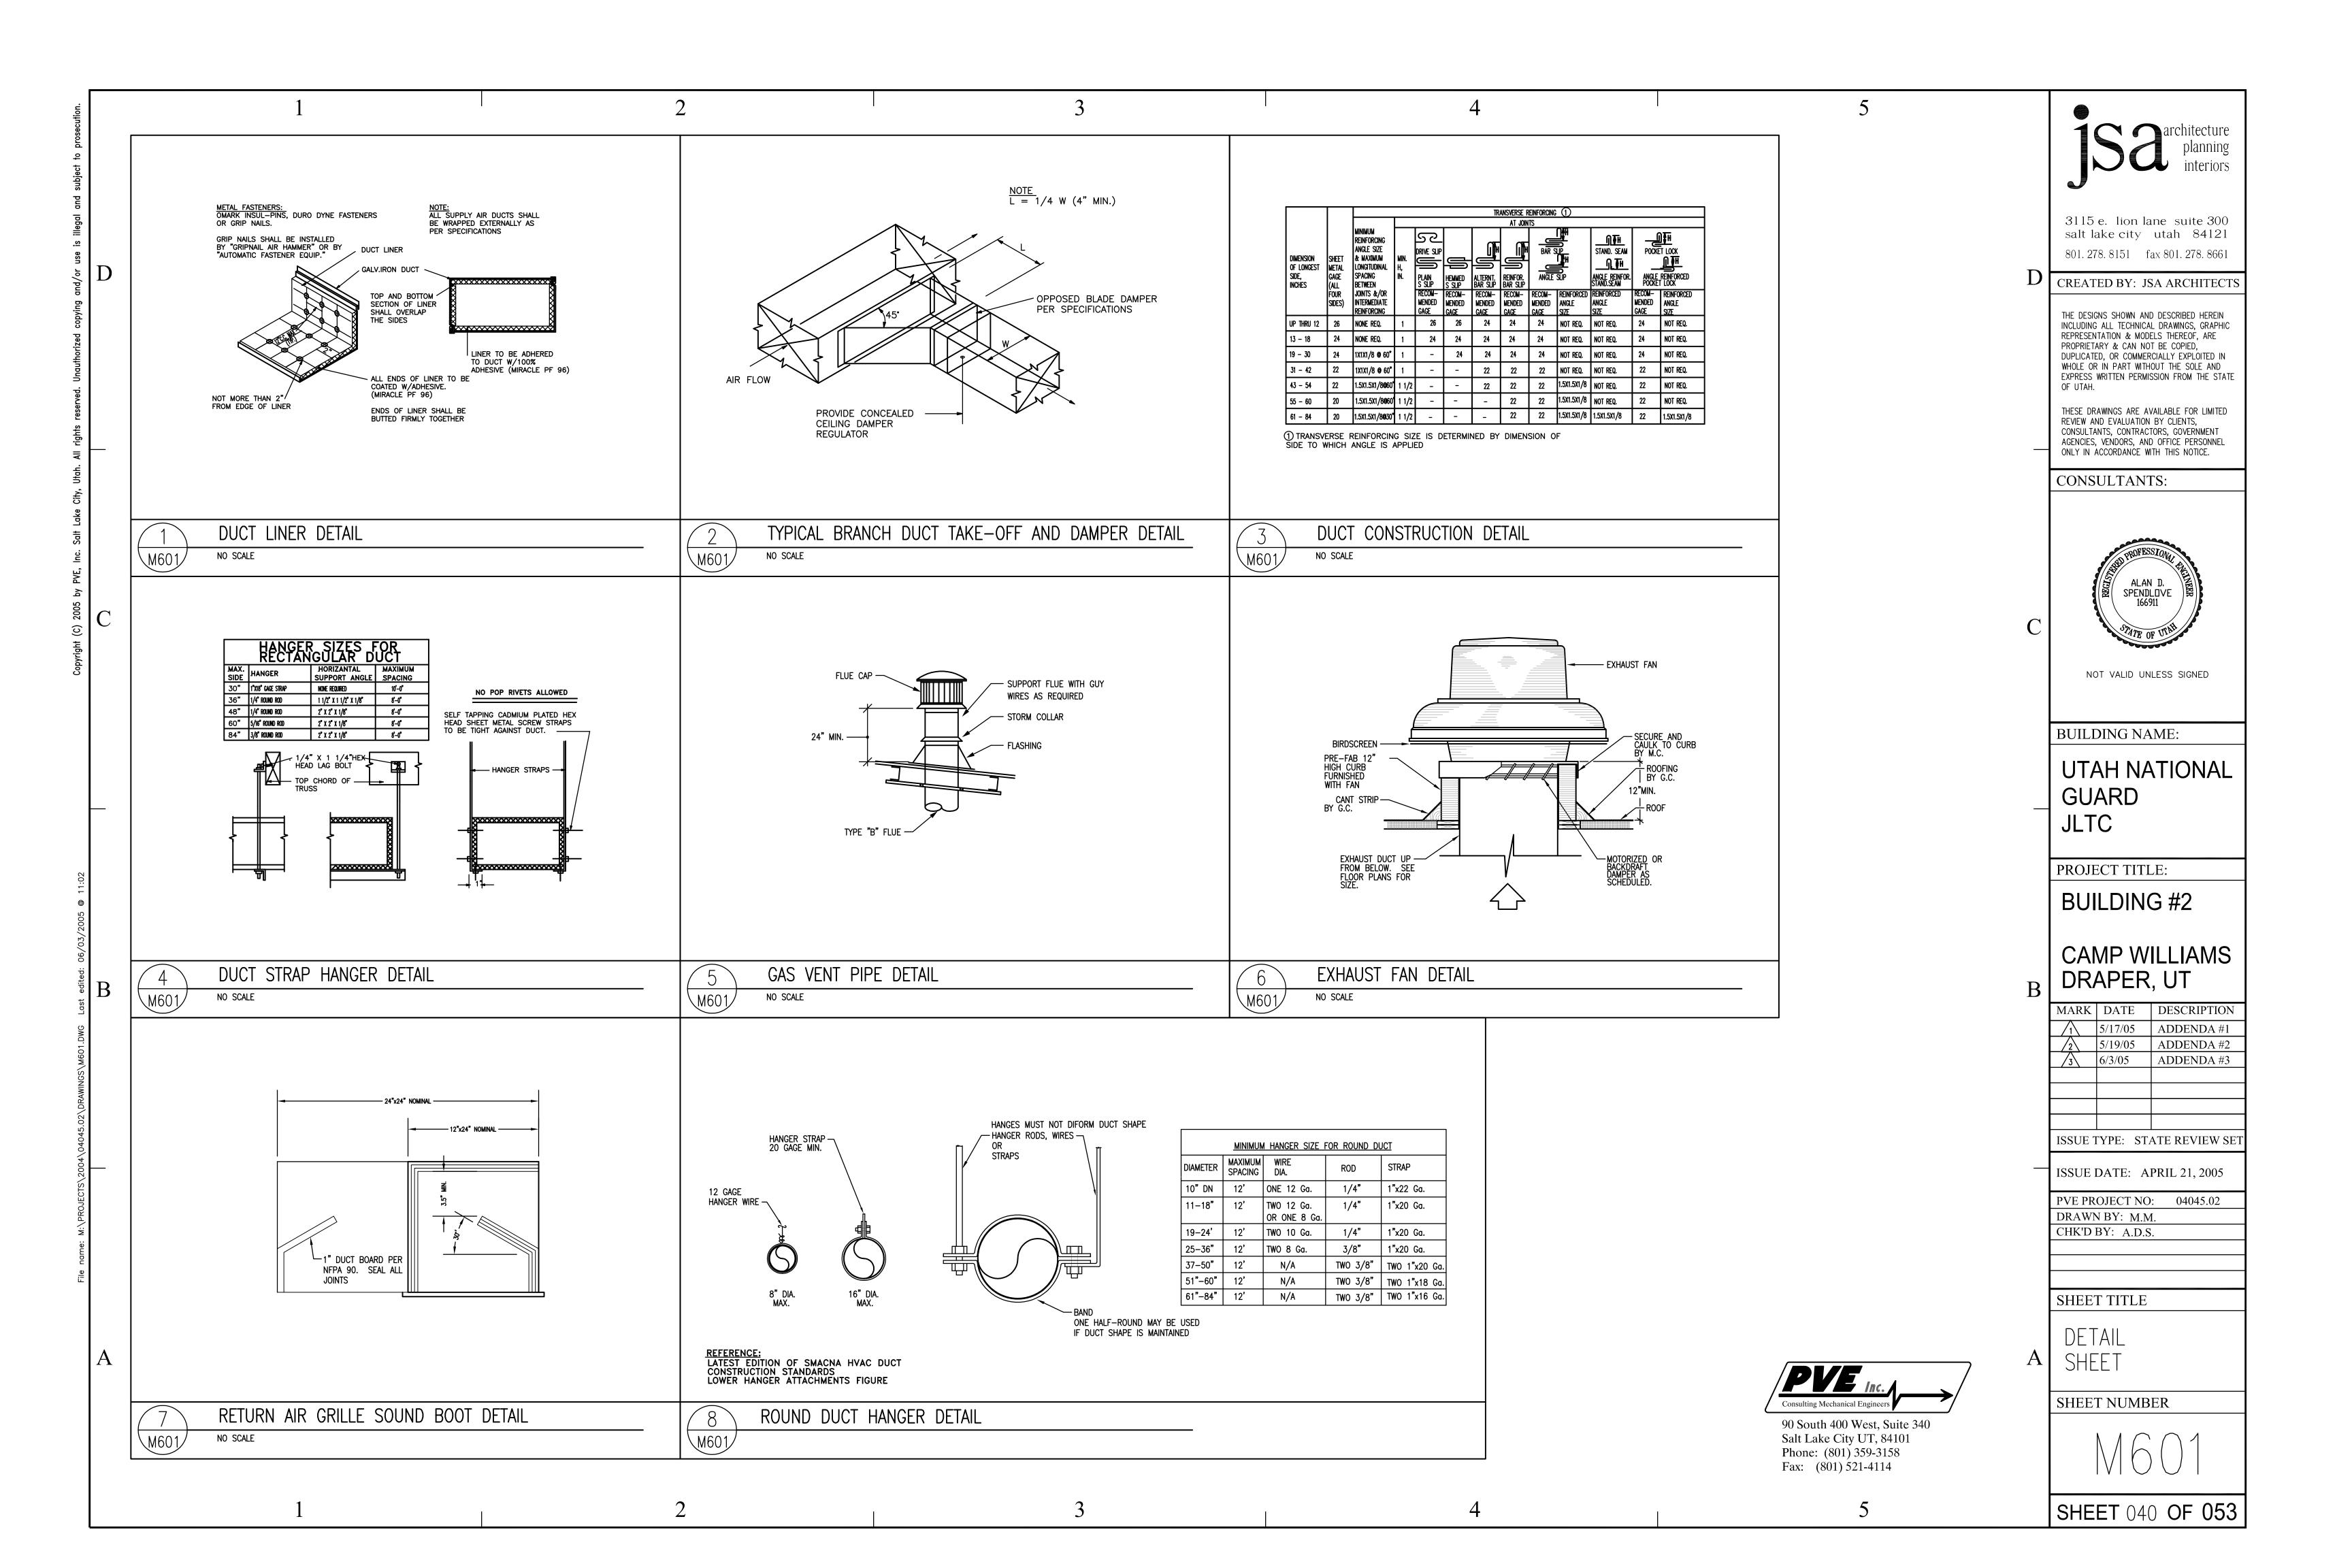


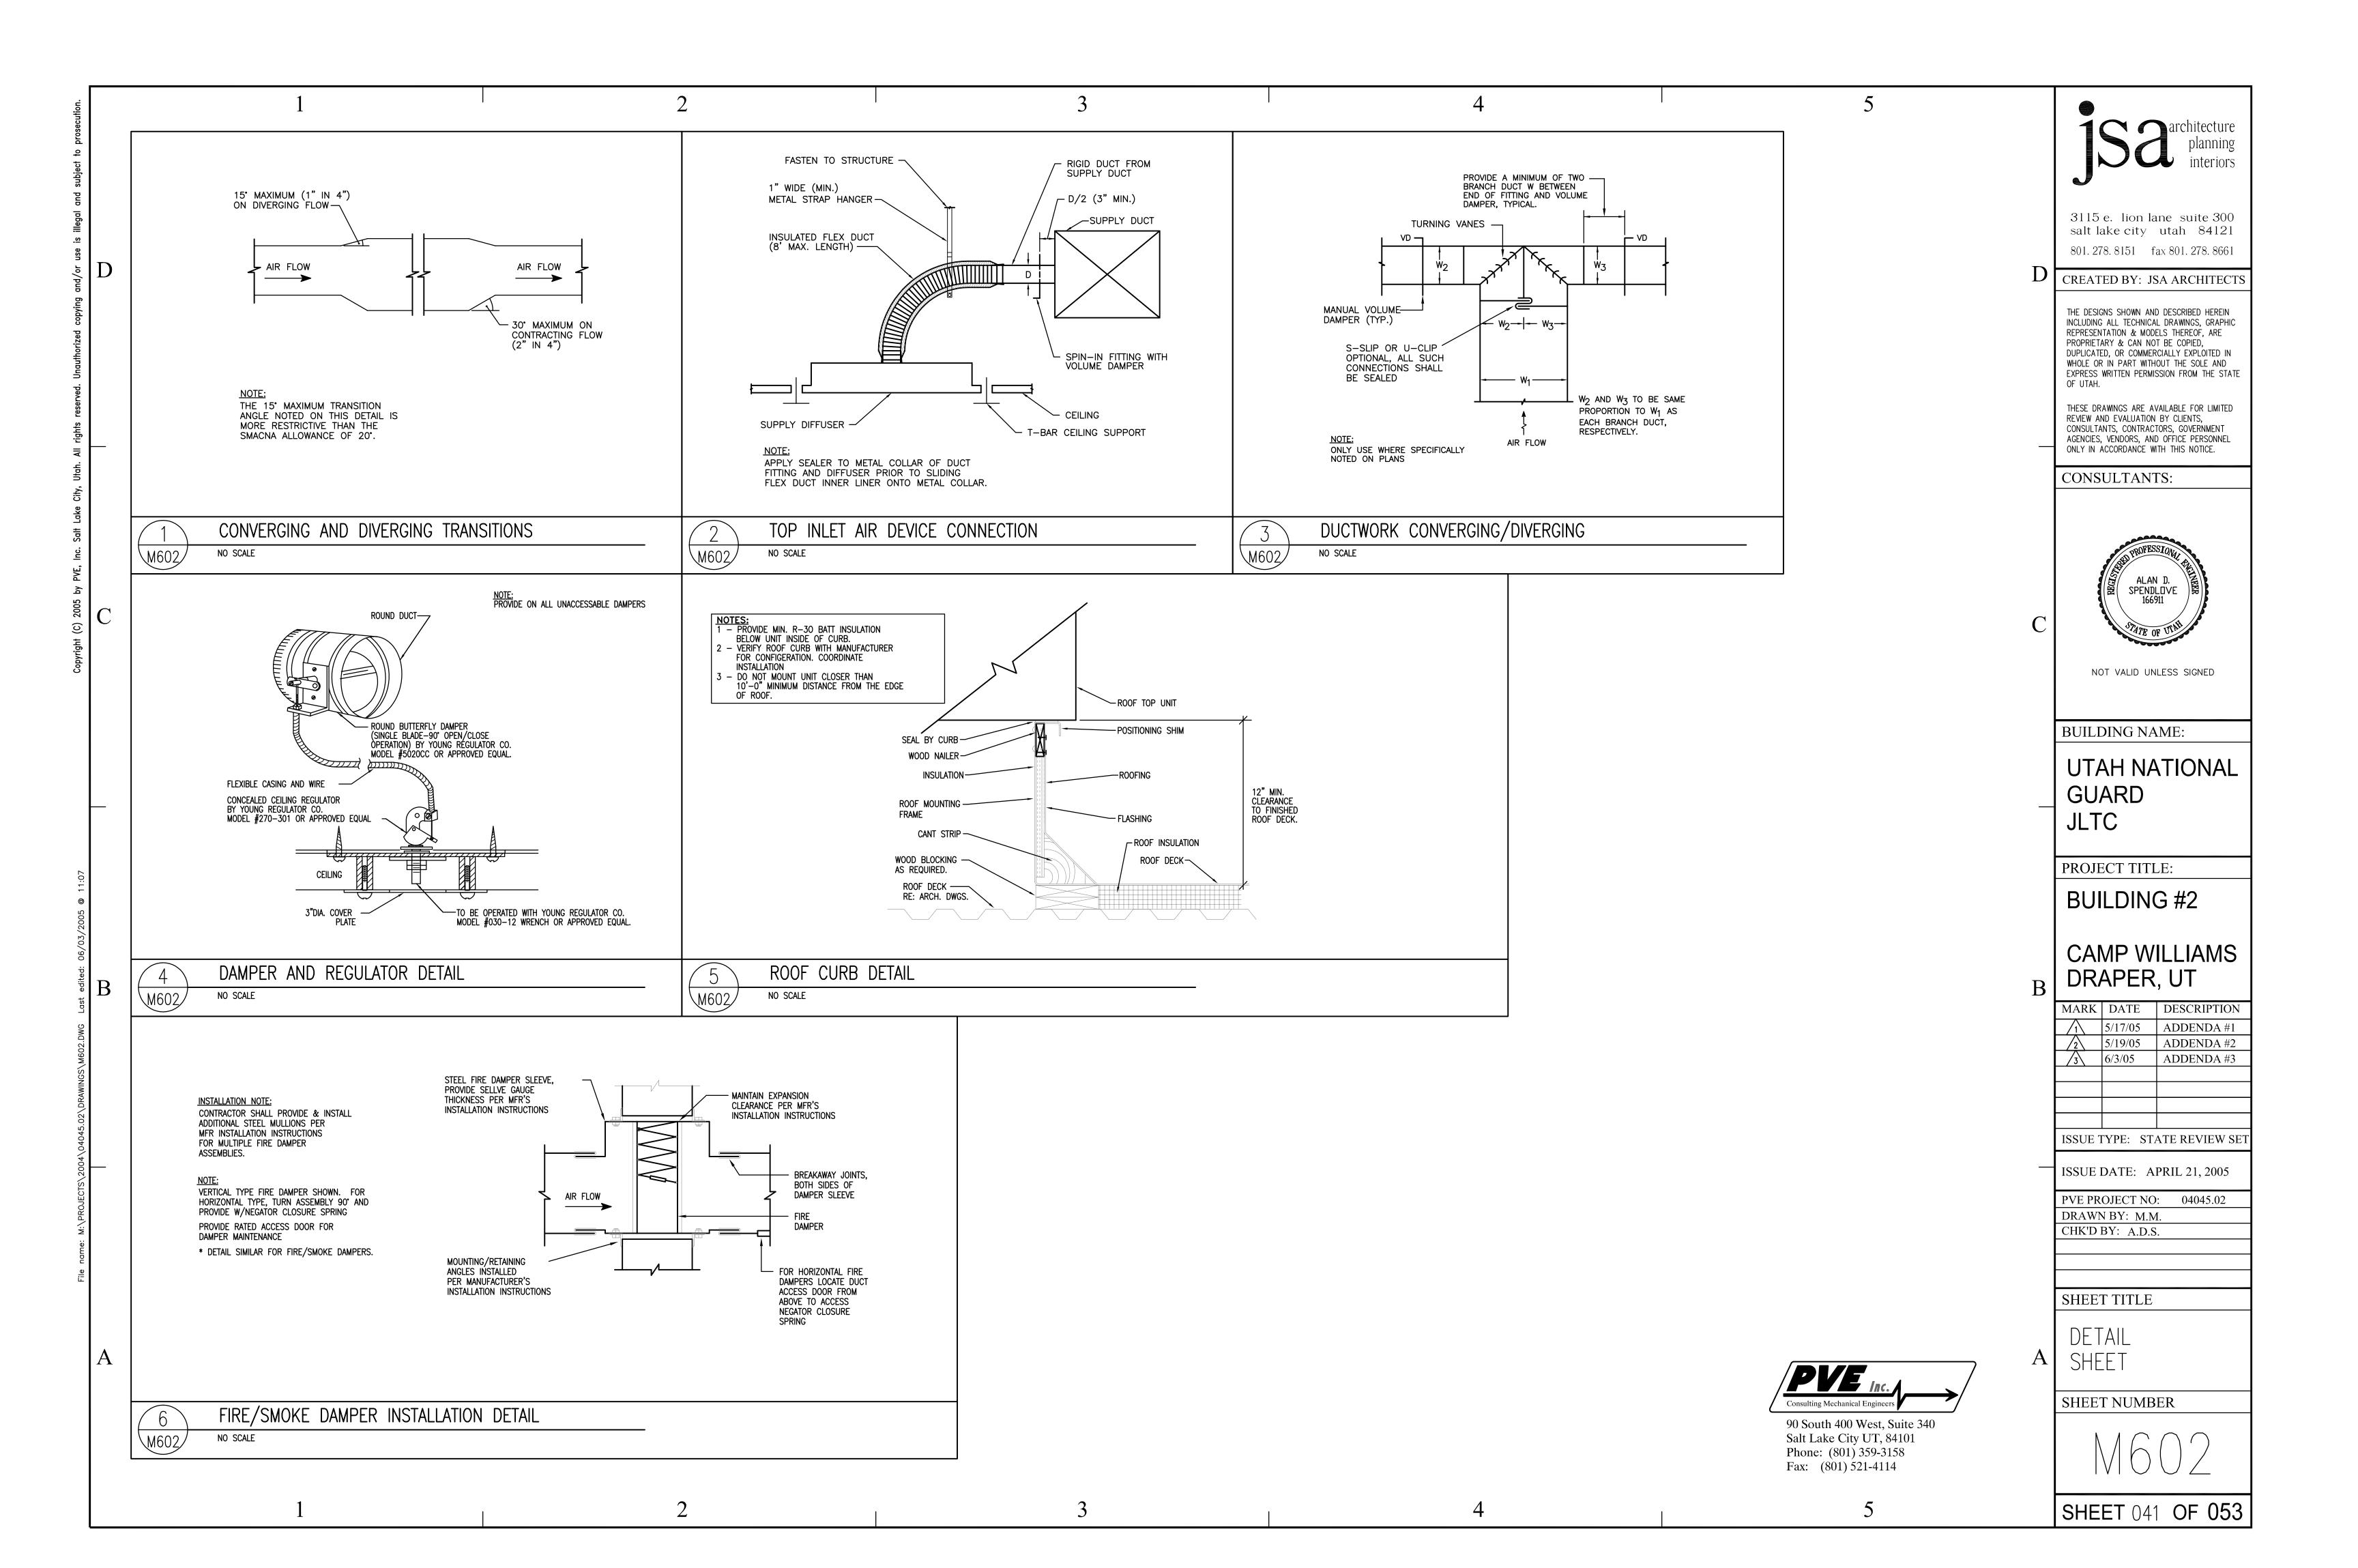

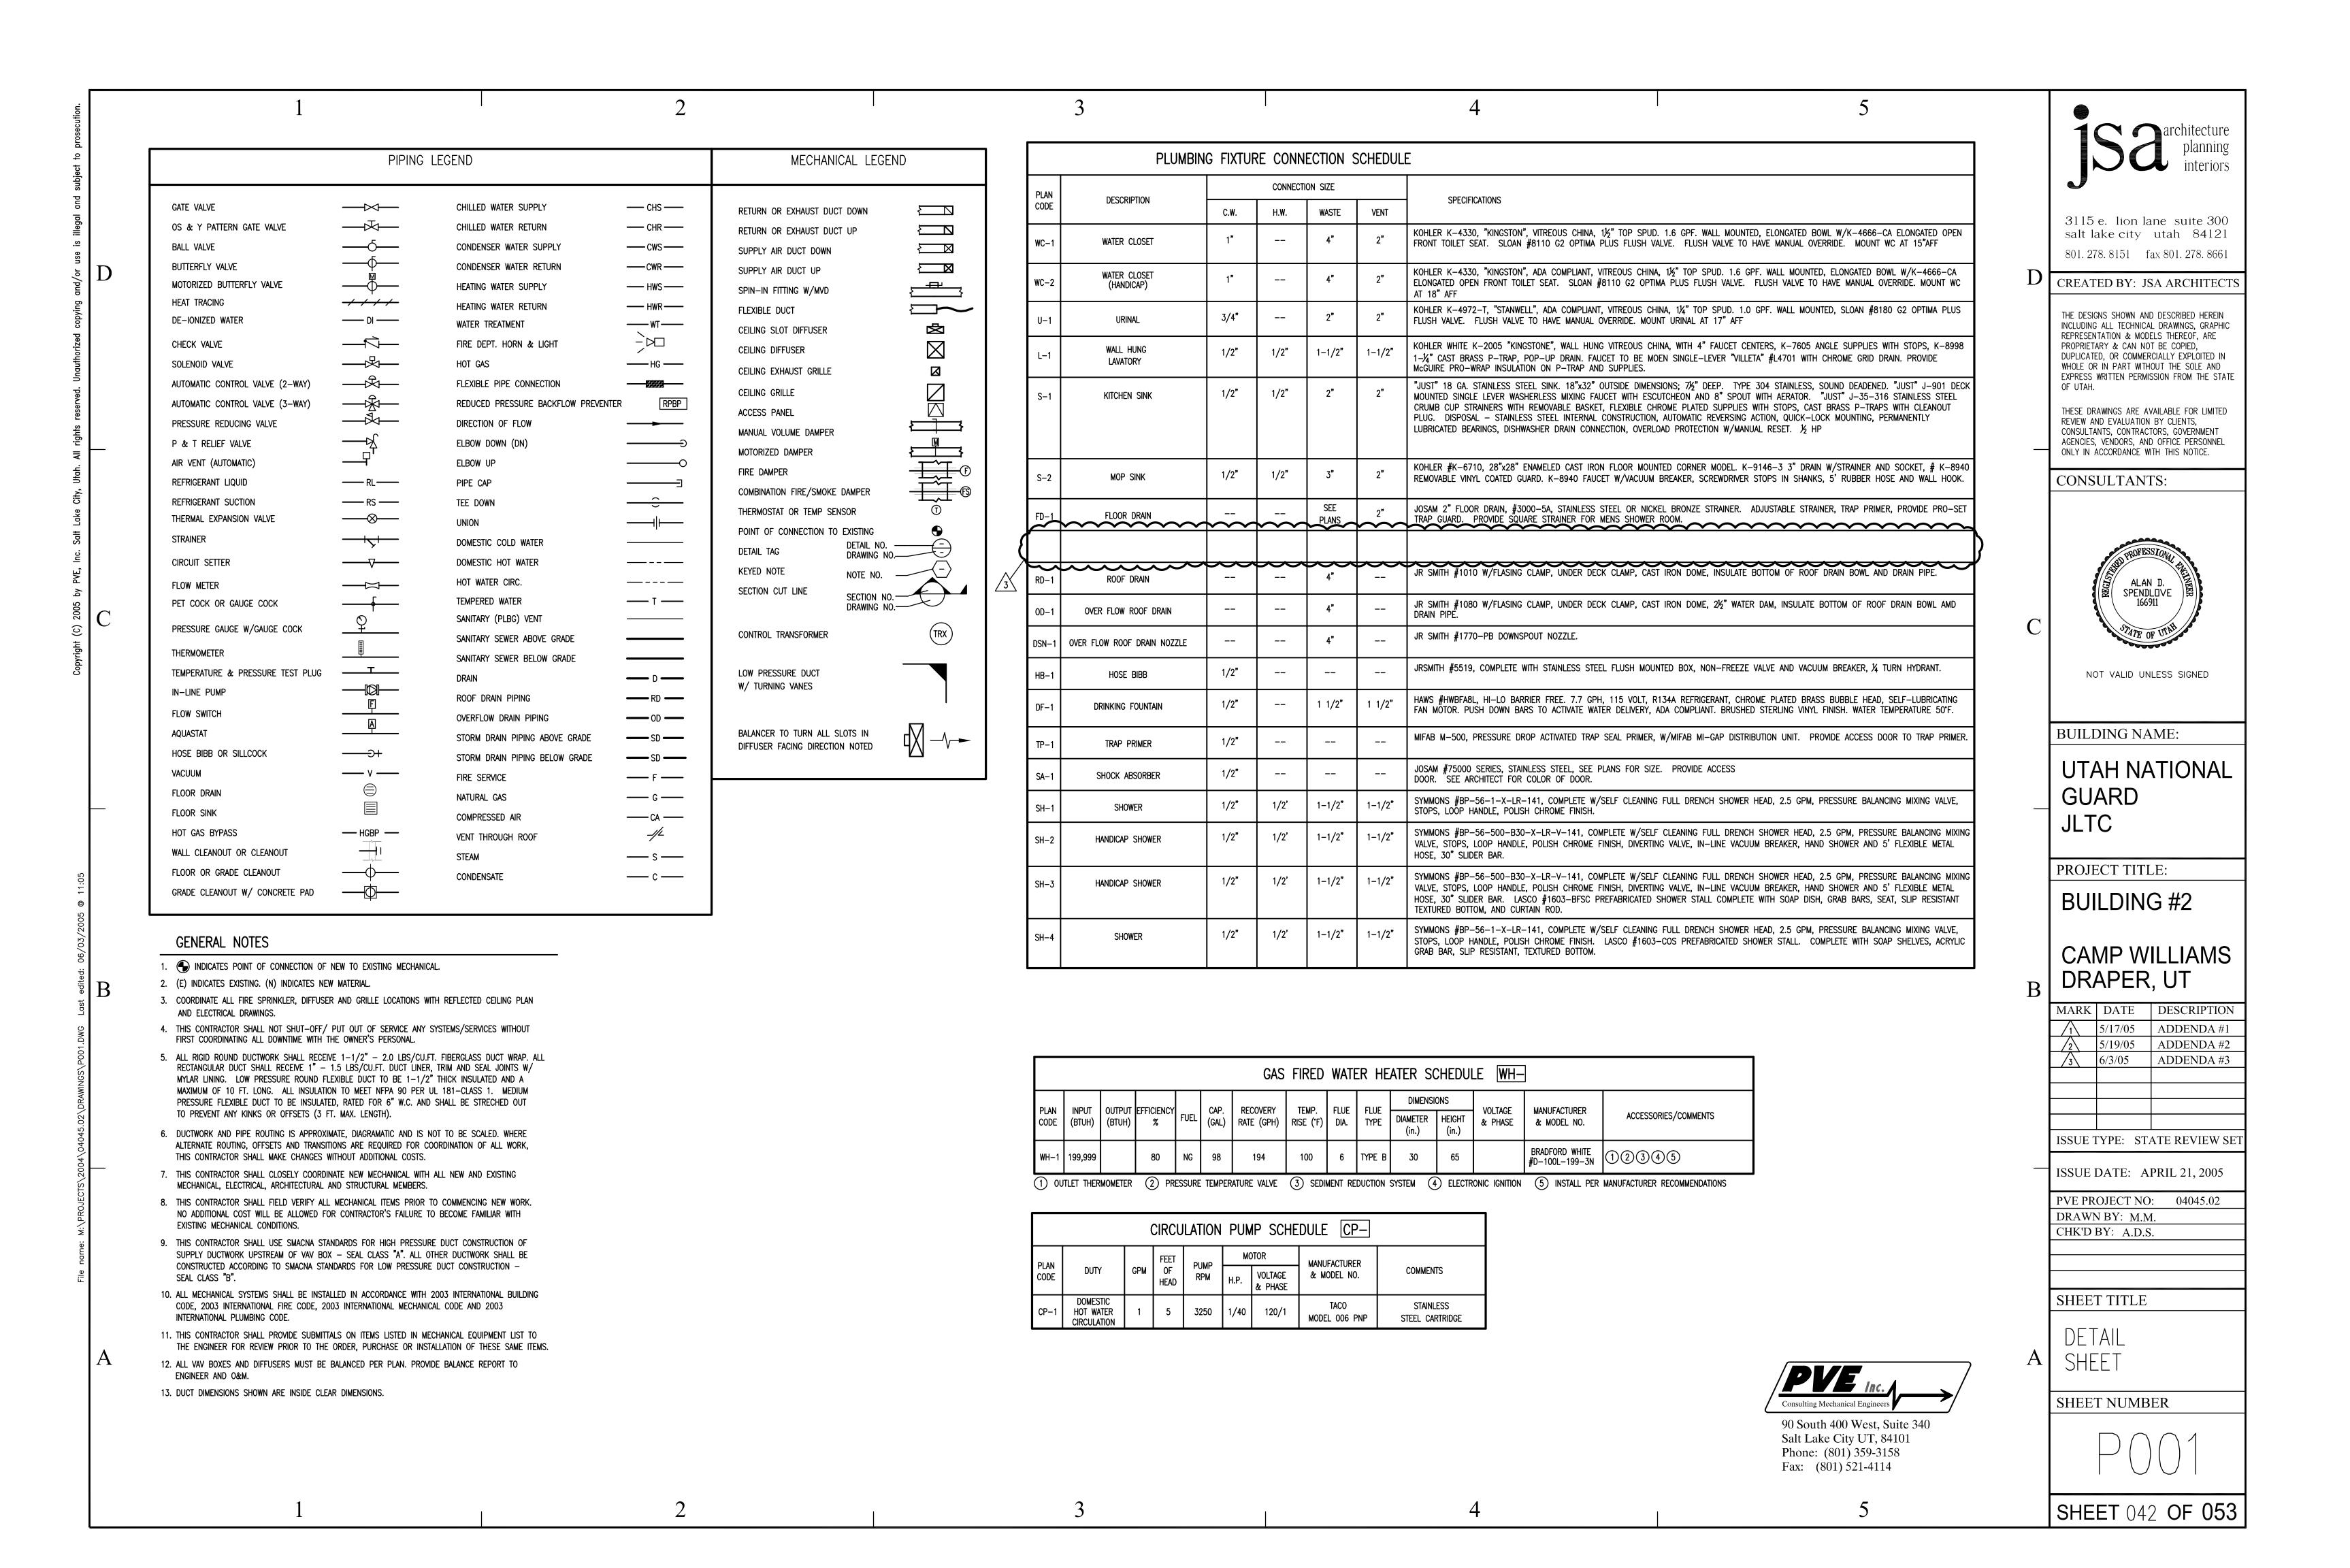

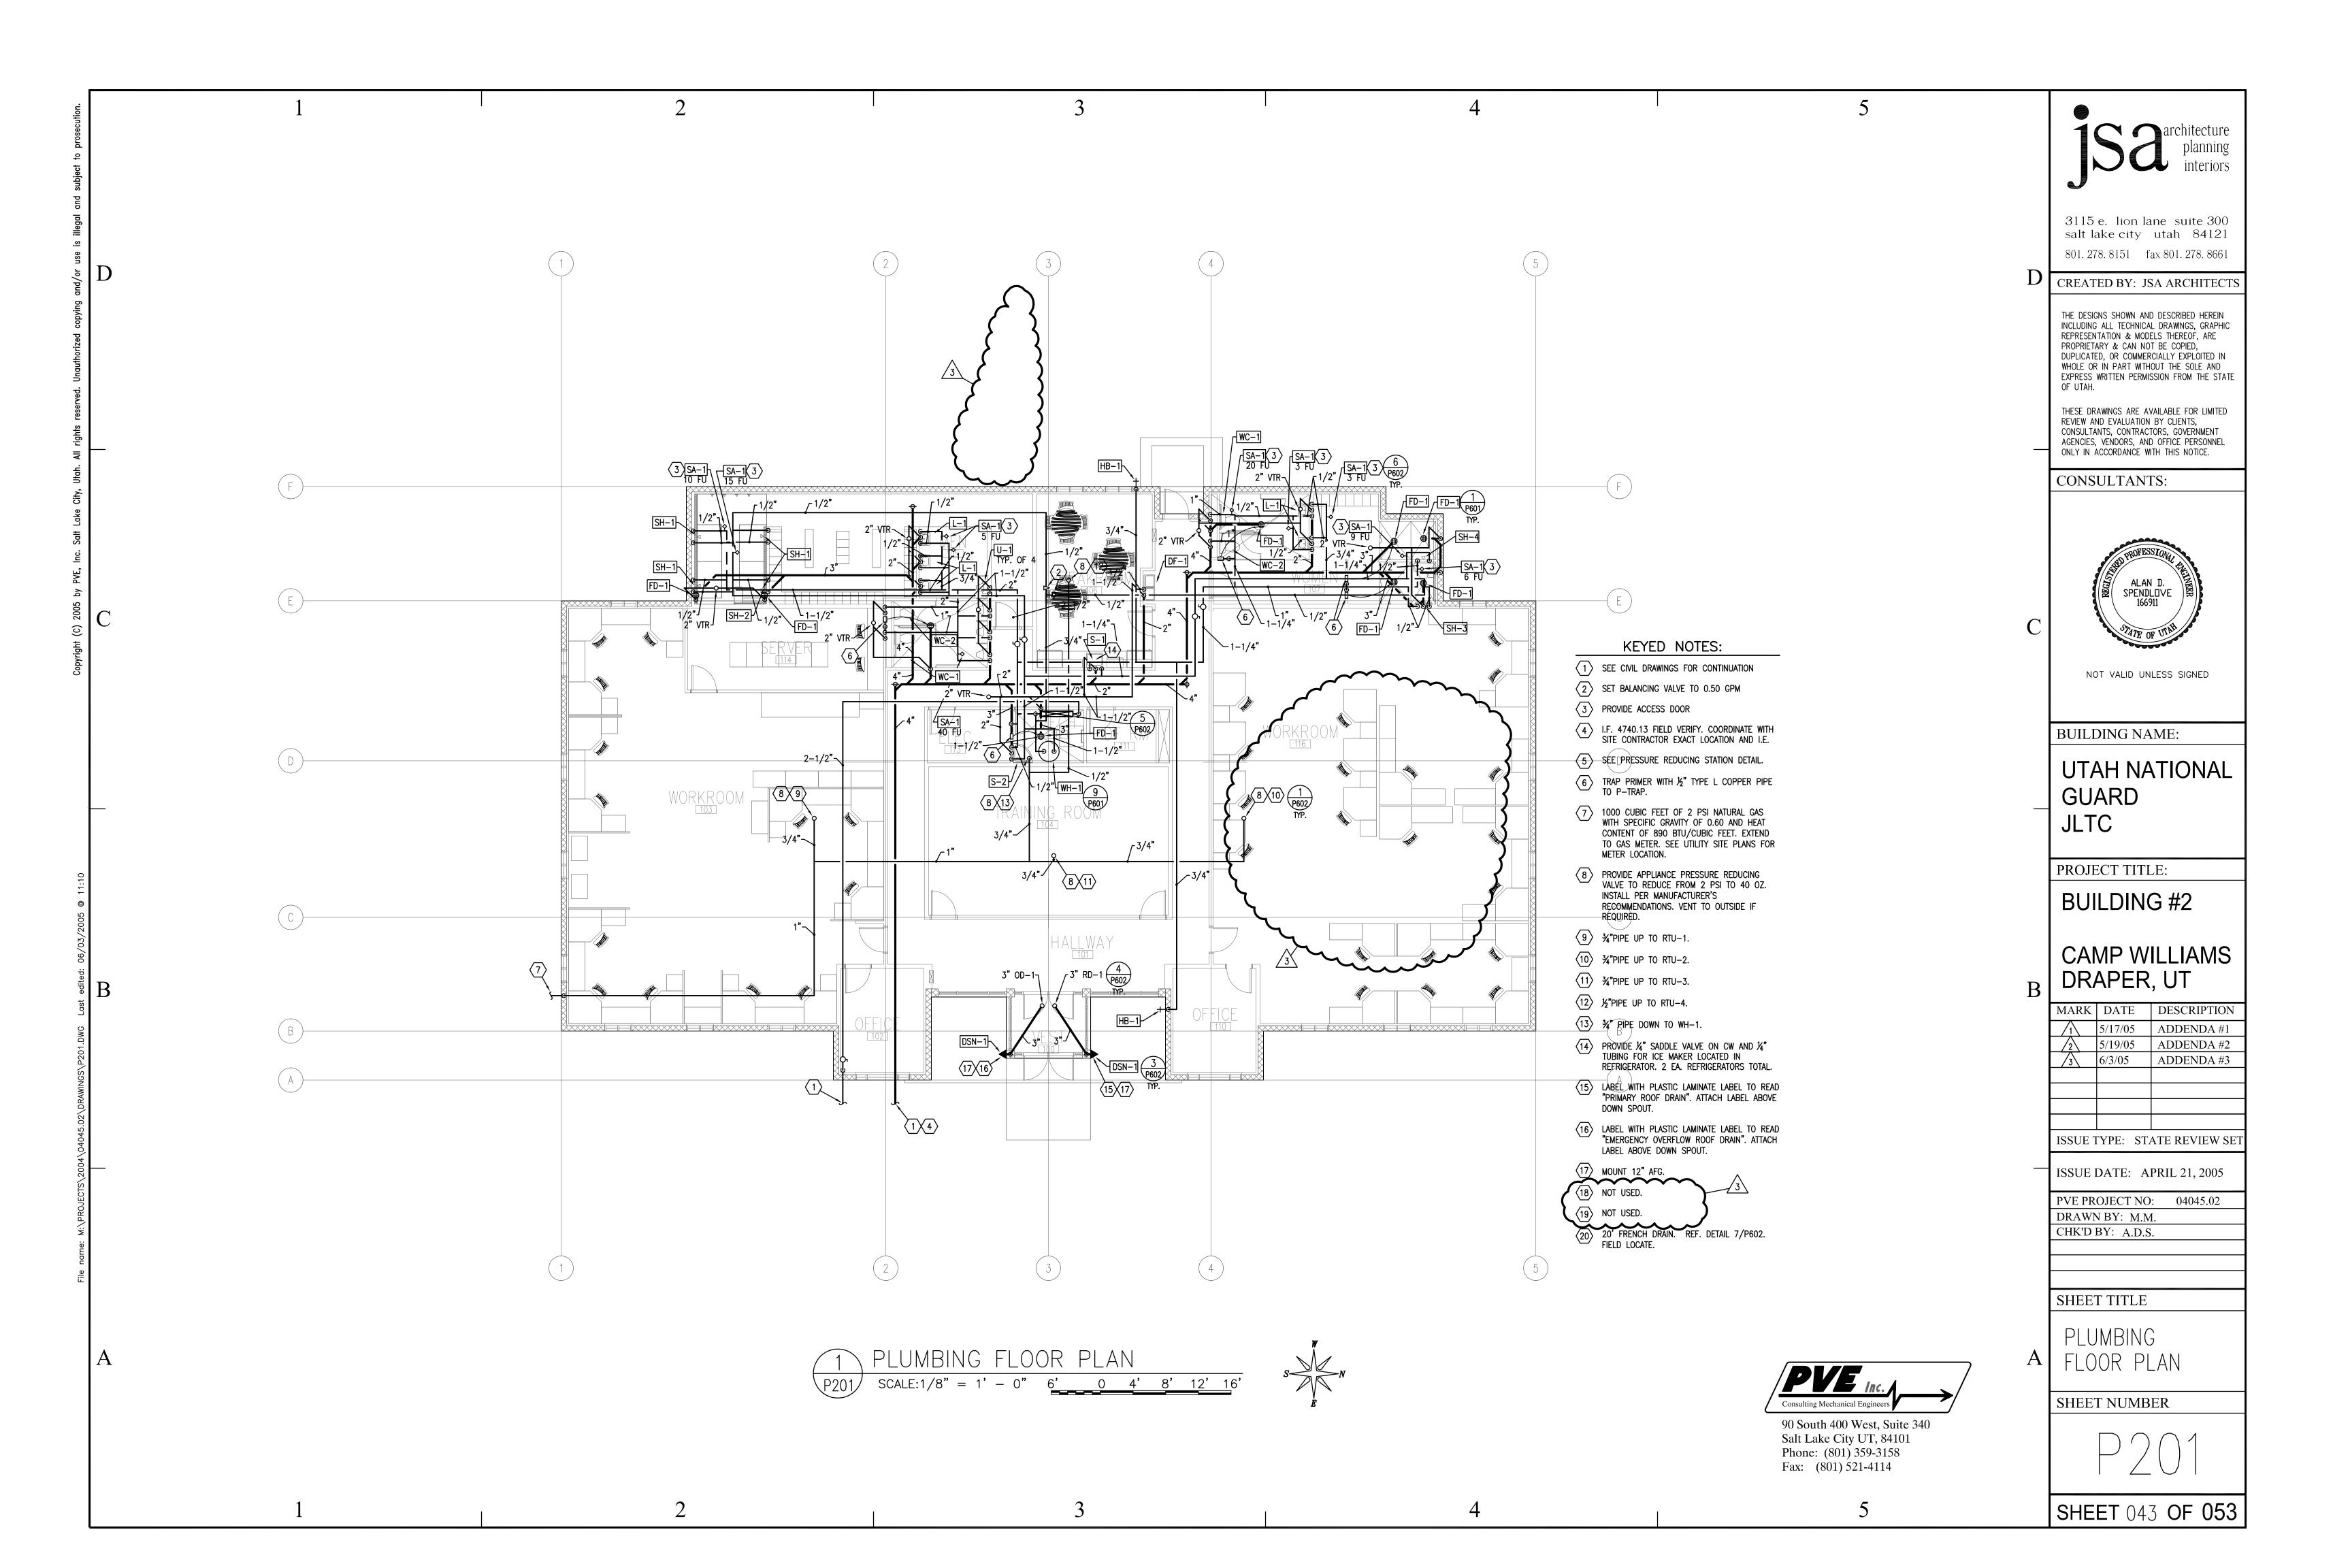

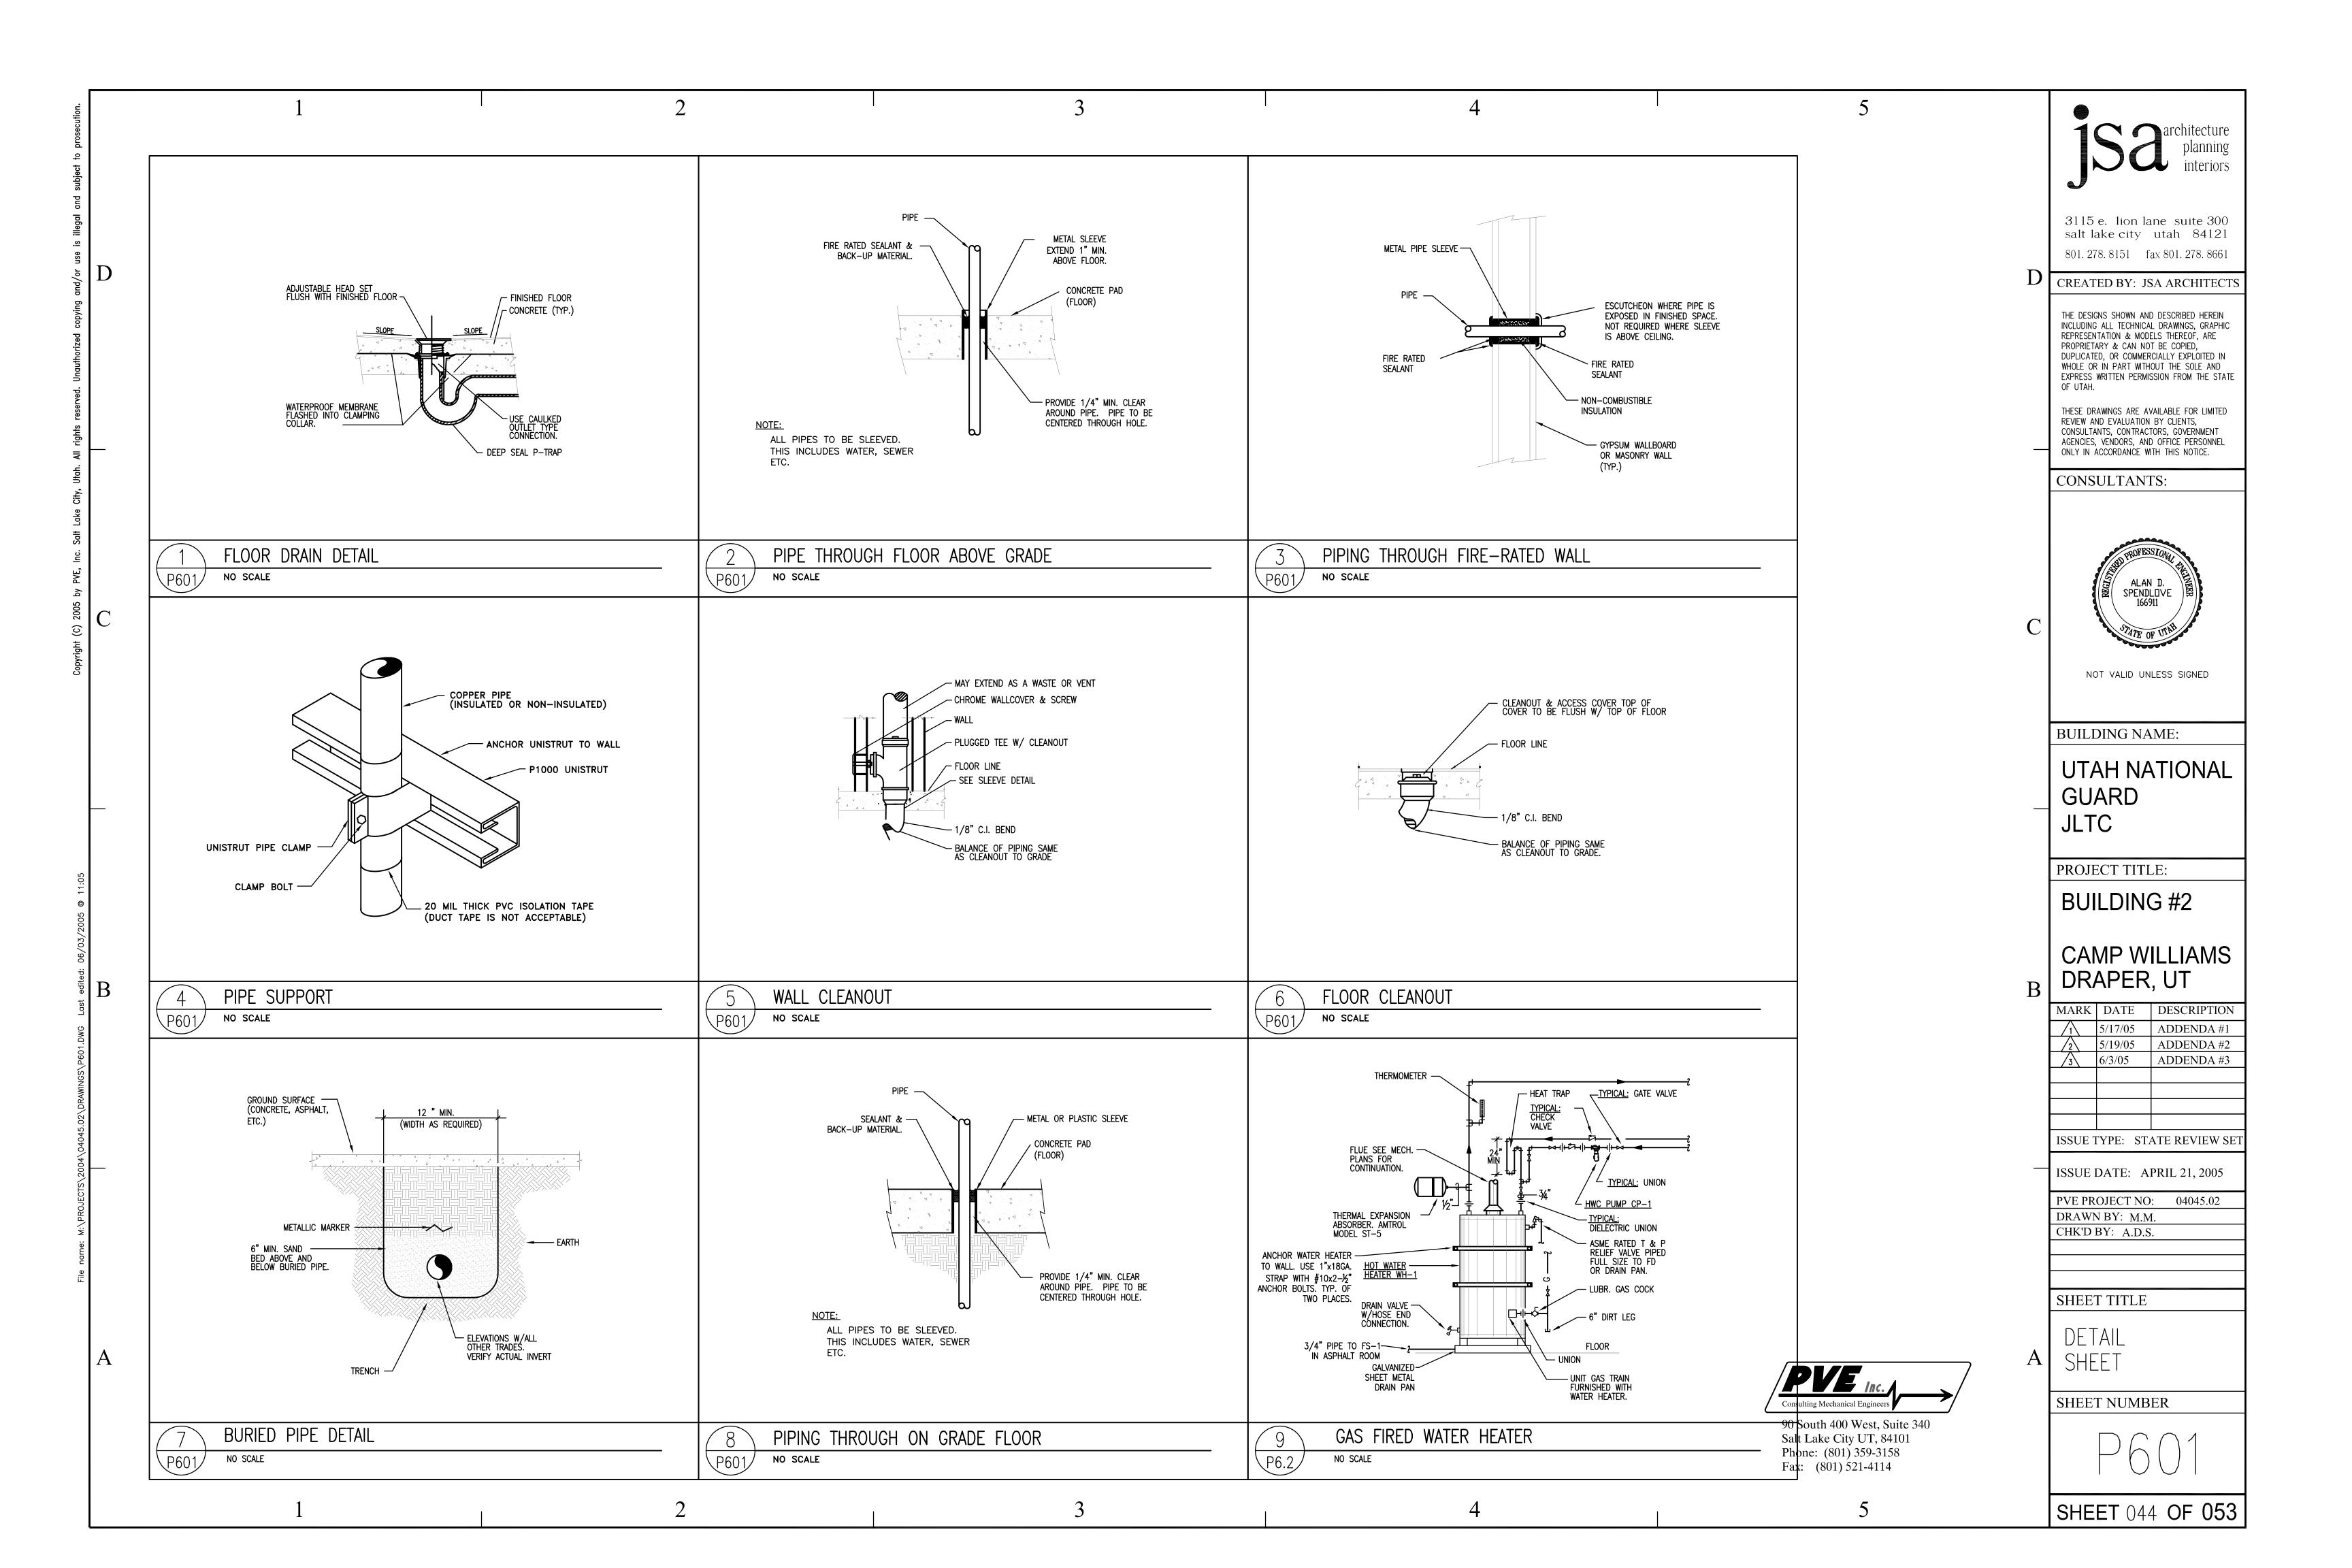

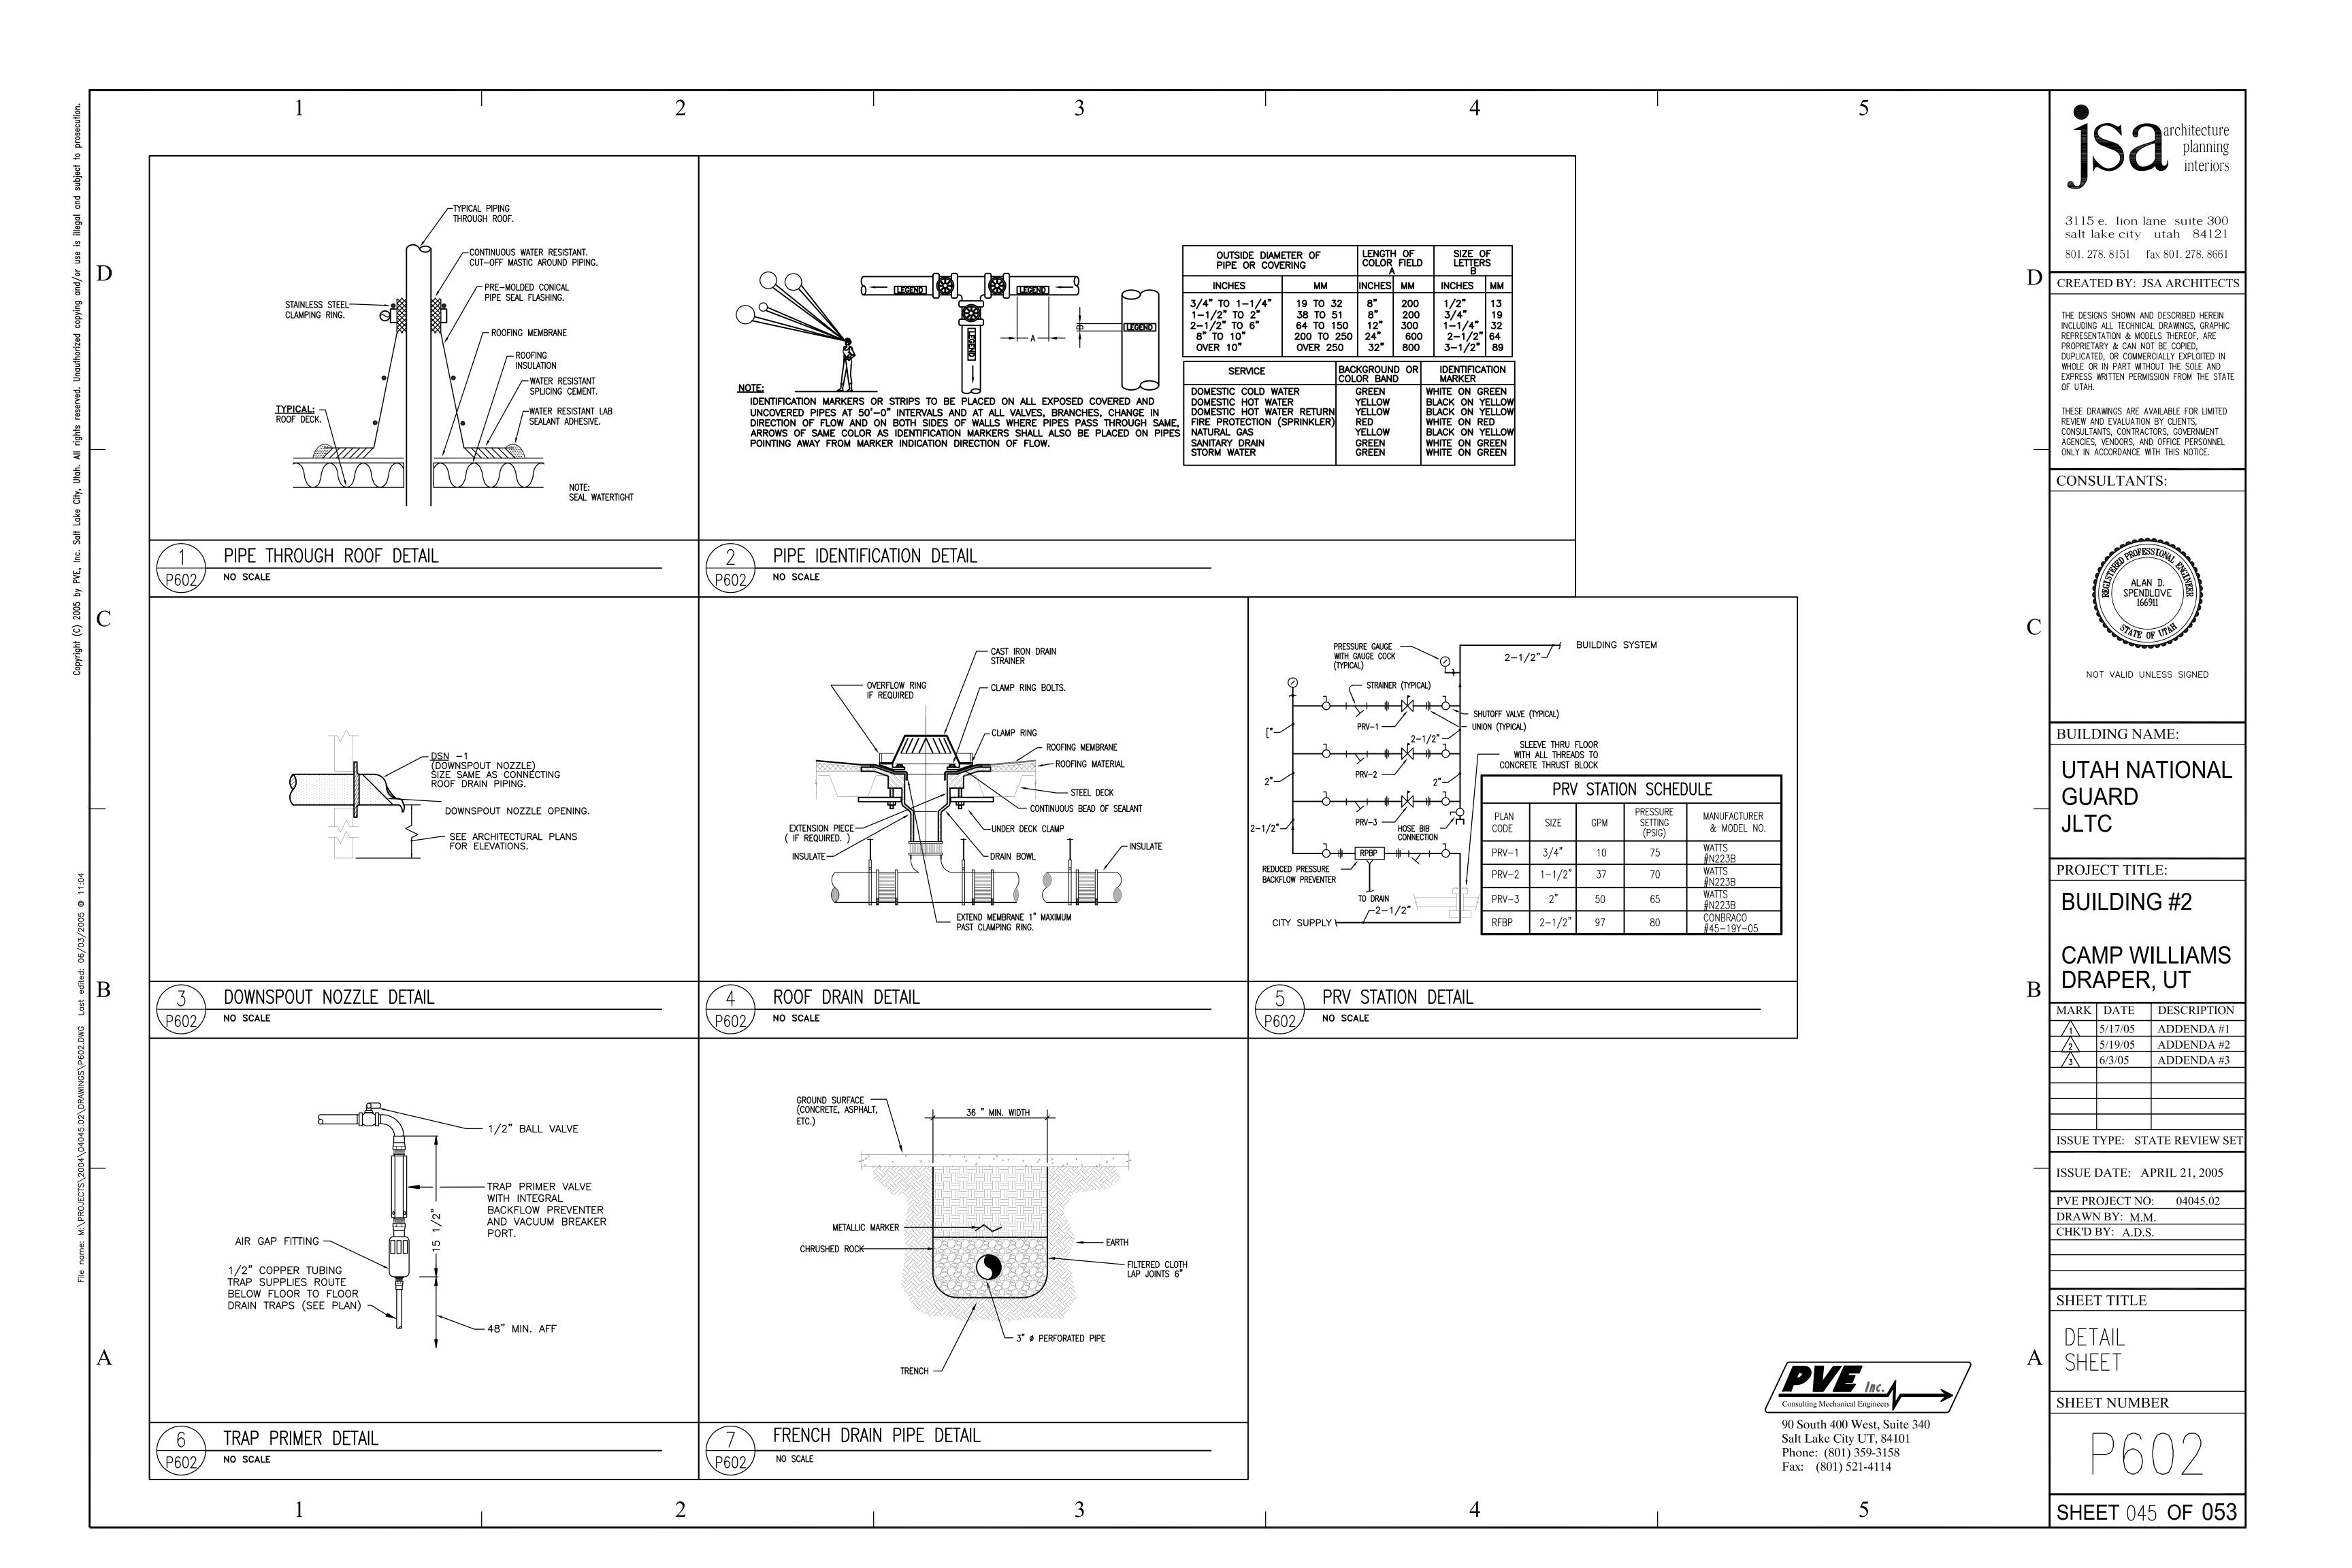

	1	2	I		3	4	5
	LIGHTING SYSTEMS SYMBOL LIST		IICHTING FI	XTURE SCHEDULE		GENERAL NOTES:	
CYMPAI		-		VIONE SCHEDOFE			
SYMBOL	+	SYMBOL DESCRIPTION		AMPS APPROVED MANUFACTURERS	CATALOG NUMBER	(1) REFER TO THE ARCHITECTURAL REFLECTED CEILING PLANS FOR THE EXACT LOCATION OF ALL LIGHTING FIXTURES.	(38) ELECTRICAL CONTRACTOR SHALL VERIFY ALL ELECTRICAL LOADS (VOLTAGE, PHASE, CONNECTION REQUIREMENT, ETC.) OF EQUIPMENT FURNISHED UNDER
	LIGHTING SYMBOLS	LENS, 18 CELL, SEMI-SPECUL	T FIXTURE, 3 LAMP, PARABOLIC  _AR FINISH, UNIVERSAL  (3)	COLUMBIA 3) 32W	P4D24-332G-MA36-EB8LHUNV		OTHER DIVISIONS WITH APPROVED SHOP DRAWINGS. REFER TO BEGINNING ROUGH-IN.
	J RECESSED FLUORESCENT FIXTURE	VOLTAGE BALLAST.		T8 METALUX	(2EP3GX SERIES EQUAL)		
	SURFACE MOUNTED FLUORESCENT FIXTURE	SAME AS T-1, BUT ONE I	AMP ON BATTERY BACK-UP	LIGHTOLIER	(DPA SERIES EQUAL)	3 MINIMUM SIZE OF CONDUIT TO BE 3/4". ALUMINUM CONDUITS SHALL NOT BE USED.	DISCREPANCIES FOUND BETWEEN THE INTENDED FUNCTION OF EQUIPMENT AND
<b>├</b>	H FLUORESCENT STRIP LIGHT FIXTURE	T-IE)		3) 32W COLUMBIA	P4D24-332G-MA36-EB8LHUNVEM (2EP3GX SERIES EQUAL)EM	4 USE RIGID STEEL SET SCREW TYPE FITTINGS ONLY. DIE CAST FITTINGS SHALL NOT BE USED.	EQUIPMENT SPECIFIED IN THE CONTRACT DOCUMENTS A MINIMUM OF TEN (10) WORKING DAYS PRIOR TO ISSUANCE OF THE FINAL BID. FAILURE TO REPORT
	EXTERIOR WALL MOUNTED FIXTURE WITH REMOTE EMERGENCY BATTERY BACK-UP			T8 METALUX LIGHTOLIER	(DPA SERIES EQUAL/ET)	(5) SUPPORT THE LAY-IN TYPE FIXTURES FROM THE CEILING DECK INDEPENDENT OF	ANY DISCREPANCY (CATALOG NUMBERS, DISCONTINUED ITEMS, ETC.) DOES NOT RELIEVE THE CONTRACTOR FROM PROVIDING EQUIPMENT WHICH SHALL
	WALL MOUNTED FIXTURE		FACE MOUNT WRAPAROUND	COLUMBIA	WC4-232-EB8LHI20	THE CEILING GRID, AS SHOWN ON THE TYPICAL RECESSED FIXTURE MOUNTING	CONFORM TO AND FULFILL THE INTENT OF THE CONTRACT DOCUMENTS. NOR
		LENS LIGHT FIXTURE	(2	2) 32W T8 DAYBRITE	(EQUAL)	DETAIL.	SHALL IT BE USED AS A CONDITION TO OBTAIN ADDITIONAL FUNDS FROM THE OWNER AFTER THE CONTRACT IS AWARDED. THE CONTRACTOR SHALL REQUEST
	NL FIXTURE WITH EMERGENCY BATTERY BACK-UP AND NIGHT LIGHT	-		METALUX	(EQUAL)	6 REFER TO THE MECHANICAL SHEETS FOR THE EXACT LOCATION OF THE MECHANICAL EQUIPMENT.	ALL CLARIFICATIONS OF CONTRACT DOCUMENT REQUIREMENTS IN WRITING TO THE ARCHITECT/ENGINEER A MINIMUM OF TEN (10) WORKING DAYS PRIOR TO
4	EXTERIOR LIGHT FIXTURE WITH INTEGRAL MOTION SENSOR	FLUORESCENT 4-0" WALI	_ MOUNTED VANITY LIGHT, ALLAST, OPAL ACRYLIC LENS (2	COLUMBIA	W4-232-EB8LHUNV		ISSUANCE OF THE FINAL ADDENDUM.
	EXIT LIGHT. ARROWS SHOW EXIT DIRECTION	THERMOPLASTIC END CA	APS, STEEL HOUSING.	T8 METALUX	(EQUAL)	ALL NEW WORK MUST MEET THE CURRENT ADOPTED NATIONAL ELECTRICAL CODE.	40 PROVIDE MACHINE PRINTED ADHESIVE LABELS FOR ALL DUPLEX OUTLETS AND
\$	SINGLE POLE TOGGLE SWITCH - 20 AMP	RECESSED FLUORESCENT		LIGHTOLIER	(EQUAL)	(8) NOT MORE THAN THREE (3) CIRCUITS, SHALL BE INSTALLED IN A ANY CONDUIT.	LIGHT SWITCHES TO INDICATE WHICH CIRCUIT THEY ARE TIED TO.
\$a,b	SINGLE POLE TOGGLE SWITCH - 20 AMP, LETTERS INDICATE SWITCH ASSIGNMENT	I OCATION APPROVED 6	O" APERATURÉ FLAT OPAL	I3 W PRESCOLITE QUAD HALO	CBX-I2O-HPF-TL3I (EQUAL)	EACH CIRCUIT SHALL CONSIST OF I CONDUCTOR FOR EACH PHASE, I NEUTRAL, AND I GROUND, FOR A TOTAL OF FIVE CONDUCTORS.	(1) INSTALL EXIT SIGNS ON THE WALL IF POSSIBLE.
\$7	THREE WAY TOGGLE SWITCH - 20 AMP	LEXAN LENS		BE C.F. LITHONIA	(EQUAL)		(2) CONTRACT DOCUMENTS SHALL TAKE PRECEDENCE OVER SHOP DRAWINGS
φ <sub>-</sub>		4' FLUORESCENT STRIP L	LIGHT WITH WIRE GUARD	COLUMBIA	CS4-232-EBHLHUNV-CSWG4	9 THE SIZE OF THE NEUTRAL CONDUCTORS SHALL BE NO. 10 AWG FOR ALL HOME RUNS WITH COMMON NEUTRAL (LIGHTING AND POWER CIRCUITS).	UNLESS SPECIFICALLY NOTETHE D OTHERWISE.
\$P	PILOT LIGHT TOGGLE SWITCH	T-5	(2	2) 32W METALUX	(EQUAL)		(43) SWITCHBOARDS, PANELBOARDS, AND MOTOR CONTROL CENTERS SHALL BE FIELD MARKED TO WARN QUALIFIED PERSONS OF POTENTIAL ELECTRIC ARC
	CEILING MOUNTED OCCUPANCY SENSOR - U = ULTRASONIC, I = INFRARED, DT = DUAL TECH.			LIGHTOLIER	(EQUAL)	UNLESS INDICATED OTHERWISE ON THE DRAWINGS.	FLASH HAZARDS. THE MARKING SHALL BE LOCATED SO AS TO BE CLEARLY
<b>∕</b> M\\\U,I,DT	WALL MOUNTED OCCUPANCY SENSOR - U = ULTRASONIC, I = INFRARED, DT = DUAL TECH.	EXTERIOR EMERGENCY IN PROFILE, PAINT TO MATC	NALL SCONCE, SMALL	GARDCO VISIONAIRE	IIIEMR-MT-42TRF-I20-9CBA-B84C SIL-T3-PL42-F-I-DL-9CBA-EM	1 (1) ALL PANELBOARDS SHALL HAVE FULL SIZE ISOLATED NEUTRAL AND GROUND	VISIBLE TO QUALIFIED PERSONS BEFORE EXAMINATION, ADJUSTMENT, SERVICING, OR MAINTENANCE OF THE EQUIPMENT. (NEC 110-16).
T	30 MINUTE, SPRING WOUND, WALL MOUNTED TIMER SWITCH	(T-6)   MOUNT REMOTE BALLAST	TIN INTERIOR OF BUILDING	RIPLE TITIMARK	PLIP-T-42-E-CBA-EM-IOTA I-420 (650 LUMEN) REMOTE	COPPER BUSSBARS.	(4) PROVIDE ENGRAVED THERMOPLASTIC TAGS FOR ALL PANELBOARD AND
(T-X),	LIGHTING FIXTURE CALLOUT. NUMBER INDICATES A SUGGESTED QUANTITY- TO BE VERIFIED	ON WALL AT HEIGHT AND DETERMINED BY ARCHITI	D LOCATION TO BE   1946 ECT. IIOO LUMEN BATTERY	BE C.F. HUBBELL PACE	TWSL-42TRF-SCBA-I20-GPCF-84S  AERW-I620-PLTA2-I20-WW-SCBA-WMPL-REMOTE BALLAST	① SUCCESSFUL BIDDER FOR THE PANELBOARDS, MAIN DISTRIBUTION PANEL, ETC., SHALL INCLUDE IN THEIR SUBMITTALS, A LAYOUT OF THE ELECTRICAL ROOM TO	EQUIPMENT DISCONNECTS. DISCONNECTS SHALL BE LABELED WITH EQUIPMENT DESIGNATION AND CIRCUIT BREAKER THEY ARE TIED TO.
$\stackrel{\sim}{\otimes}$	REFERENCE NOTE CALLOUT	PACK EXTERIOR WALL MOUNTE	D METAL HALIDE LIGHT		THOM LOOMED BY 120	SHOW THE ELECTRICAL GEAR FINAL LOCATIONS. (SCALE: 1/4" = 1'-0").	DESIGNATION AND CIRCUIT BREAKEN THET ARE TIED TO.
	NEI ENENOL NOTE CALLOUT	HI FIXTURE FULL CUTOFE 1		HUBBELL GARDCO	TWSM-100MH-DL-BK-120 (EQUAL)		
		1-7		MH VISIONAIRE	(EQUAL)	TO THOSE DETAILS WHETHER OR NOT CALLED IN REFERENCE NOTES.	
	POWER SYSTEMS SYMBOL LIST	NOT USED				(4) ALL J-BOXES SHALL HAVE MINIMUM DEPTH OF 2-1/8" UNLESS OTHERWISE	
SYMBOL	DESCRIPTION	T-8				SPECIFIED. SECURE ALL J-BOXES AS SHOWN IN THE DETAILS. FURNISH AND INSTALL PROPER MUD RINGS.	
$\Box$	DUPLEX CONVENIENCE OUTLET - 20 AMP		FIXTURE WITH PERFORATED	ALERA	CV-2T5HO-PERF-CMXX-EB5LHI2O-MW-XX-SCE-IB/OB-DC	(15) ALL METALLIC CONDUITS, JOINTS, FITTINGS, ETC., IN CONTACT WITH THE GROUND	
	DUPLEX CONVENIENCE OUTLET - 20 AMP GROUND FAULT INTERRUPTER		PE WITH CAST ALLIMINUM END 1 (2	2) 54W FINELITE T5HO LIGHTOLIER	912-P-XX-2T5HO-DC-9IW-12O-FA-CE-DUST COVER LSC-2-X-B-54-I-WH-DC	SHALL BE SPIRALLY WRAPPED WITH 3M SCOTCHRAP-51, 20 MIL TAPE (OR APPROVED EQUAL). 1/2" OVERLAP IS REQUIRED.	
<u></u>		T	QUANTITIES AS SHOWN ON   '	WIDE METALUMEN	CTS-B-R-C-A-4-W-6-A		
Ψ 	TWIST-LOCK RECEPTACLE	AIRCRAFT CABLE SUSPE		CORELITE	IP-WP-2T5-2C-I2O-ACXX-XX-DC	(16) ALL CONDUITS EXPOSED TO THE WEATHER SHALL BE GALVANIZED RIGID STEEL, UNLESS OTHERWISE NOTED.	
<b>+</b>	4-PLEX CONVENIENCE OUTLET - 20 AMP	CLEAR TOP DUST COVEF	R, MATTE WHITE, CONTINUOUS			(17) ALL EXPOSED CONDUIT MUST RUN AGAINST THE WALLS OR CEILINGS. DO NOT	
	SPECIAL PURPOSE SINGLE PHASE OUTLET					PENDANT MOUNT ANY CONDUIT FROM THE CEILINGS.	
	POWER / COMMUNICATIONS POLE	LED EXIT SIGN, WHITE WITHERMOPLASTIC HOUSING	S NICAD BATTERY BACK-UP	DUALLITE	LXUGWE	18 ALL THE HOMERUNS MUST BE ACCESSIBLE IN THE CEILING PLENUM. DO NOT	
<u> </u>	JUNCTION BOX - SIZE AND FUNCTION AS REQUIRED	EX-I UNIVERSAL MOUNT.	INC	CLUDED SURELITES	(EQUAL)	CARRY A HOMERUN FROM ONE DEVICE TO ANOTHER WHICH IS TIED TO A SEPARATE HOMERUN INSIDE THE WALL. MARK ON ALL THE J-BOXES THE CIRCUIT	· · · · · · · · · · · · · · · · · · ·
	CONDUITS CONCEALED IN FLOOR OR BELOW GRADE	NOTES:		LIGHTOLIER	(EQUAL)	NAMES AND NUMBERS. USE NO. 10 THHN CONDUCTORS FOR CONDUCTOR  LENGTH OVER 100 FEET, NO. 8 THHN OVER 200 FEET, NO. 6 THHN OVER 300	· · · · · · · · · · · · · · · · · · ·
	CONDUITS CONCEALED IN CEILING AND WALLS	I. ALL FLUORESCENT LIGH		OGRAMMABLE START BALLAST'S, 10%, T		FEET AND NO. 4 THHN OVER 400 FEET LENGTH.	
		UNIVERSAL, ADVANCE AN	ND HOWARD ARE APPROVED MANI	WFACTURERS. BALLAST'S TO HAVE 5 Y	EAR WARRANTY.	19 PAINT ALL THE J-BOXES FOR FIRE ALARM SYSTEM WITH RED PAINT. MARK ALL	· · · · · · · · · · · · · · · · · · ·
	ARROWS INDICATE HOME RUNS - LINES INDICATE NUMBER CONDUCTORS	2. ALL FLUORESCENT LAN	1PS SHALL HAVE COLOR TEMPER	ATURE, AS SELECTED BY THE OWNER.		THE CONDUIT FOR FIRE ALARM SYSTEM EVERY 8' WITH RED STRIPE.	· · · · · · · · · · · · · · · · · · ·
- 📗 🖳	FUSED DISCONNECT SWITCH - SIZE AS REQUIRED	3. FIELD VERIFY ALL LIG	HTING VOLTAGES PRIOR TO PLAC	CING ANY ORDER.		② THE FIRST 10' LENGTH OF ALL BURIED CONDUIT OVER 1" SHALL BE RIGID GALVANIZED STEEL WHERE THEY ARE LEAVING OR ENTERING THE BUILDING,	
	COMBINATION STARTER/FUSED DISCONNECT SWITCH - SIZE AS REQUIRED	4. THE WRITTEN CRITERIA	A OF THE FIXTURE DESCRIPTION T	TAKES PRECEDENCE OVER THE CATALO	OG NUMBER.	MANHOLE, VAULT, ETC.	
(5)	MOTOR LOCATION	5. ALL MRIG LAMPS SHAL	L HAVE BOTTOM LENS AND BE RA	ATED AT 10,000 HOURS.		(2) ALL UNDERGROUND CONDUIT SHALL BE BURIED 24" MINIMUM UNDER THE	
<del></del>	MANUAL DISCONNECT WITH THERMAL OVERLOAD PROTECTION			,		GROUND. PUT METALLIC YELLOW WARNING TAPE ABOVE ALL UNDERGROUND CONDUIT.	
	ELECTRICAL PANEL LOCATION	1					
		4				(2) COORDINATE WITH THE ARCHITECT FOR THE EXACT LOCATION OF THE OUTLETS.	
	ELECTRICAL METER LOCATION	4				(3) LIGHT SWITCHES INSTALLED ADJACENT TO EACH OTHER, SHALL BE GANGED TOGETHER WITH ONE PIECE COVERPLATE.	
W.P.	INDICATES WEATHER PROOF EQUIPMENT					(4) USE EPOXY ANCHORS TO SUPPORT THE ELECTRICAL EQUIPMENT. EXPANSION	
А	INDICATES DEVICE IS ABOVE COUNTER TOP					ANCHOR BOLTS ARE NOT ACCEPTED.	
CLG	INDICATES CEILGING MOUNTED DEVICE					(25) AT THE END OF THE JOB, PROVIDE BLANK COVER PLATES TO MATCH THE	
3 ××-1	MECHANICAL EQUIPMENT CALLOUT	1				OTHER COVER PLATES FOR ALL J-BOXES WHERE DEVICES HAVE NOT YET BEEN INSTALLED.	
$\otimes$	REFERENCE NOTE CALLOUT	1					
		+				② SEAL AROUND ALL CONDUIT PENETRATIONS THROUGH FIRE RATED WALLS AND CEILINGS WITH FIRE RATED MATERIAL. 3M IS AN APPROVED MANUFACTURER.	
Ď	FLUSH FLOOR OUTLET WITH COMMUNICATIONS OUTLET	-				② ALL DISCONNECTS, J-BOXES AND CONDUITS EXPOSED TO THE OUTSIDE WEATHER	
	MMUNICATION SYSTEMS SYMBOL LIST					SHALL BE NON-CORROSIVE, WEATHER PROOF TYPE.	
SYMBOL	DESCRIPTION					28 ALL DISCONNECTS SHALL BE HEAVY DUTY TYPE.	
	TELEPHONE TERMINAL BOARD					② ALL MATERIALS USED IN THIS INSTALLATION SHALL BE U.L. APPROVED AND NEW.	
$\triangle$	FLUSH VOICE / DATA OUTLET					(3) ALL ELECTRICAL WIRING MUST BE IN CONDUIT (ROMEX AND MC CABLE ARE NOT	
	INDICATES DEVICE IS ABOVE COUNTER TOP	1				PERMITTED).	
		-				3) FLEXIBLE CONDUITS CAN ONLY BE USED FOR SHORT RUNS (6' MAXIMUM).	
_ 🔆	REFERENCE NOTE CALLOUT	4				③ NO CONDUITS SHALL RUN IN DUCT WORK.	
]	FIRE ALARM SYSTEM SYMBOL LIST					TEMPORARY ELECTRICAL SERVICE IS TO BE PROVIDED BY THE ELECTRICAL	
SYMB <i>O</i> l	DESCRIPTION					CONTRACTOR AND REMOVED BY THE ELECTRICAL CONTRACTOR.	
[ZZZZ]	ELECTRICAL PANEL LOCATION					34) PRIOR TO SUBMITTING A BID THE ELECTRICAL CONTRACTOR SHALL INSPECT	
(SD)	FIRE ALARM PHOTOELECTRIC SMOKE DETECTOR	1				THE SITE AND INCLUDE IN HIS BID PACKAGE ALL CHARGES DUE TO EXISTING CONDITIONS. SHOP DRAWINGS ARE REQUIRED. ALL LABOR, MATERIAL AND	
<u> </u>	FIRE ALARM PHOTOELECTRIC DUCT DETECTOR	-				WORKMANSHIP SHALL BE GUARANTEED FOR A PERIOD OF I YEAR FROM THE DATE OF ACCEPTANCE BY THE TENANT. REPLACE OR REPAIR ALL DEFECTS	
F		-				DURING THE GUARANTEED PERIOD.	
	FIRE ALARM MANUAL PULL STATION	-				35 THE ELECTRICAL CONTRACTOR SHALL TERMINATE THE ELECTRICAL	
H)	FIRE ALARM HORN WITH STROBE HIGH DECIBEL	_				CONNECTIONS TO ALL THE EQUIPMENT BY PROVIDING THE NECESSARY MALE/FEMALE CONNECTOR, RECEPTACLE, PLUG, ETC.	
H	FIRE ALARM HORN HIGH DECIBEL					36 ALL DUPLEX OUTLETS AND SWITCHES SHALL BE 20 AMP., 120 VOLT SPEC	
	A.D.A. STROBE FOR FIRE ALARM					GRADE. HUBBELL AND PASS & SEYMOUR AND LEVITON ARE APPROVED	
A FS	FIRE SPRINKLER FLOW SWITCH					MANUFACTURERS.	
TS	FIRE SPRINKLER TEMPER SWITCH	1				THE ELECTRICAL CONTRACTOR SHALL NOTIFY AND COORDINATE WITH THE MECHANICAL CONTRACTOR SO THAT NO PIPING, DUCTS, OR OTHER EQUIPMENT	
FSD		+				SHALL BE INSTALLED IN ENTRY OR PASS THROUGH ELECTRICAL ROOM OR SPACES ABOVE OR BELOW ELECTRICAL PANELS.	
	FIRE/SMOKE DAMPER	-				SI AGES ADO VE OIN DELOM ELECTRICAL I ANELS.	
RM	FIRE ALARM RELAY	-					
F.A.C.P.	FIRE ALARM CONTROL PANEL					<u> </u>	
F.A.R.A.P.	FIRE ALARM REMOTE ANNUNCIATOR PANEL						
⊗	REFERENCE NOTE CALLOUT						
<u> </u>	1	2			3	$\Delta$	5
	1	<u> </u>			J	т 	J

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BUILDING NAME:

## **UTAH NATIONAL GUARD**

PROJECT TITLE:

BUILDING #2

## B CAMP WILLIAMS DRAPER, UT MARK DATE DESCRIPTION

	5/17/05	ADDENDA #1
2	5/19/05	ADDENDA #2
3	6/3/05	ADDENDA #3

ISSUE TYPE: STATE REVIEW SET

ISSUE DATE: APRIL 21, 2005

DFCM PROJECT NO: 05006480

CAD PROJECT NO: 0516 CAD DWG FILE:

DRAWN BY: KS


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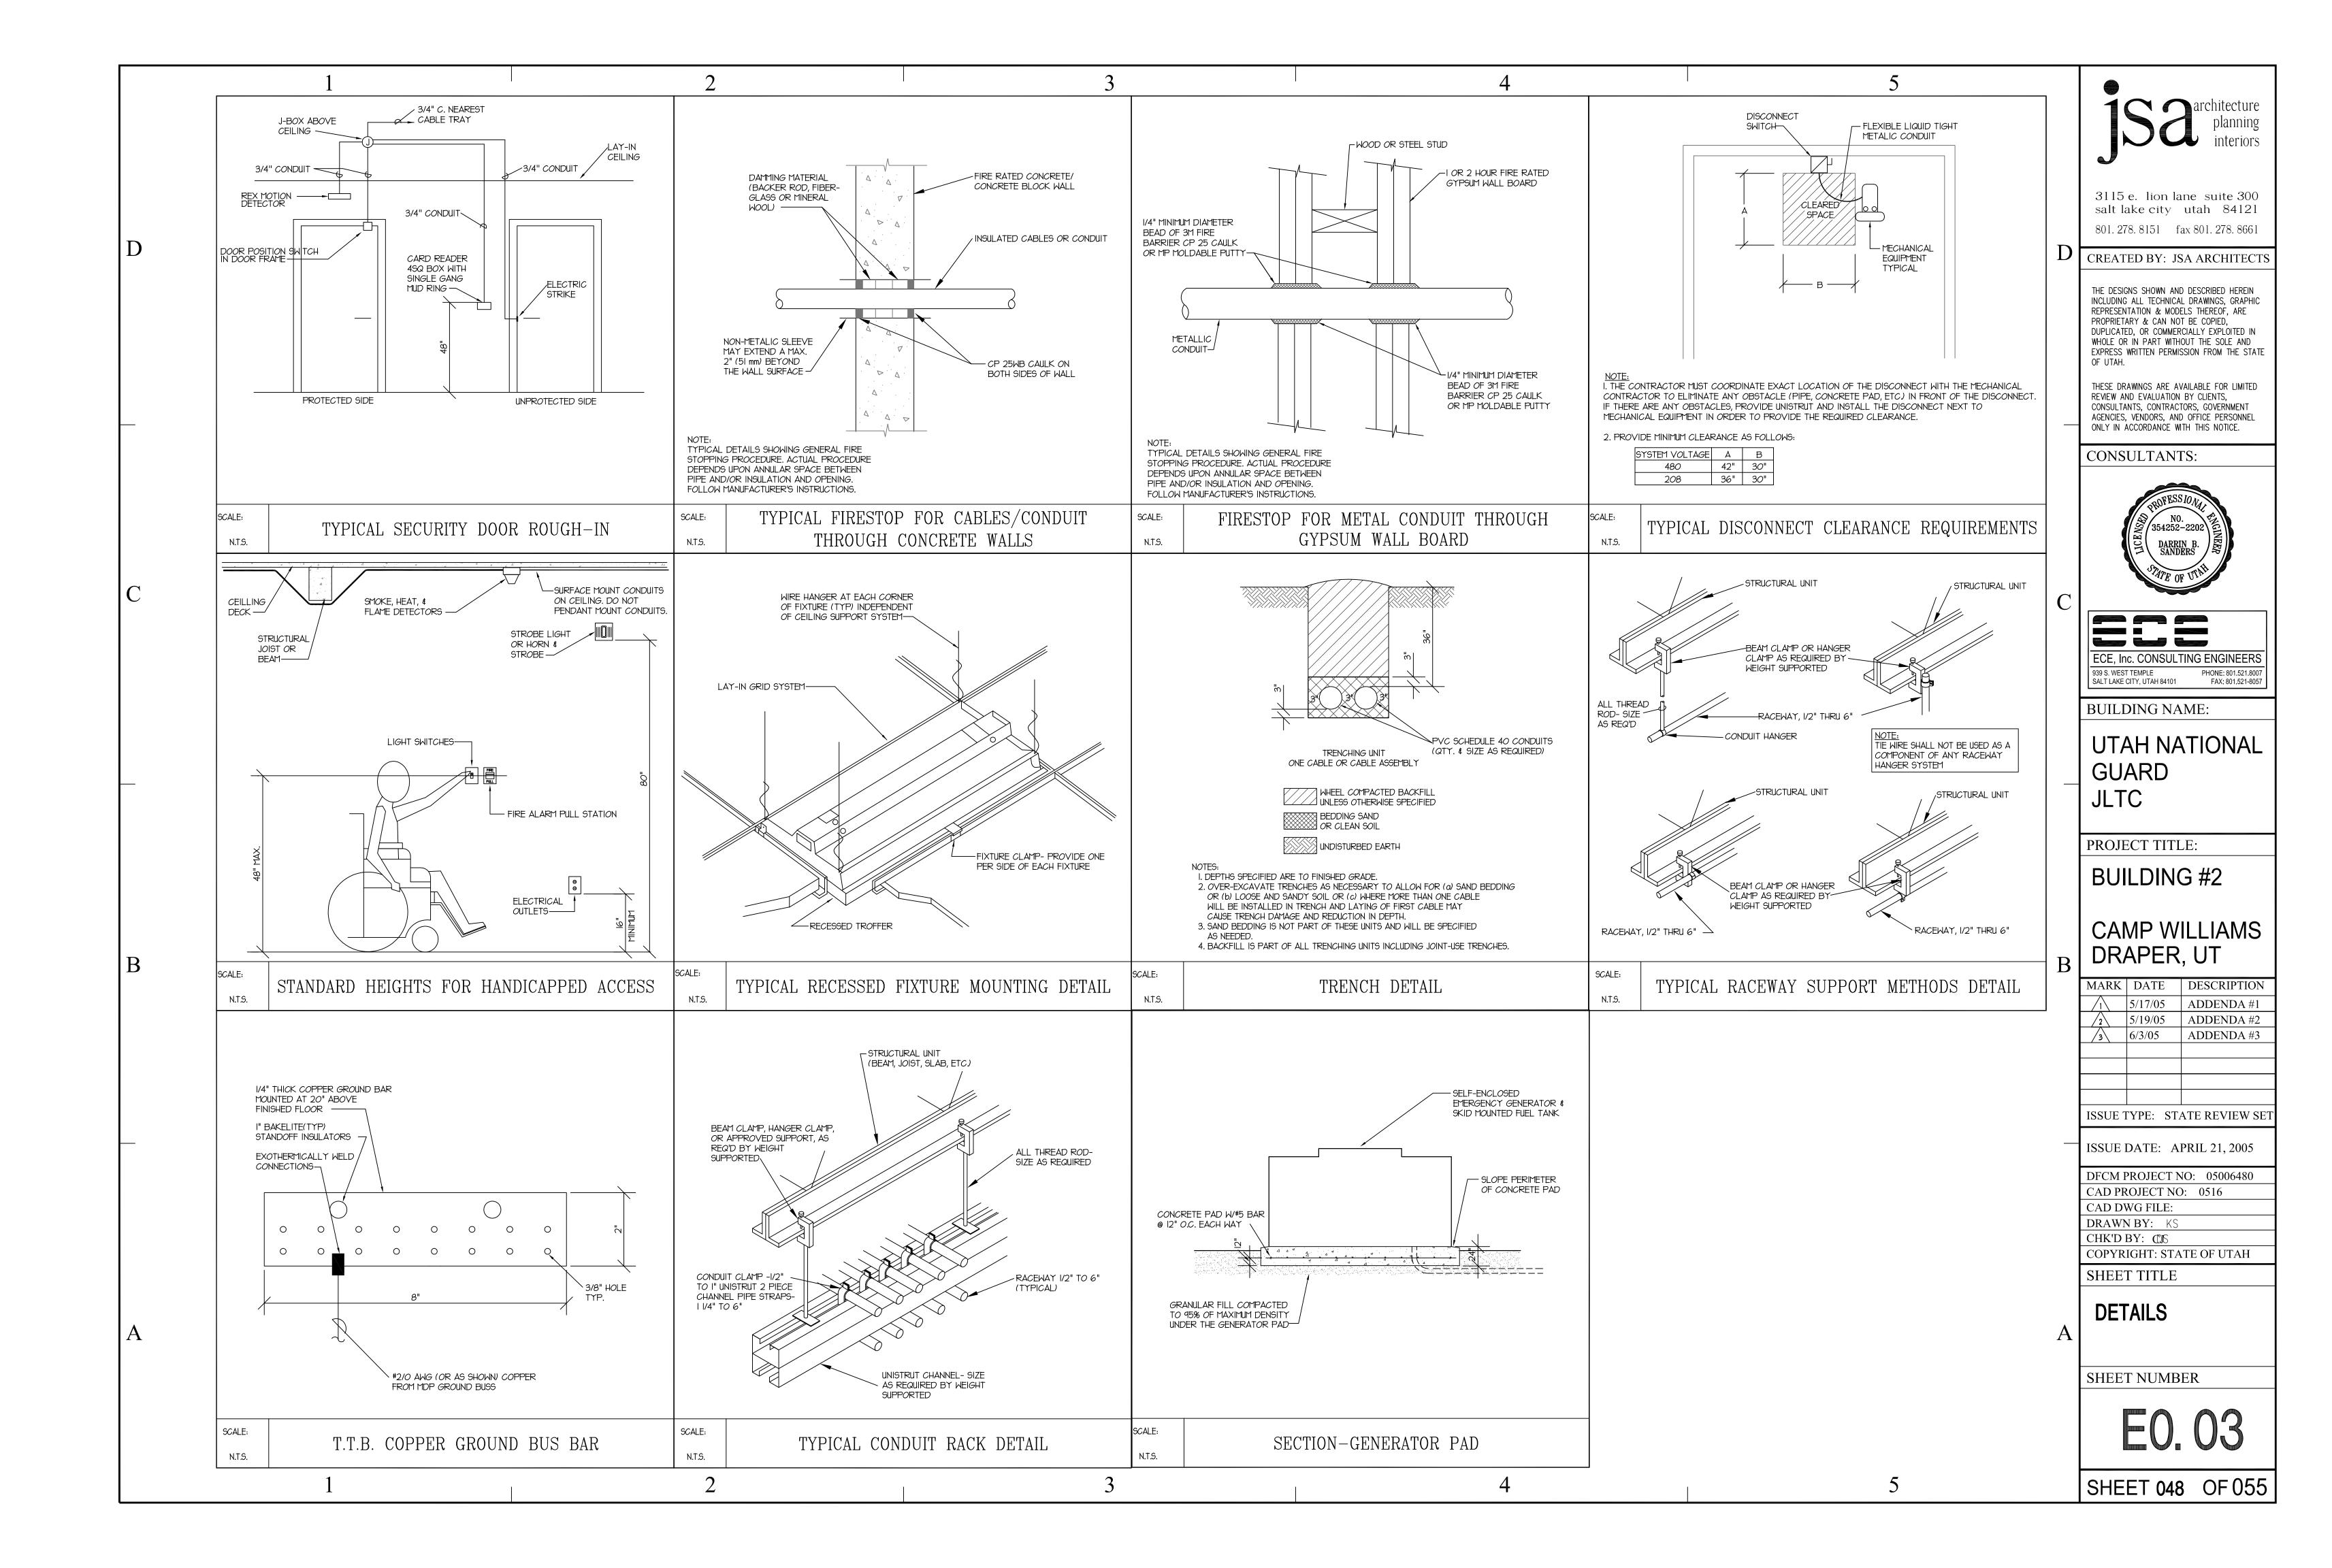
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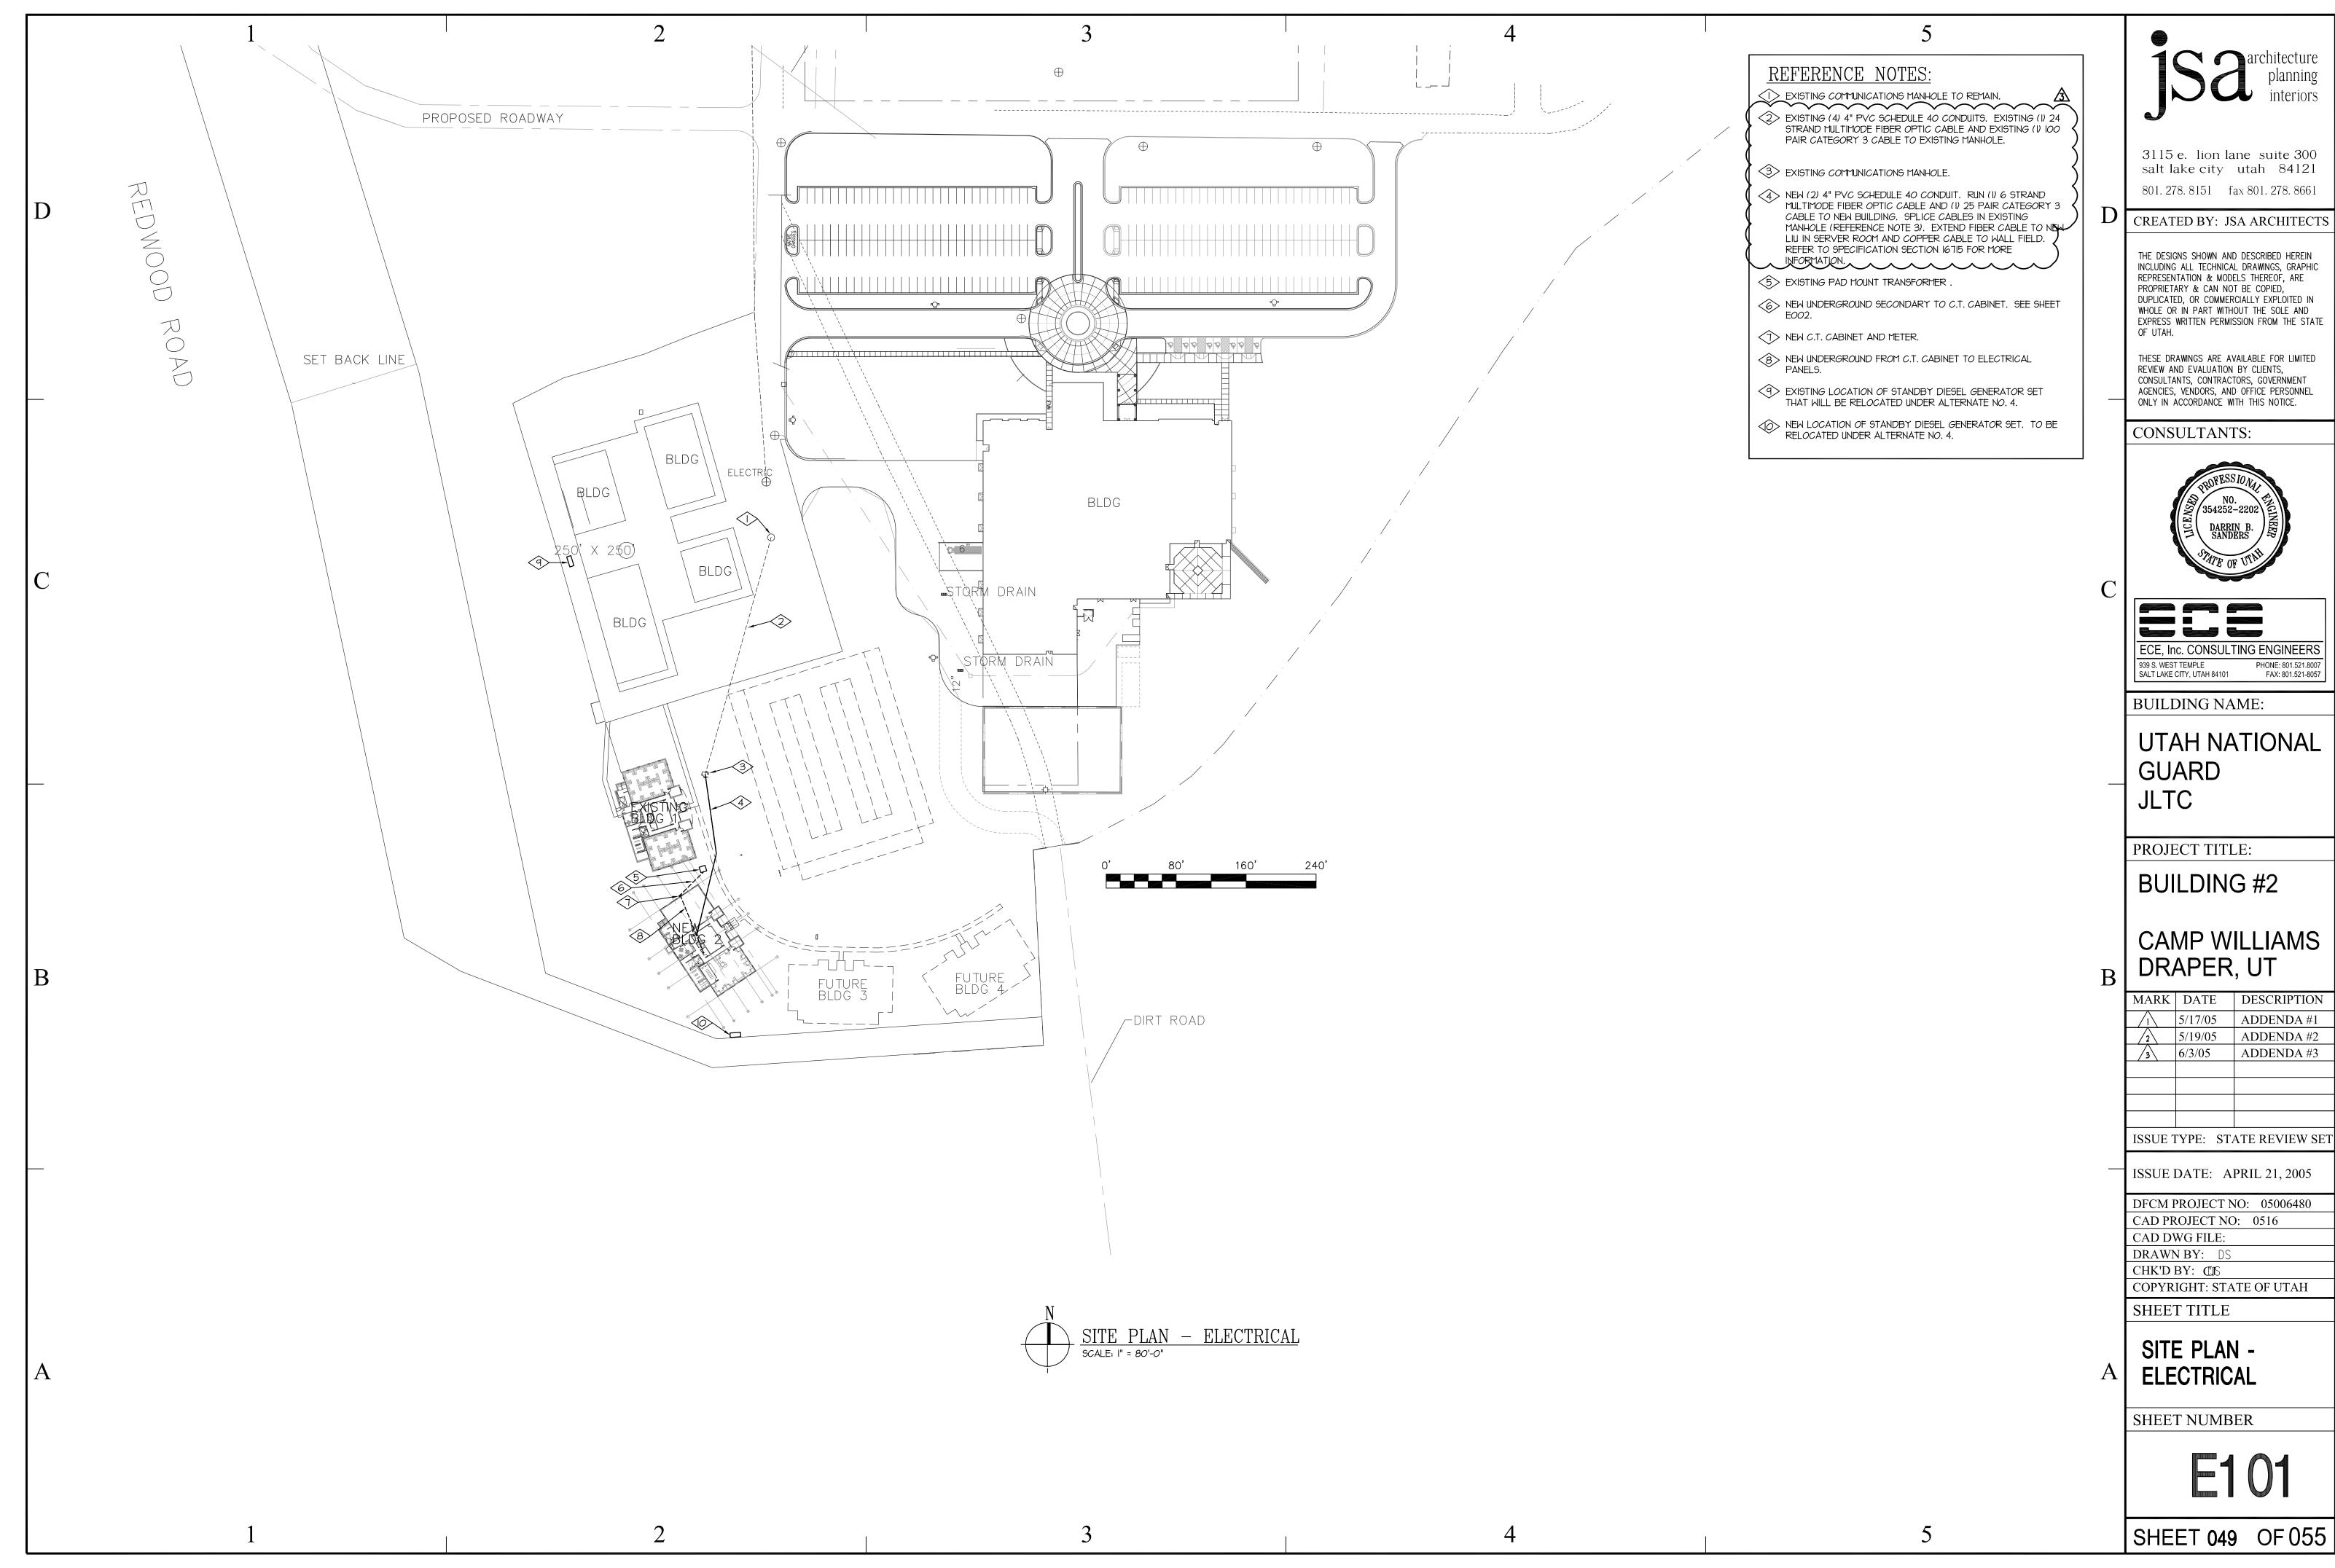
**NOTES AND SCHEDUALS** 


SHEET NUMBER

SHEET 046 OF 055







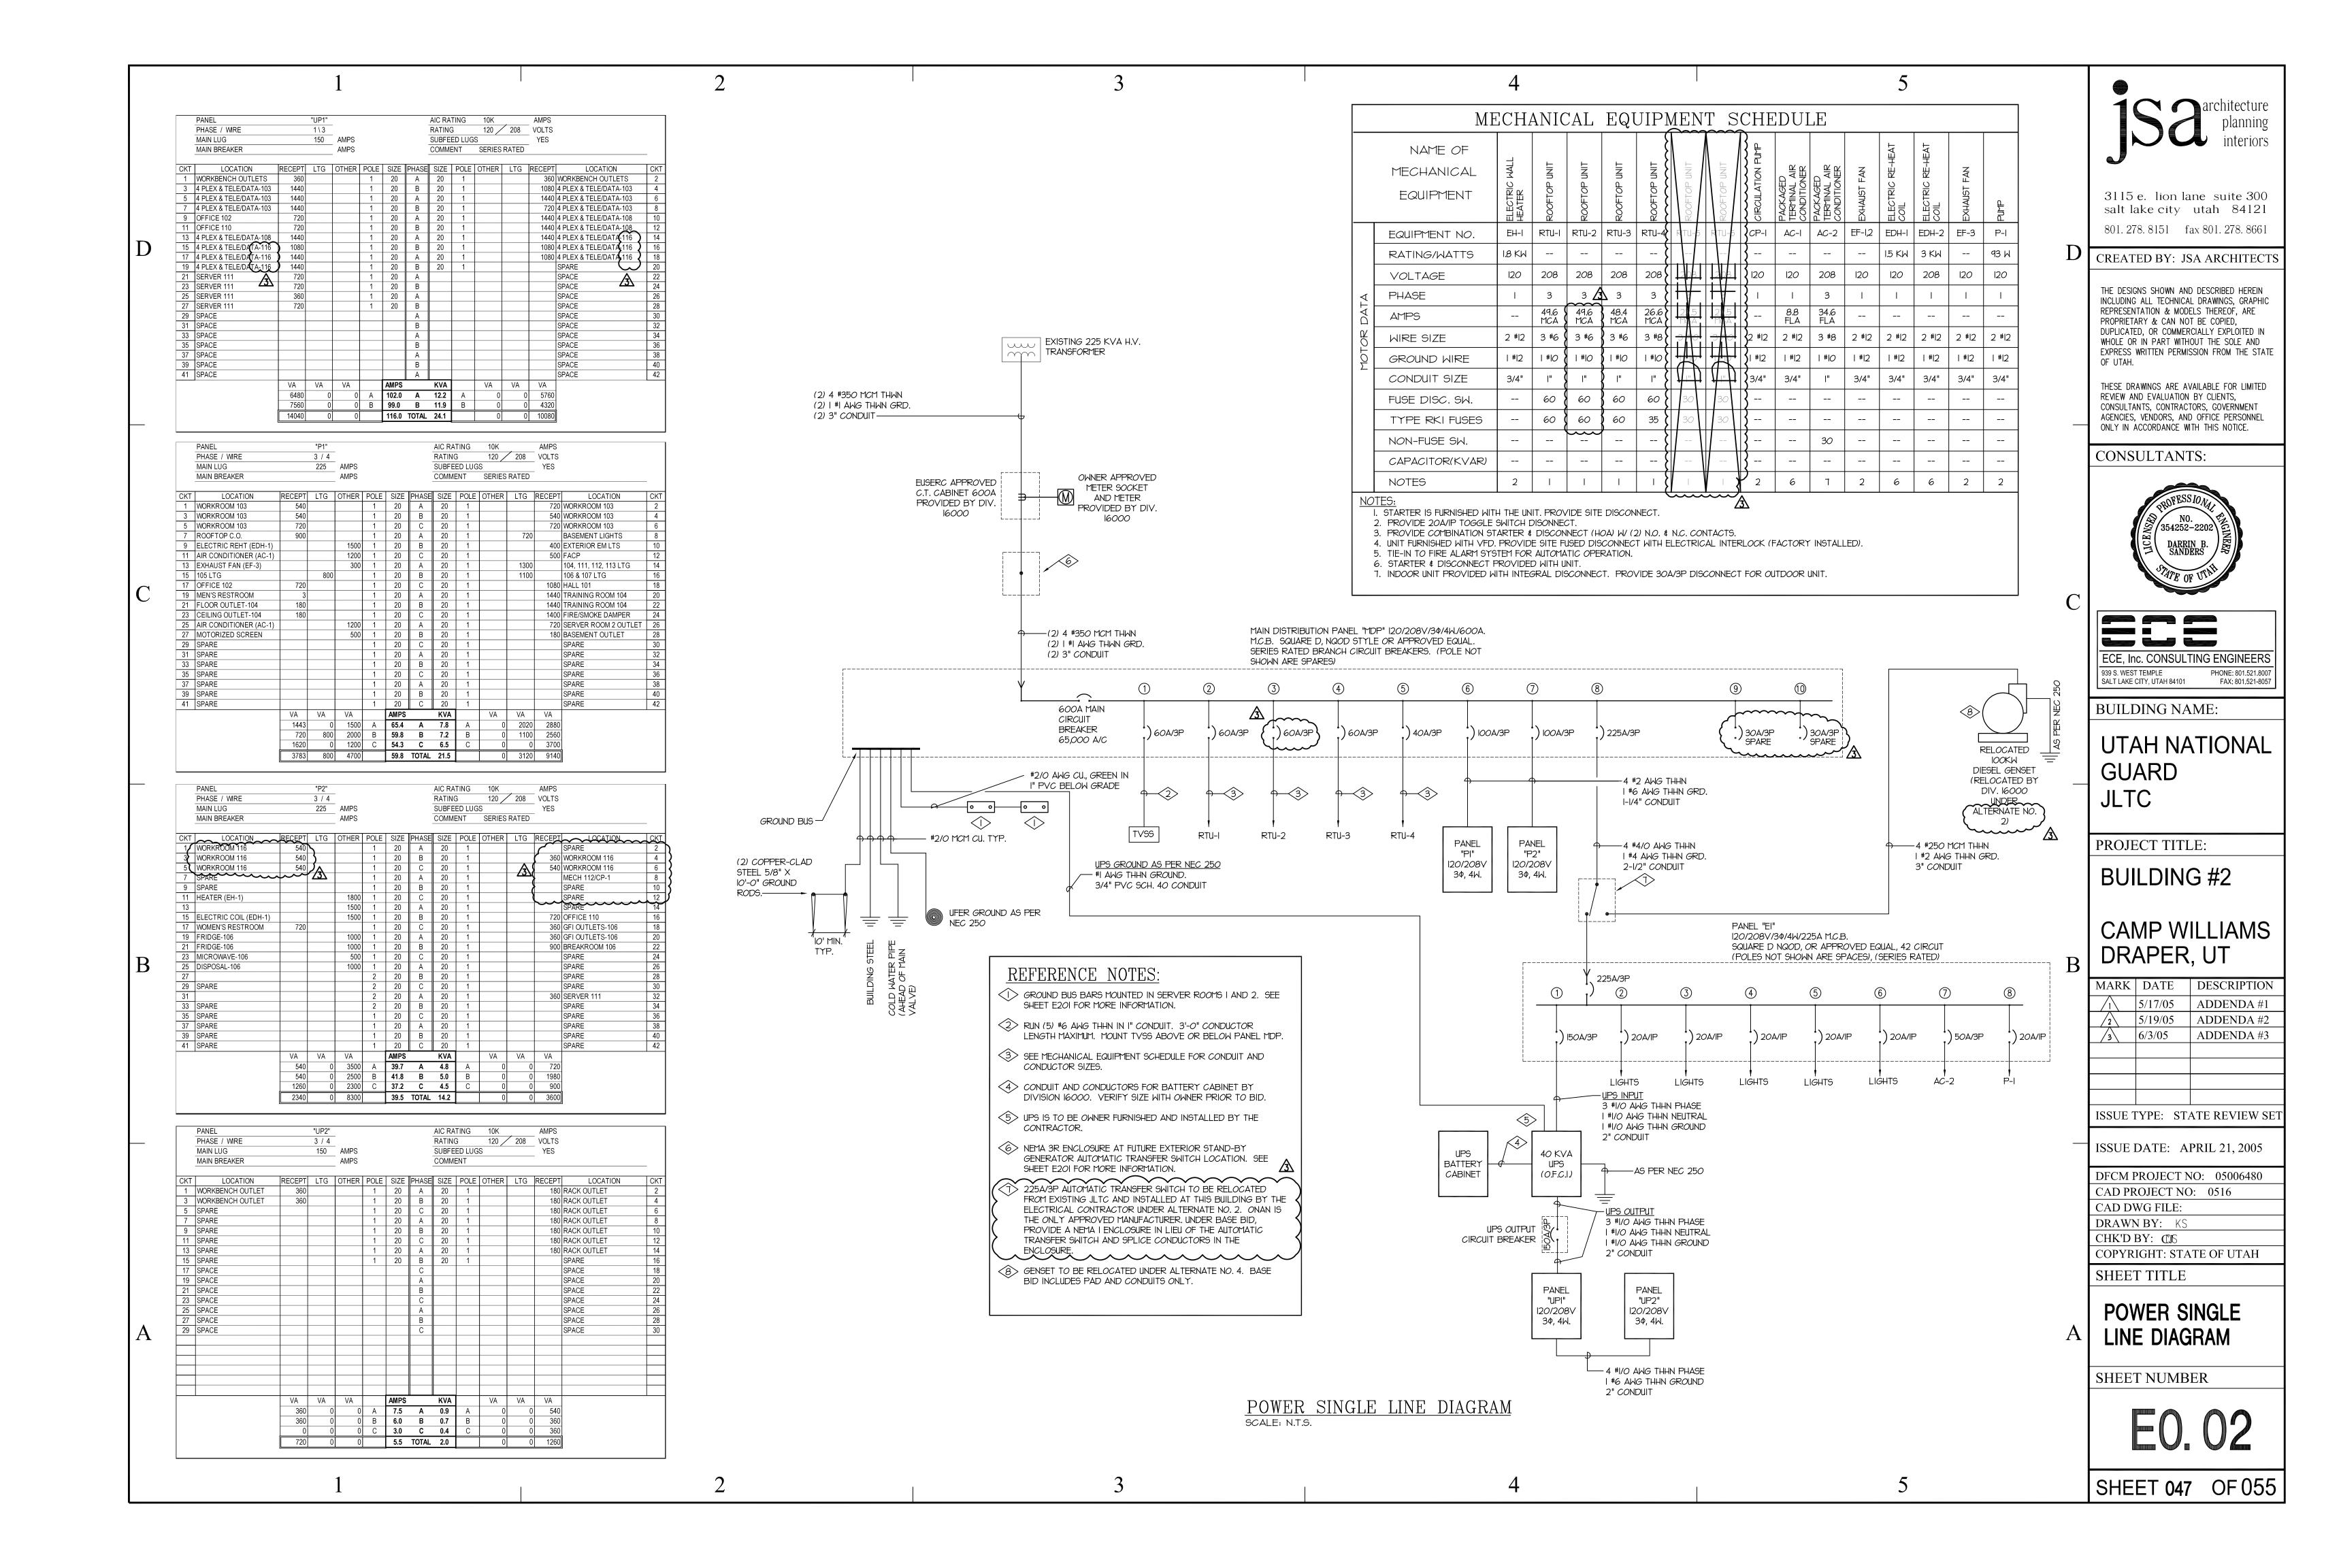

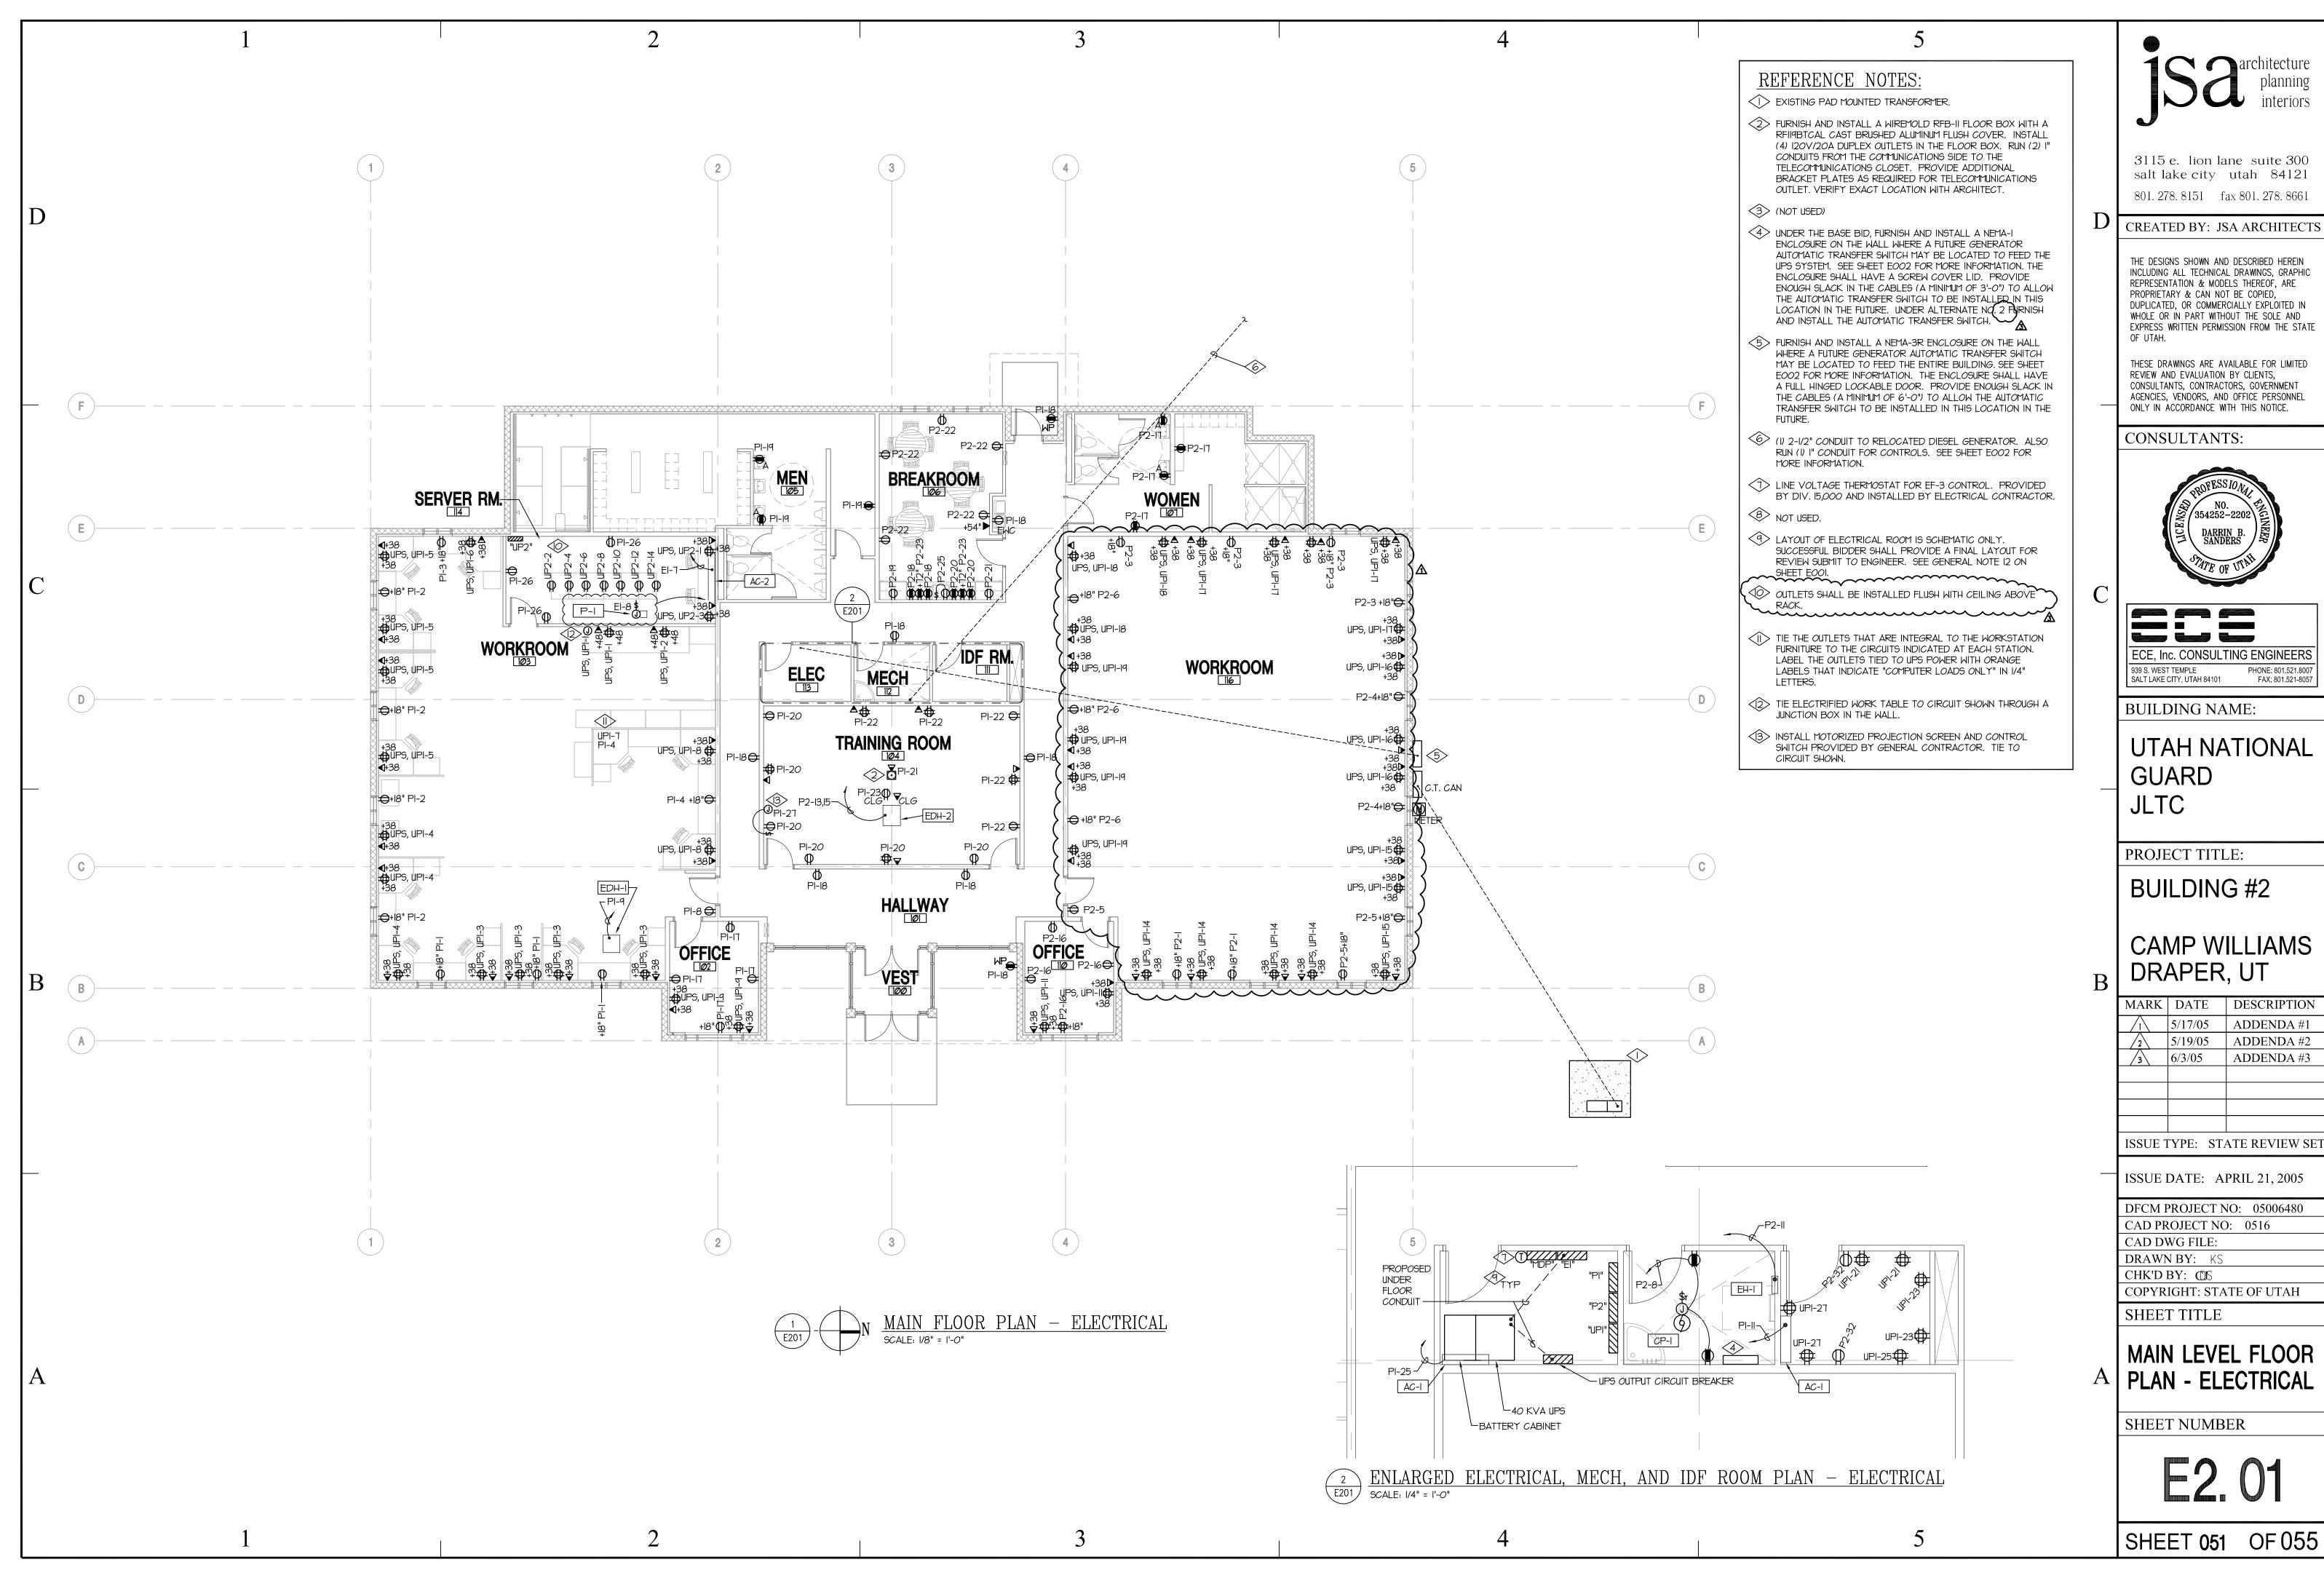

MARK	DATE	DESCRIPTION
$\overline{}$	5/17/05	ADDENDA #1
$\sqrt{2}$	5/19/05	ADDENDA #2
3	6/3/05	ADDENDA #3

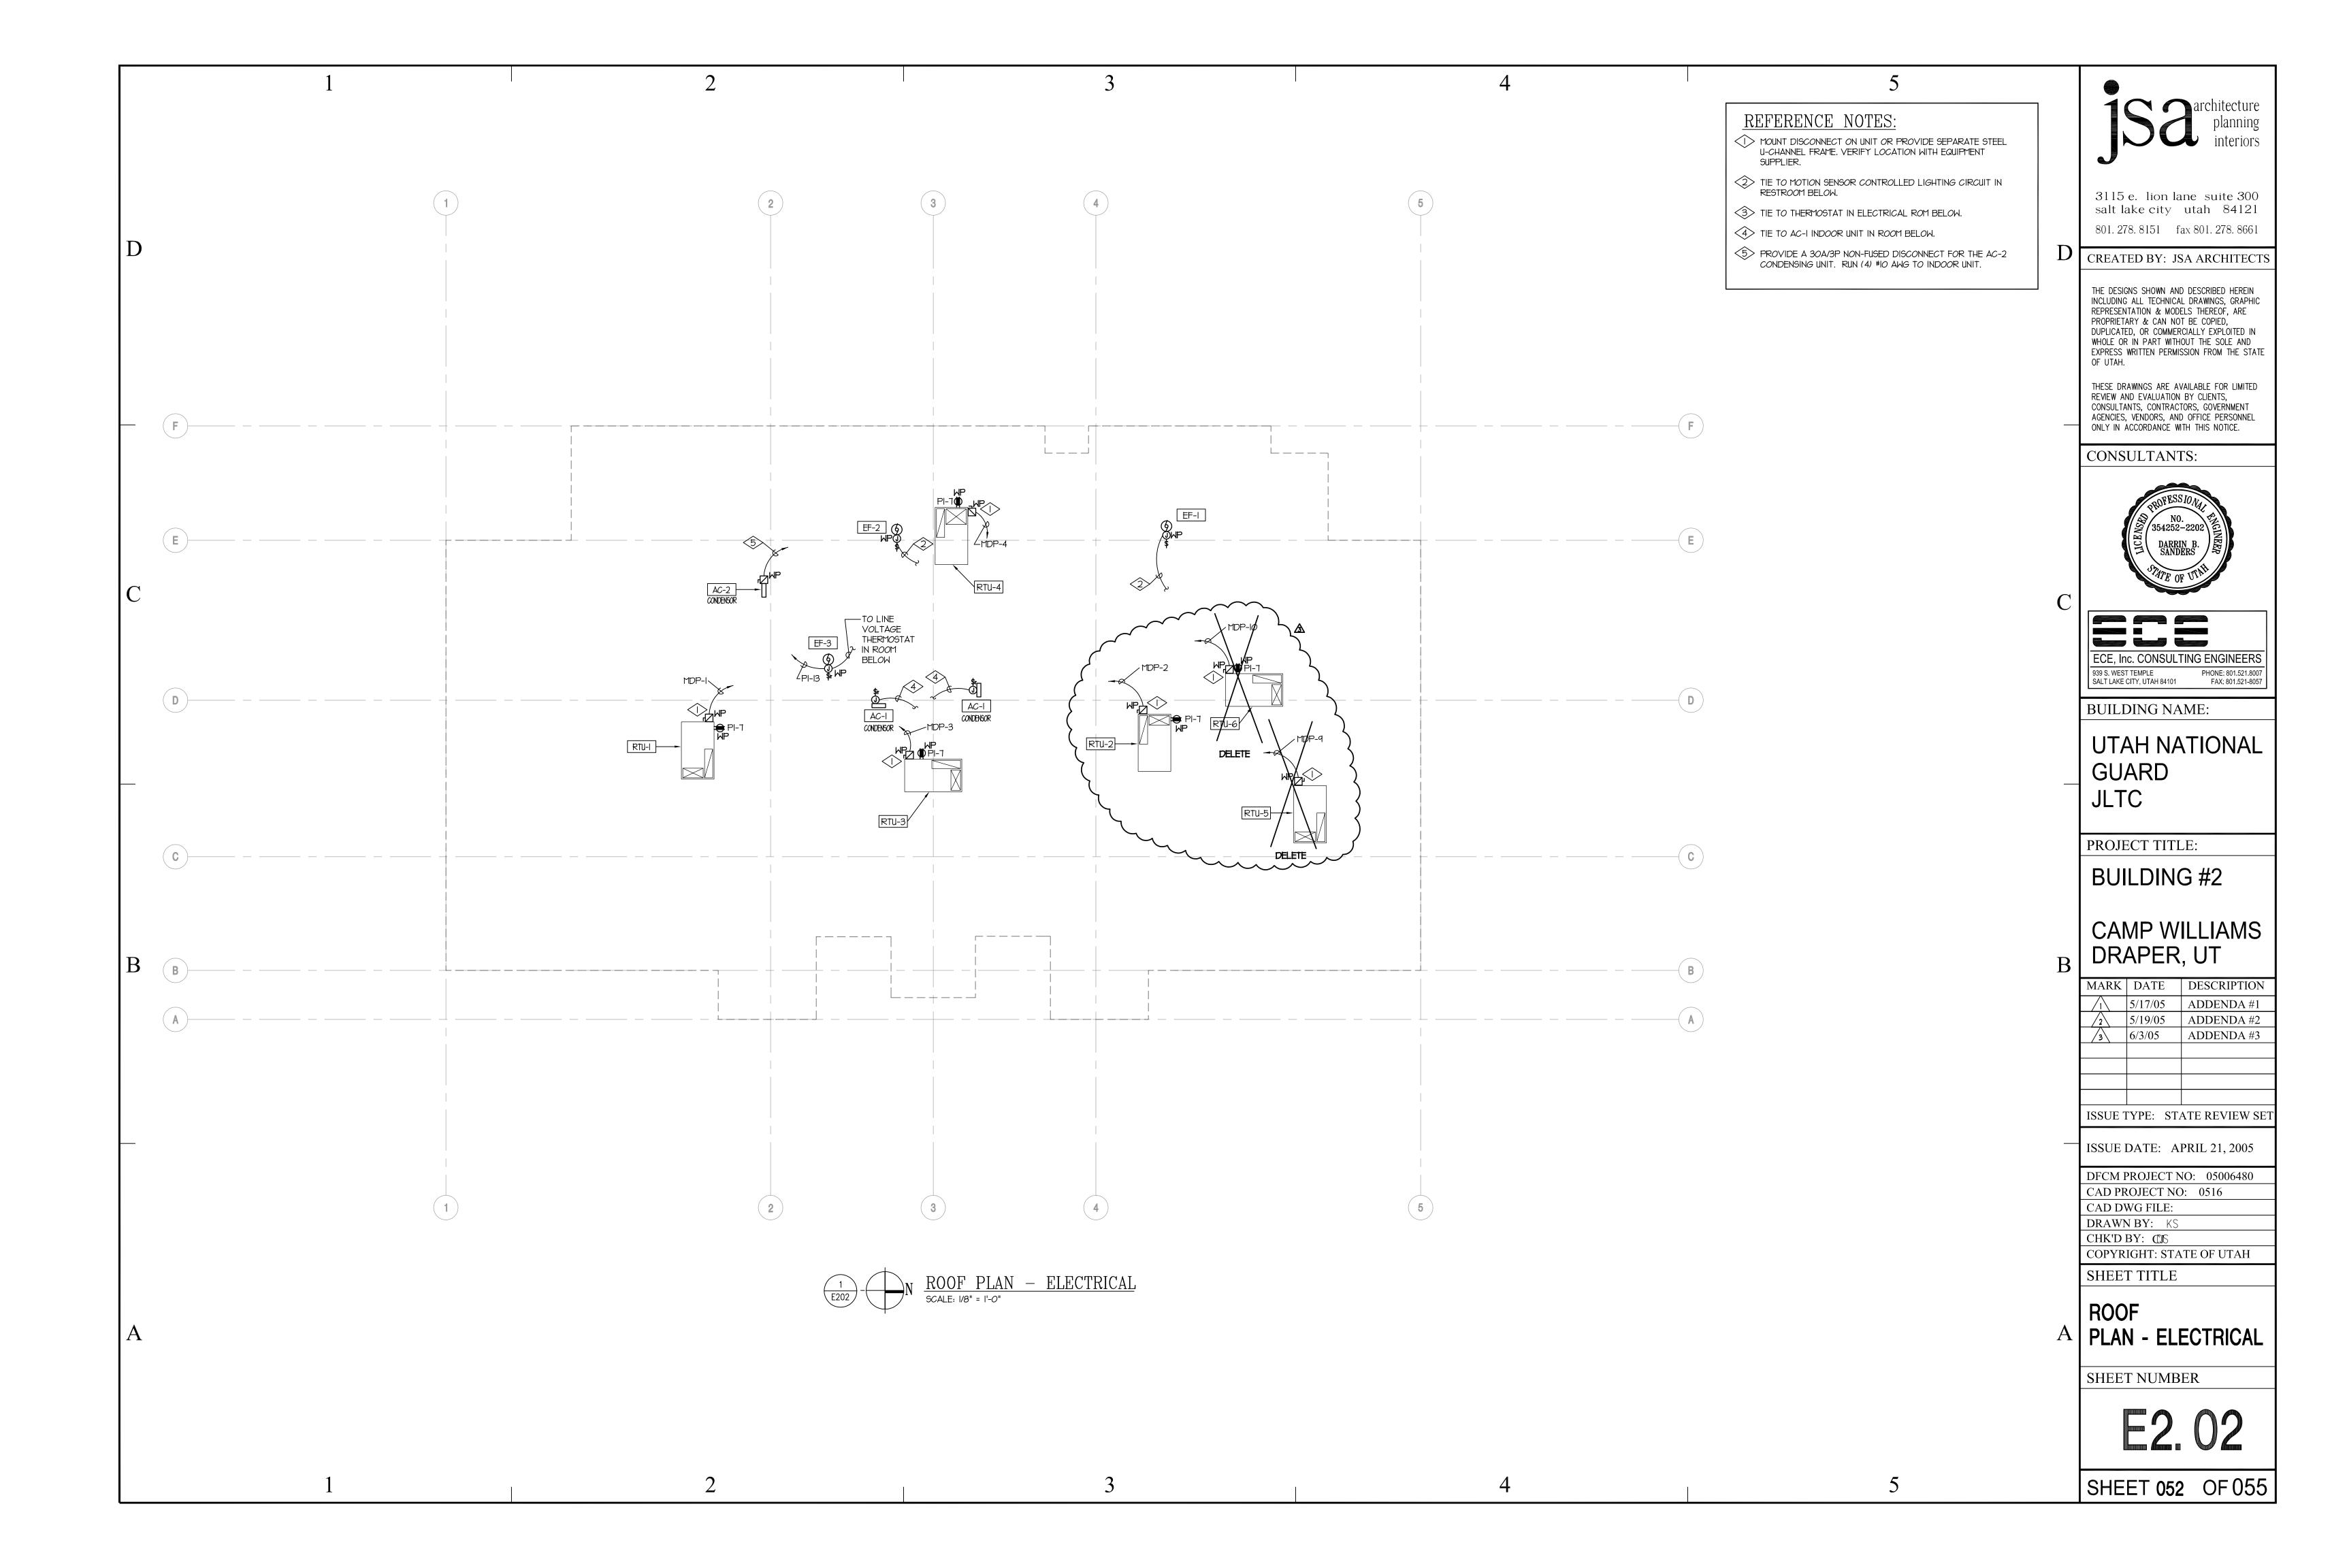

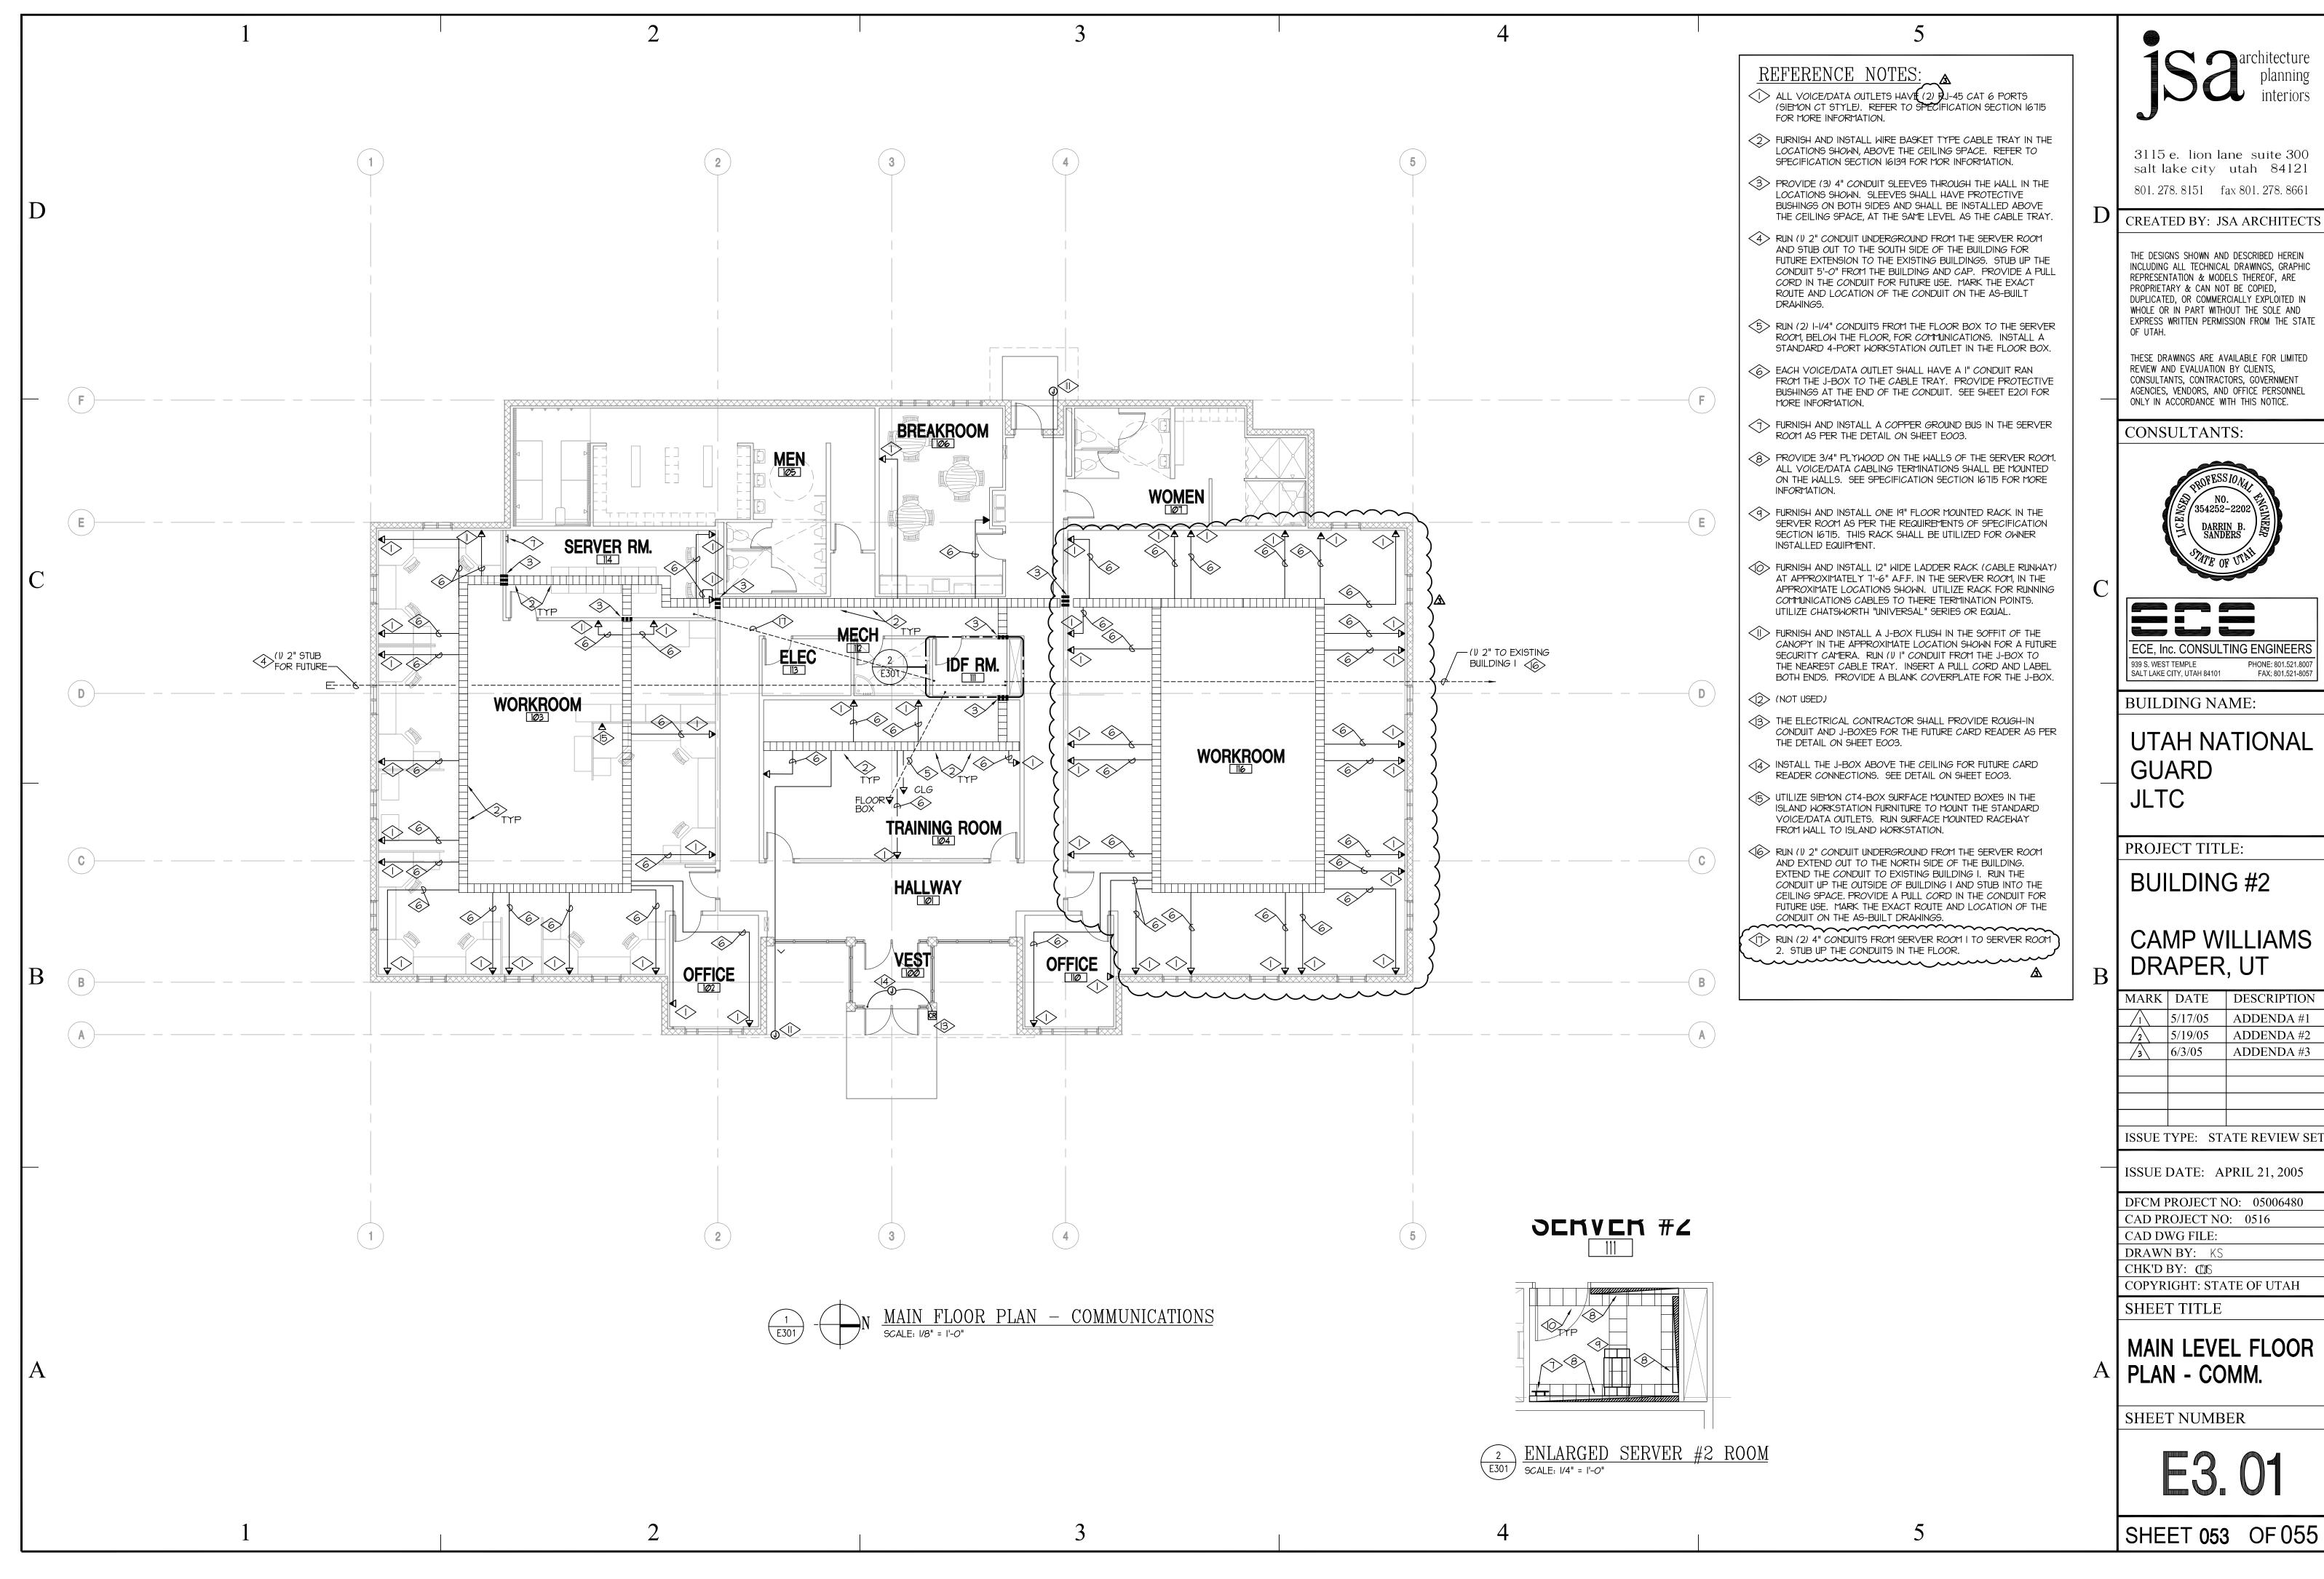

MARK	DATE	DESCRIPTION		
	5/17/05	ADDENDA #1		
2	5/19/05	ADDENDA #2		
3	6/3/05	ADDENDA #3		
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